## FACILITY DESIGN PLAN

### **Devereaux Library Renovation**

### SOUTH DAKOTA MINES

### Introduction:

South Dakota Mines requests approval of the Facility Design Plan for the Renovation of the Devereaux Library. The Preliminary Facility Statement and Facility Program Plan were approved at the Board's December 2019 meeting. The Building Committee met on November 17<sup>th</sup> and approved the Facility Design Plan. The estimated cost of the project is \$5.85M which has increased from the Facility Program Plan. The main causes of the increase in costs are the additional work to the library floor (now only on one floor), elevator shaft, and further refinement of the mechanical/electrical/plumbing design. A small addition to the building was approved during the 2020 session with HB1046. However, after further design work, it was determined that the current location of the elevator could be modified to best use space and the walls of the building could be opened to provide more natural light to improve the overall building which was the intent of the addition. There are also recently addressed drainage issues around the building that will not have to be changed.

The Devereaux Library is a 57,615 square foot building constructed in 1970. The garden level of the building was renovated in 2016 to house the Department of Industrial Engineering and the third floor was renovated in 2004 for use by the library. Major updates are necessary on the first and second floors to bring the building up to modern standards, meet ADA requirements, and complete needed maintenance/repair. The third floor also needs updates to lighting and architectural for the library operation. The programmatic emphasis of this building will change based on best practices in higher education for library spaces. The building will be transformed into a student hub to provide centralized services for student success (i.e. testing, tutoring, mentoring, IT help desk, and career and professional services), along with the much-needed library services. With the library space located only on the top floor of the building, space was available for a math lab and makerspace on the 2<sup>nd</sup> floor to further enhance the student success is anticipated to help improve enrollment, retention, and graduation rates.

### a. Architectural, mechanical, and electrical schematic design:

The renovation will take place within the current Devereaux Library. The Devereaux Library is located on the central north side of the South Dakota Mines campus in Rapid City, South Dakota. Schematic drawings prepared by Strang and CO-OP Architecture showing site plans, floor plans, elevations and renderings are attached.

### b. Changes from facility program plan:

There will no longer be an addition for the elevator for the project to best use space. The elevator location will be left in place, but the shaft will have to be increased to meet ADA requirements. The structural architect determined that the walls could be opened to bring additional natural light into the building instead of the addition. The library portion of the building will exist on the top floor only, which is a change from the program plan. A math lab and maker space have been added to the second floor with this change.

The project will also request to pursue an exemption from LEED certification. SDCL 5-14-33 requires all buildings to be LEED certified; however, the law also allows for exemptions in certain situations. The project scope does not allow for the entire building envelope to be updated, so the heating and cooling loads are unable to be reduced making LEED Silver unobtainable.

## c. Impact to existing building or campus-wide heating/cooling/electrical systems:

The electrical service to the building will be updated. The cooling and heating systems are already connected to the efficient central plant which both have adequate capacity available. There may be some additional load with the window change and meeting current day ventilation requirements. Overall, the operating and utility costs should decrease with more efficient equipment and LED lighting. The building will continue to be connected to the campus Building Management system.

### d. Total project cost estimates:

The cost estimate is \$5.85M with bid and construction contingency. The project will be funded from \$4M in system maintenance and repair bonds, \$1M FY20 General M&R funds, \$500K FY22 HEFF M&R funds, and \$1M in donations from the South Dakota Mines Center for Alumni Relations & Advancement (CARA). The following is the breakdown of the project estimate:


CURRENT PROJECT FUNDING	\$6,500,000
Total Construction Cost	\$4,888,000
Geotechnical/Testing/Miscellaneous	\$30,000
Building Commissioning	\$48,000
Lead & Asbestos Removal	\$50,000
OSE Fees	\$40,000
Architect/Engineer Fees	\$394,000
Construction Contingency (~5%)	\$250,000
Bidding Contingency (~3%)	\$150,000
ESTIMATED PROJECT COSTS	\$5,850,000
Furniture, Fixture, & Equipment (FF&E)	\$645,000
TOTAL ESTIMATED PROJECT COSTS	\$6,495,000

Several alternates have been identified to ensure project stays within budget. Alternate #1 - Lower Level Bathroom Alternate #2 - Reduction of Exterior Glazing

### e. Changes from cost estimate for operational or M&R expenses:

There are no changes from the facility program plan.



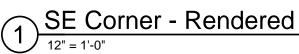



A1








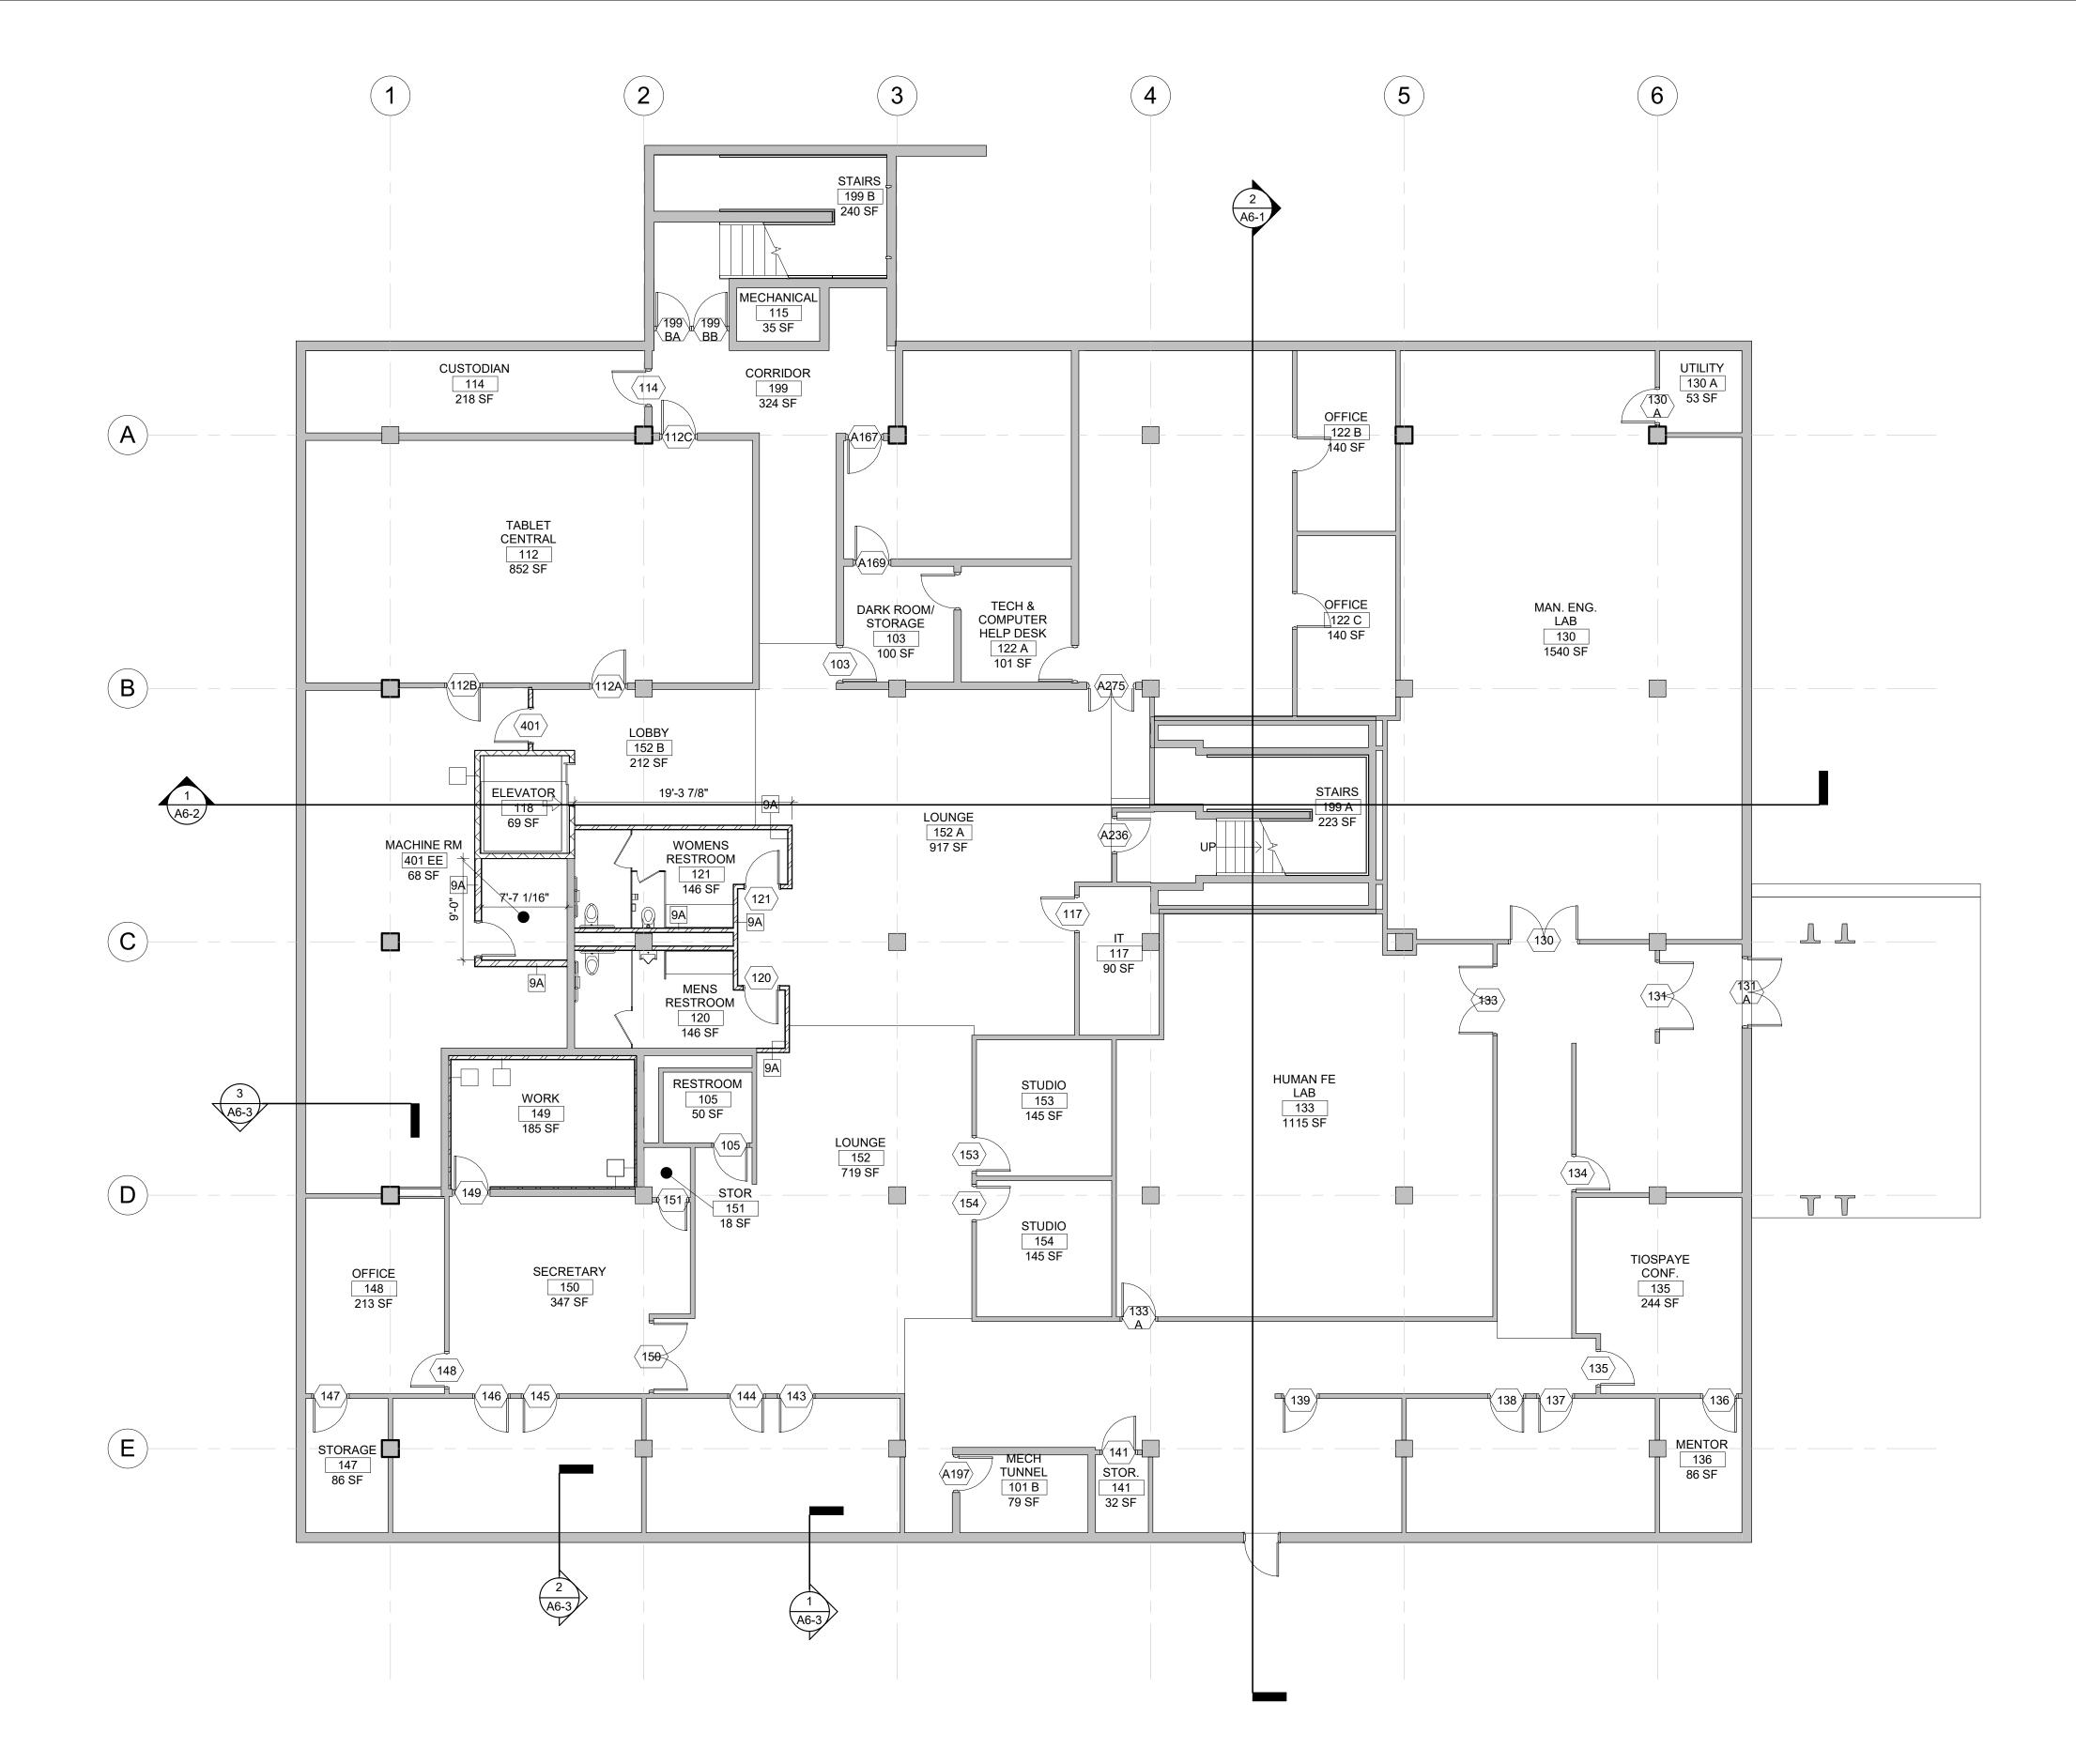

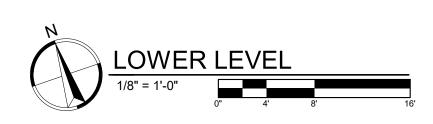




KEYNOTE SCHEDULE Attachment III	CO Arch OP
	1108 S. Main St. 102 Aberdeen, SD 57401 Phone: 605-725-4852 601 Kansas City St. 7 Rapid City, SD 57701
	Phone: 605-716-3652 300 N. Phillips Ave. 120 Sioux Falls, SD 57104 Phone: 605-334-9999 co-oparch.com
<b>GENERAL NOTES</b> ECHANICAL FOR ALL FLOOR DRAIN SIZES AND LOCATIONS U.N.O. SET FLOOR S MINIMUM ¾" BELOW FINISHED FLOOR. PROVIDE EVEN SLOPE FROM WALL TO W/ A MAXIMUM SLOPE OF ¼" PER FOOT. Y DRYWALL CONTROL JOINT LOCATIONS W/ ARCHITECT ON SITE PRIOR TO LATION. THIS INCLUDES, BUT IS NOT LIMITED TO, CONTROL JOINTS AT 30'-0" AX. IN LONG WALL EXPANSES. CONTROL JOINTS AT DOOR JAMBS EXTENDING DOOR HEAD TO CEILING. CONSIDERATION SHALL ALSO BE GIVEN TO LOCATING	811 East Washington Ave. 200 Madison, WI 53703
ROL JOINTS FROM FLOOR TO CEILING AT EITHER EDGE OF LARGE WINDOW NGS. DINATE ALL CHASE SIZES AND LOCATIONS W/ MECHANICAL. PROVIDE CHASES . EXPOSED MACHANICAL & ELECTRICAL WITH ADJACENT WALL MATERIAL AS RED. DINATE ALL SHEAR WALL LOCATIONS W/ STRUCTURAL PLANS. R & MOISTURE WEATHER BARRIER IS TO BE CONTINUOUS FROM THE BASE OF ALLS UP TO & TYING INTO THE ROOF BARRIER SYSTEM.	Phone: 608-276-9200 W238N1610 Busse Rd. 102 Waukesha, WI 53188 Phone: 262-875-6760 strang-inc.com
	CO-OP PROJECT NO: 1936
	PRELIMINARY NOT FOR CONSTRUCTION
	ISSUE: 11-04-2020 DESIGN DEVELOPMENT REVISION SCHEDULE: REV. # REV. DSC. REV. DATE
	PROJECT: SDSMT DEVEREAUX LIBRARY SOUTH DAKOTA SCHOOL OF MINES AND TECHNOLOGY RAPID CITY, SOUTH DAKOTA
	<u>SHEET TITLE:</u> LOWER LEVEL PLAN
	A1-0

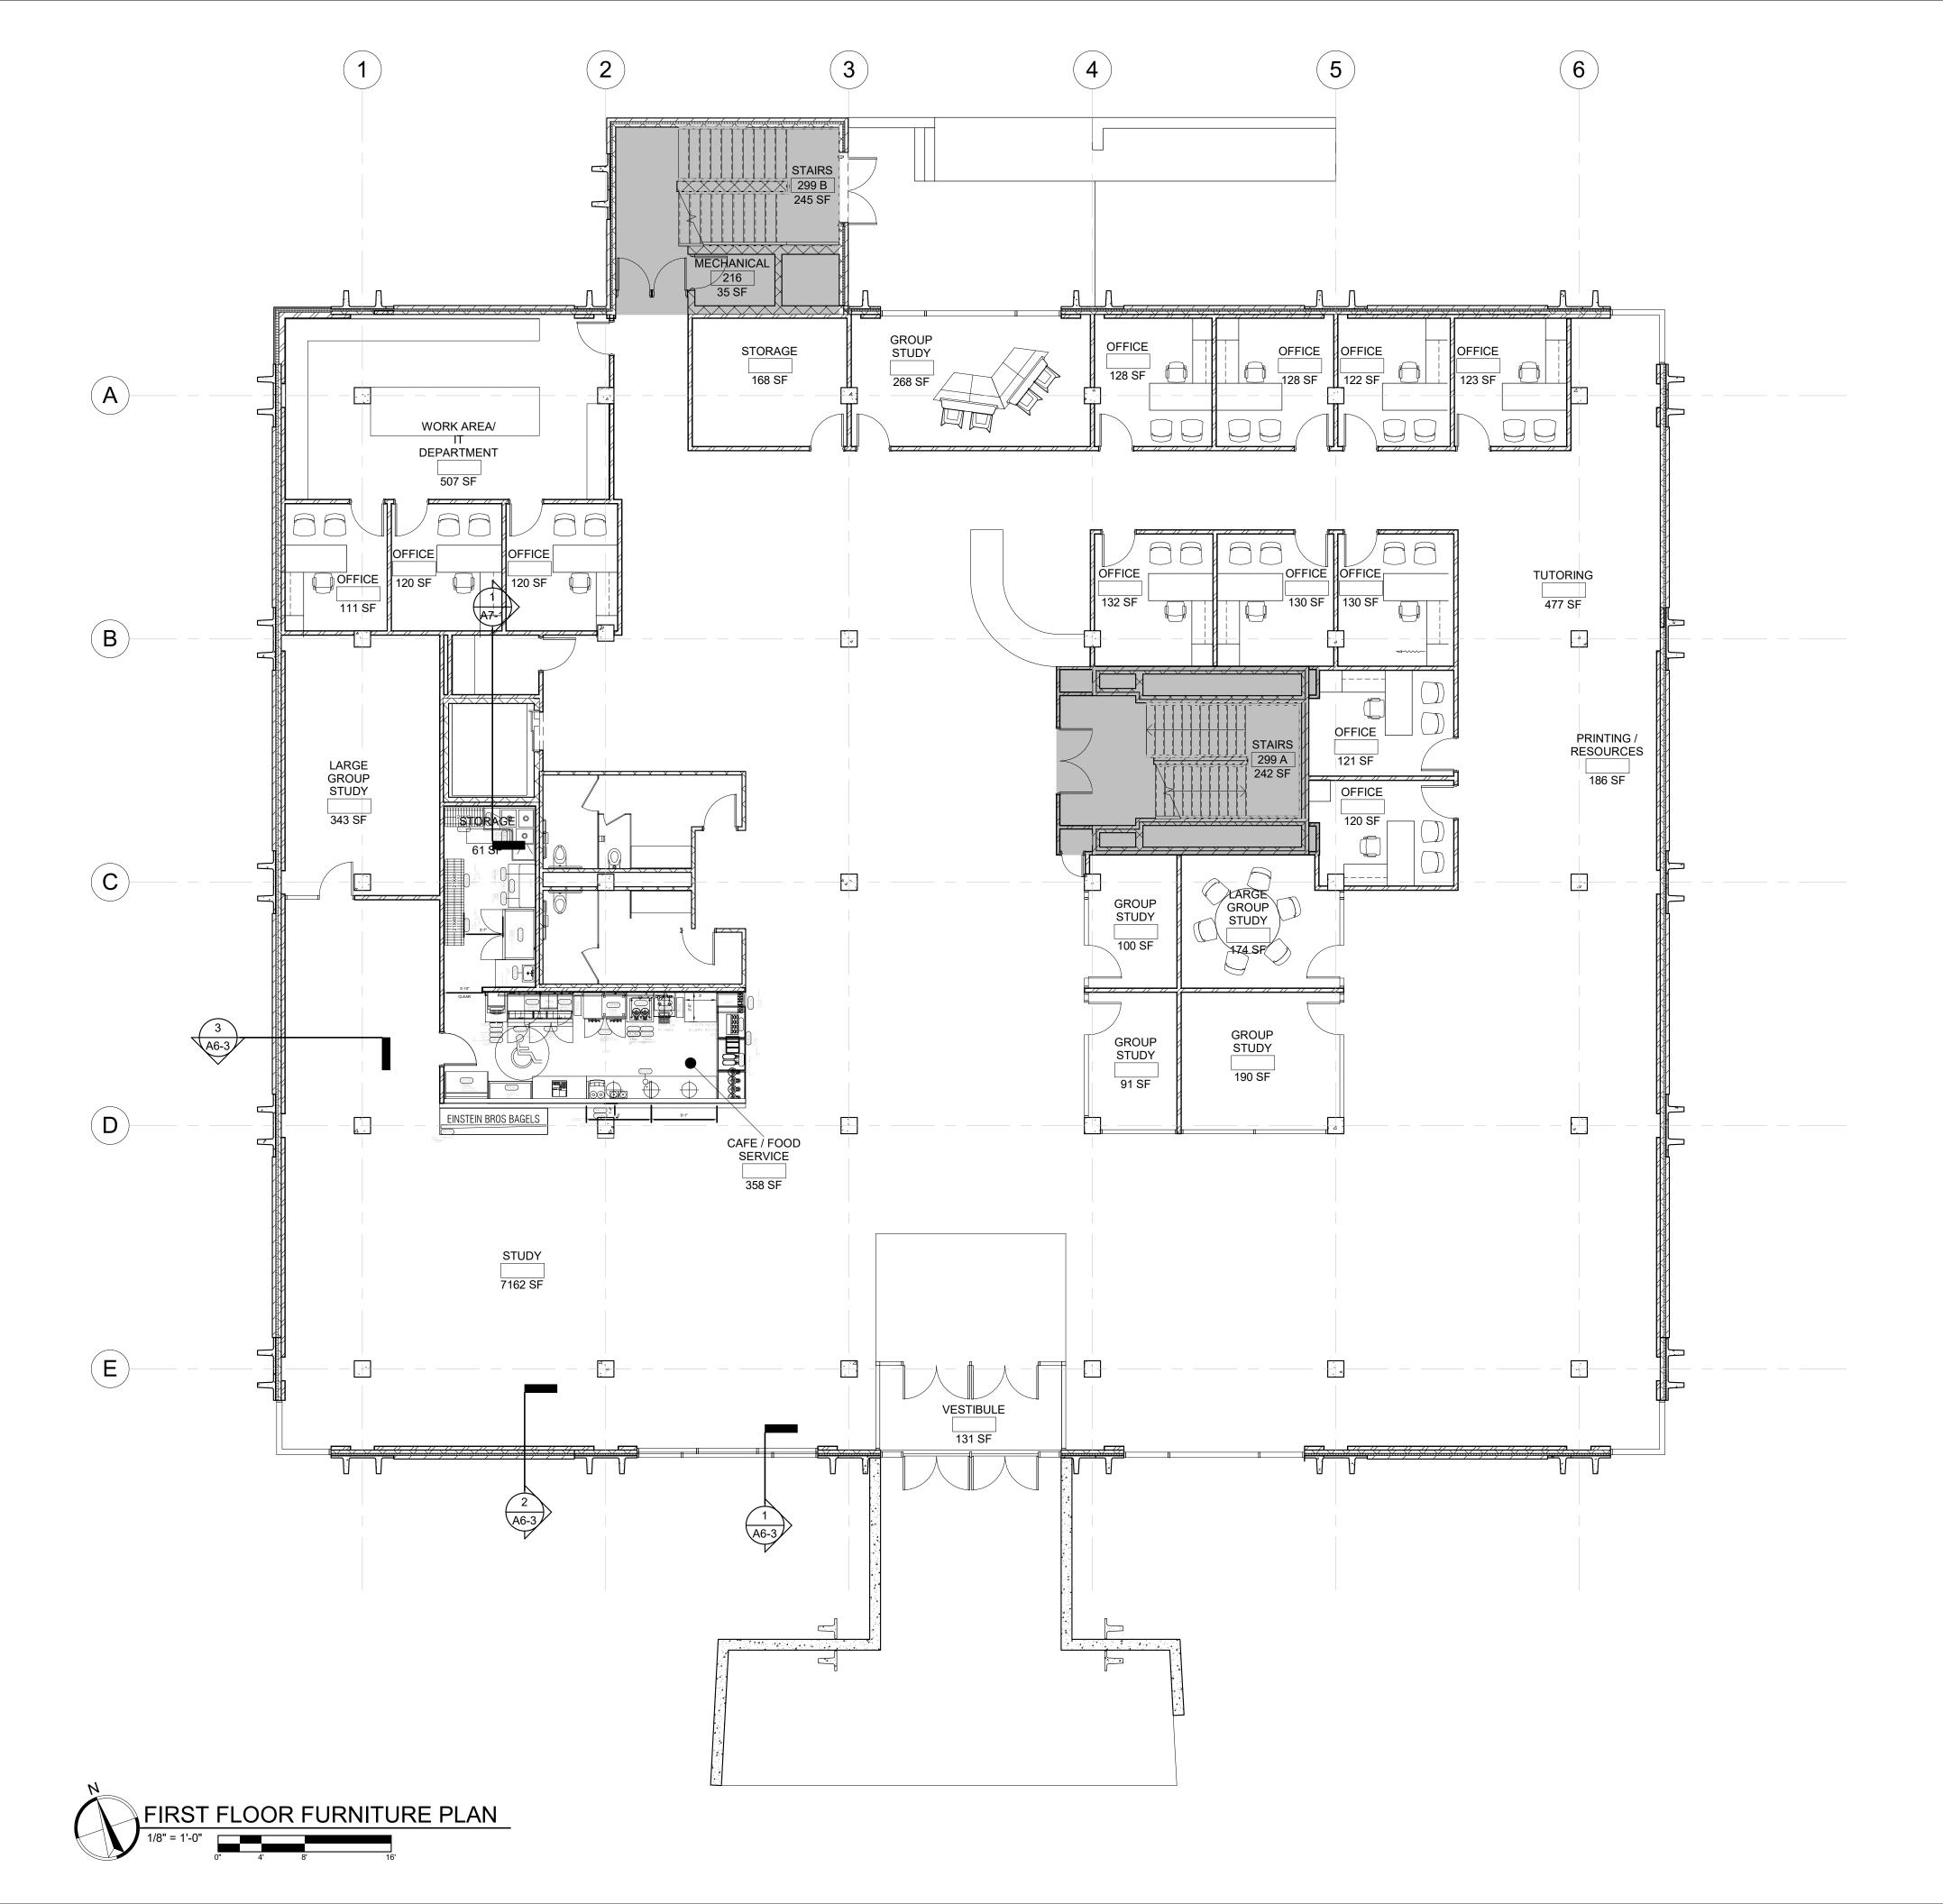


CO Arch OP
1108 S. Main St. 102 Aberdeen, SD 57401 Phone: 605-725-4852 601 Kansas City St. 7 Rapid City, SD 57701 Phone: 605-716-3652 300 N. Phillips Ave. 120 Sioux Falls, SD 57104 Phone: 605-334-9999 co-oparch.com
<image/> <text><text><text><text></text></text></text></text>
CO-OP PROJECT NO: 1936 PRELIMINARY NOT FOR CONSTRUCTION
ISSUE: 11-04-2020 DESIGN DEVELOPMENT REVISION SCHEDULE: REV. # REV. DSC. REV. DATE
PROJECT: SDSMT DEVEREAUX LIBRARY SOUTH DAKOTA SCHOOL OF MINES AND TECHNOLOGY RAPID CITY, SOUTH DAKOTA
SHEET TITLE: FIRST FLOOR FURNITURE PLAN

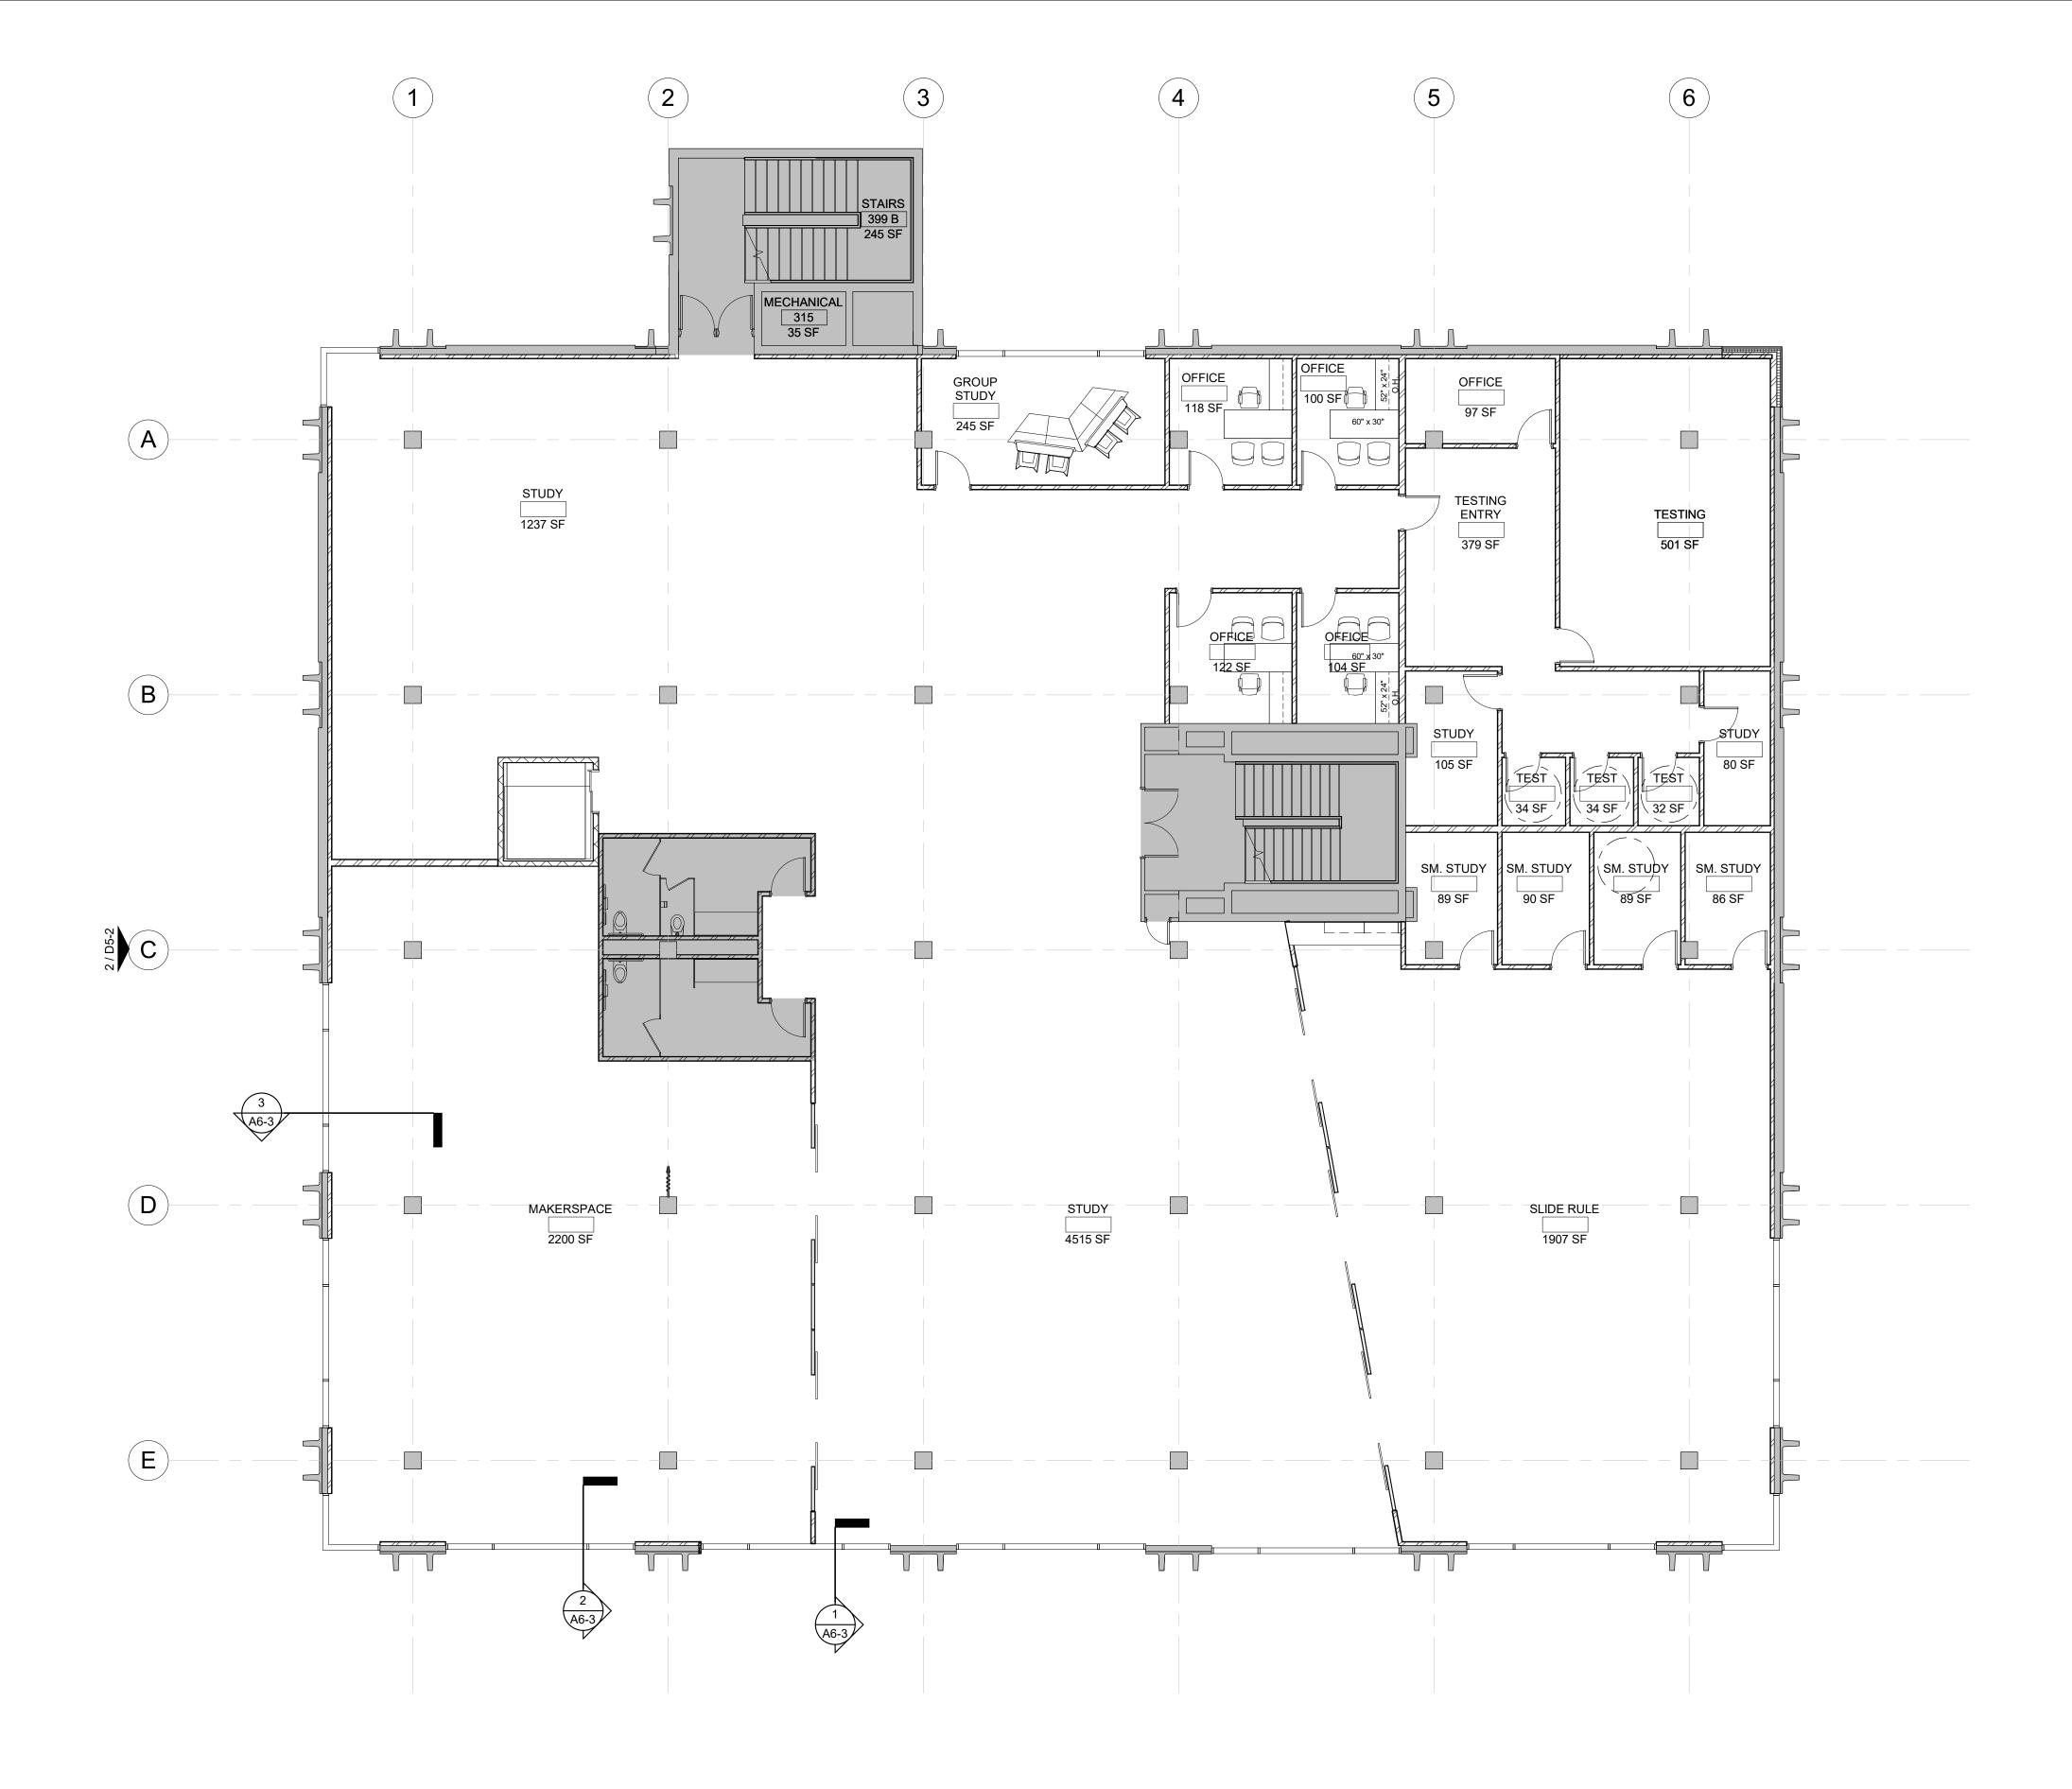




CO Arch OP
1108 S. Main St. 102 Aberdeen, SD 57401 Phone: 605-725-4852 601 Kansas City St. 7 Rapid City, SD 57701 Phone: 605-716-3652 300 N. Phillips Ave. 120 Sioux Falls, SD 57104 Phone: 605-334-9999 co-oparch.com
<image/> <text><text><text><text></text></text></text></text>
CO-OP PROJECT NO: 1936 PRELIMINARY NOT FOR CONSTRUCTION
ISSUE: 11-04-2020 DESIGN DEVELOPMENT REVISION SCHEDULE: REV. # REV. DSC. REV. DATE
PROJECT: SDSMT DEVEREAUX LIBRARY SOUTH DAKOTA SCHOOL OF MINES AND TECHNOLOGY RAPID CITY, SOUTH DAKOTA
SHEET TITLE: SECOND FLOOR FURNITURE PLAN



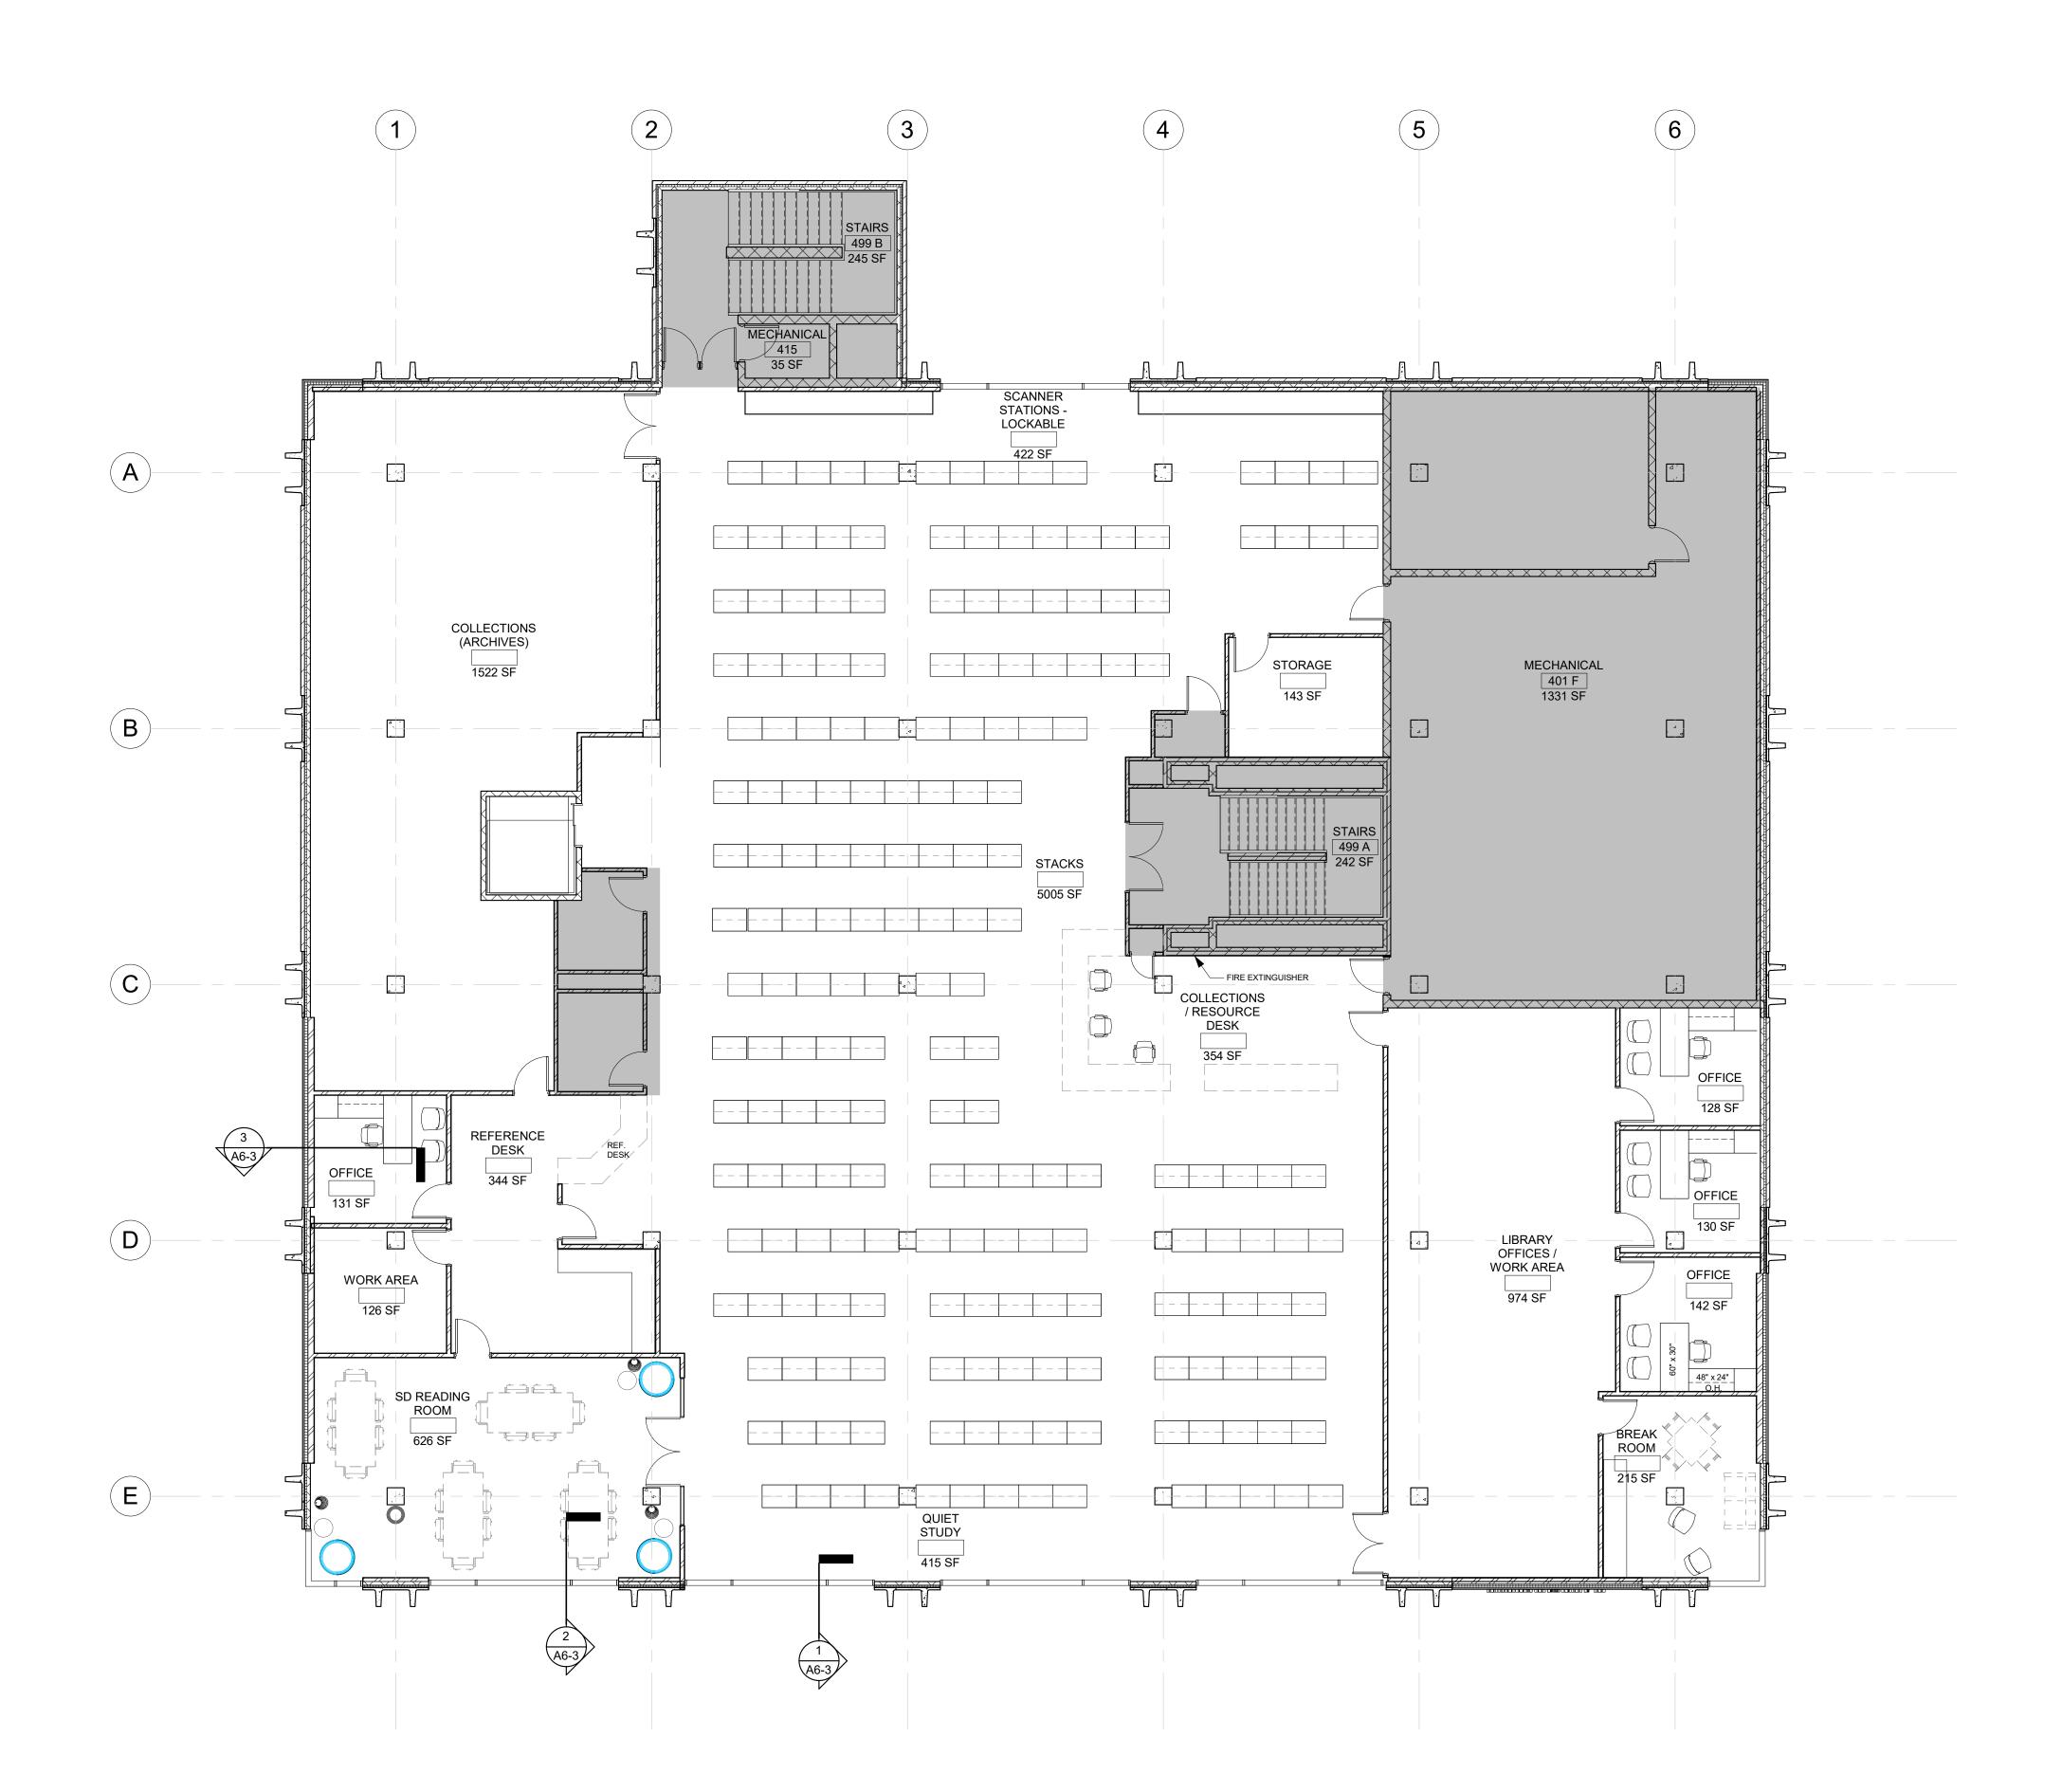


CO Arch OP
1108 S. Main St. 102 Aberdeen, SD 57401 Phone: 605-725-4852 601 Kansas City St. 7 Rapid City, SD 57701 Phone: 605-716-3652 300 N. Phillips Ave. 120 Sioux Falls, SD 57104 Phone: 605-334-9999 co-oparch.com
<image/> <text><text><text><text></text></text></text></text>
CO-OP PROJECT NO: 1936 PRELIMINARY NOT FOR CONSTRUCTION
ISSUE: 11-04-2020 DESIGN DEVELOPMENT REVISION SCHEDULE: REV. # REV. DSC. REV. DATE
PROJECT:         SDSMT DEVEREAUX LIBRARY         SOUTH DAKOTA SCHOOL OF         MINES AND TECHNOLOGY         RAPID CITY, SOUTH DAKOTA         SHEET TITLE:         THIRD FLOOR FURNITURE PLAN
A1-3.1

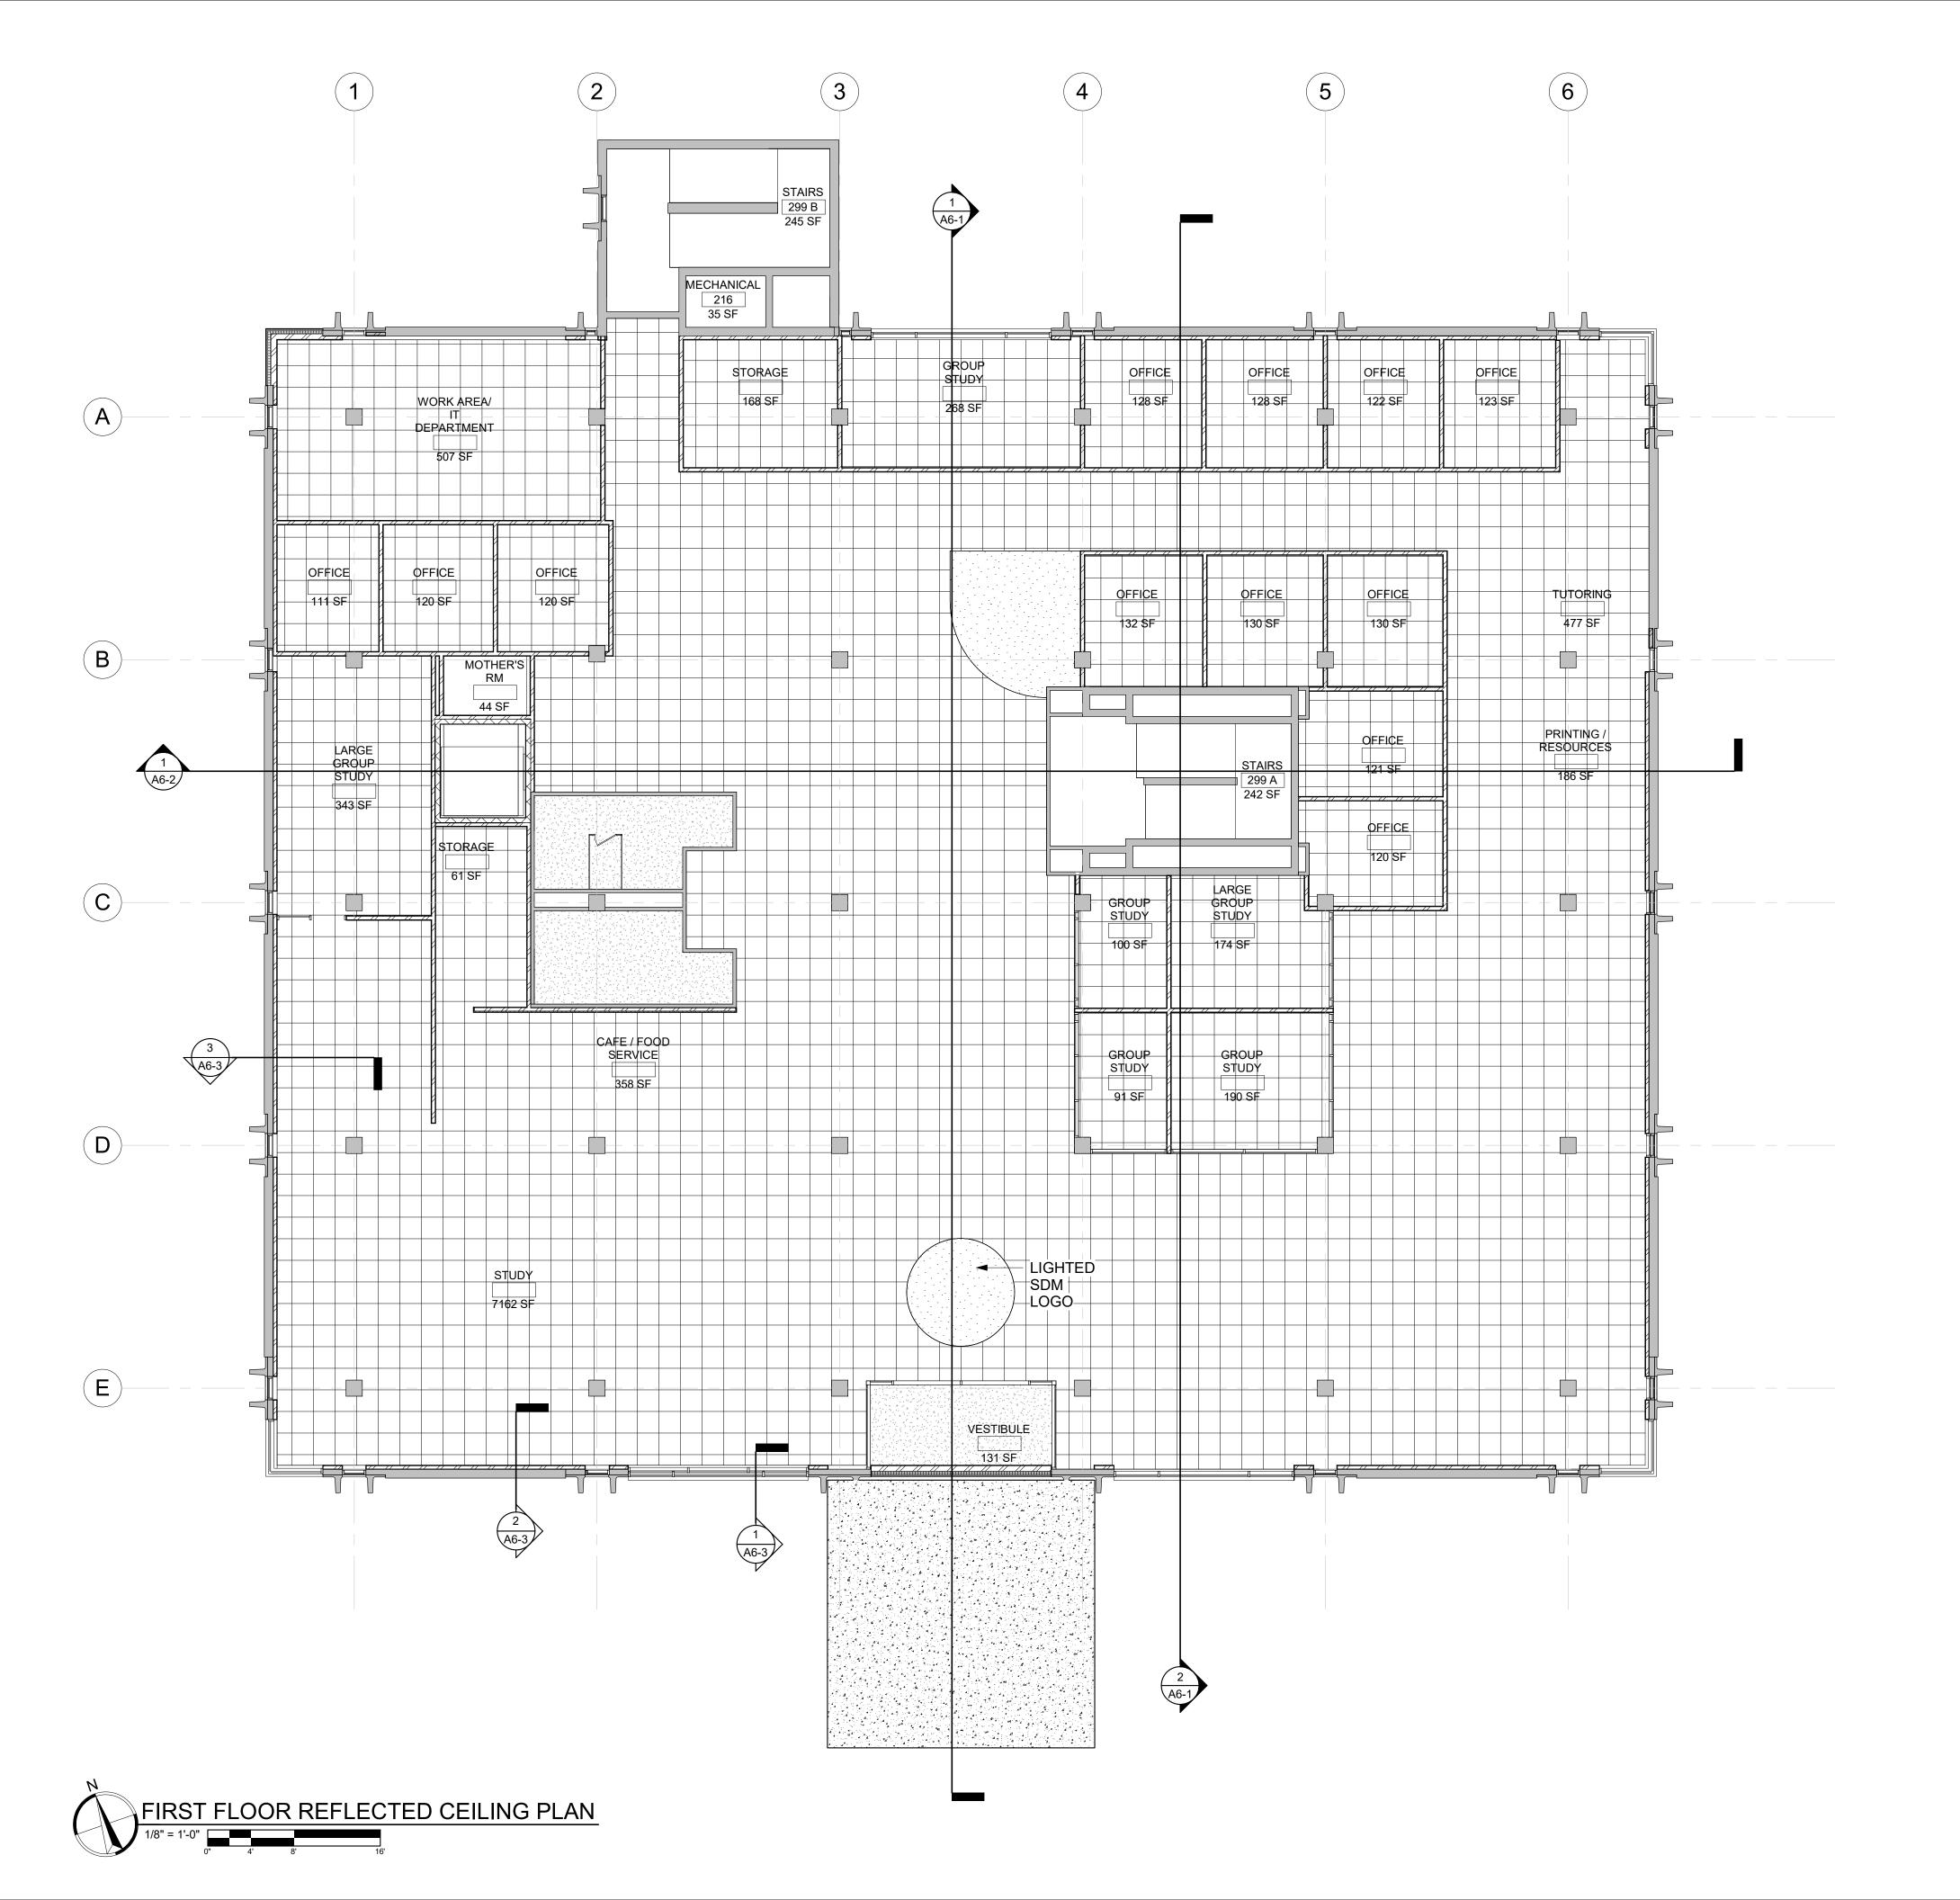


 SEE CIVIL INFORMA
 ALL DIME
 ALL DIME
 RESTROC
 VERIFY D INSTALLA
 O.C. MAX
 FROM DC CONTROI
 OPENING
 COORDIN AT ALL EX
 REQUIRE
 PROVIDE
 AND ANY
 PROVIDE
 SHOWER


KEYNOTE SCHEDULE	
	Arch <b>OP</b>
	1108 S. Main St. 102 Aberdeen, SD 57401 Phone: 605-725-4852
	601 Kansas City St. 7 Rapid City, SD 57701
	Phone: 605-716-3652 300 N. Phillips Ave. 120
	Sioux Falls, SD 57104 Phone: 605-334-9999
	co-oparch.com
GENERAL NOTES	
IL, STRUCTURAL, MECHANICAL, AND ELECTRICAL FOR ADDITIONAL ATION AND COORDINATION. ENSIONS ARE FROM FACE OF FRAMING U.N.O.	STRANG DESIGN SYNCHRONICITY
DOM WALLS ARE SOUND INSULATED AND EXTEND TO THE DECK. DRYWALL CONTROL JOINT LOCATIONS W/ARCHITECT ON SITE PRIOR TO ATION. THIS INCLUDES, BUT IS NOT LIMITED TO, CONTROL JOINTS AT 30'-0" X. IN LONG WALL EXPANSES. CONTROL JOINTS AT DOOR JAMBS EXTENDING OOR HEAD TO CEILING. CONSIDERATION SHALL ALSO BE GIVEN TO LOCATING DL JOINTS FROM FLOOR TO CEILING AT EITHER EDGE OF LARGE WINDOW	811 East Washington Ave. 200 Madison, WI 53703 Phone: 608-276-9200
GS. NATE ALL CHASE SIZES AND LOCATIONS W/ MECHANICAL. PROVIDE CHASES EXPOSED MACHANICAL & ELECTRICAL WITH ADJACENT WALL MATERIAL AS ED.	W238N1610 Busse Rd. 102 Waukesha, WI 53188
E WATER-RESISTANT GYPSUM BOARD PANELS AT ALL BATHROOM WALLS Y WALLS EXPOSED TO MOISTURE. E GLASS-MATT FACED GYPSUM SHEATHING BEHIND TILE FINISHES AT ALL RS AND BATHTUBS.	Phone: 262-875-6760 strang-inc.com
	CO-OP PROJECT NO: 1936
	PRELIMINARY
	NOT FOR CONSTRUCTION
	ISSUE: 11-04-2020 DESIGN DEVELOPMENT
	REVISION SCHEDULE: REV. # REV. DSC. REV. DATE
	PROJECT:
	SDSMT DEVEREAUX LIBRARY SOUTH DAKOTA SCHOOL OF
	MINES AND TECHNOLOGY RAPID CITY, SOUTH DAKOTA
	<u>SHEET TITLE:</u>
	FIRST FLOOR REFLECTED CEILING PLAN
	A3-2
	1

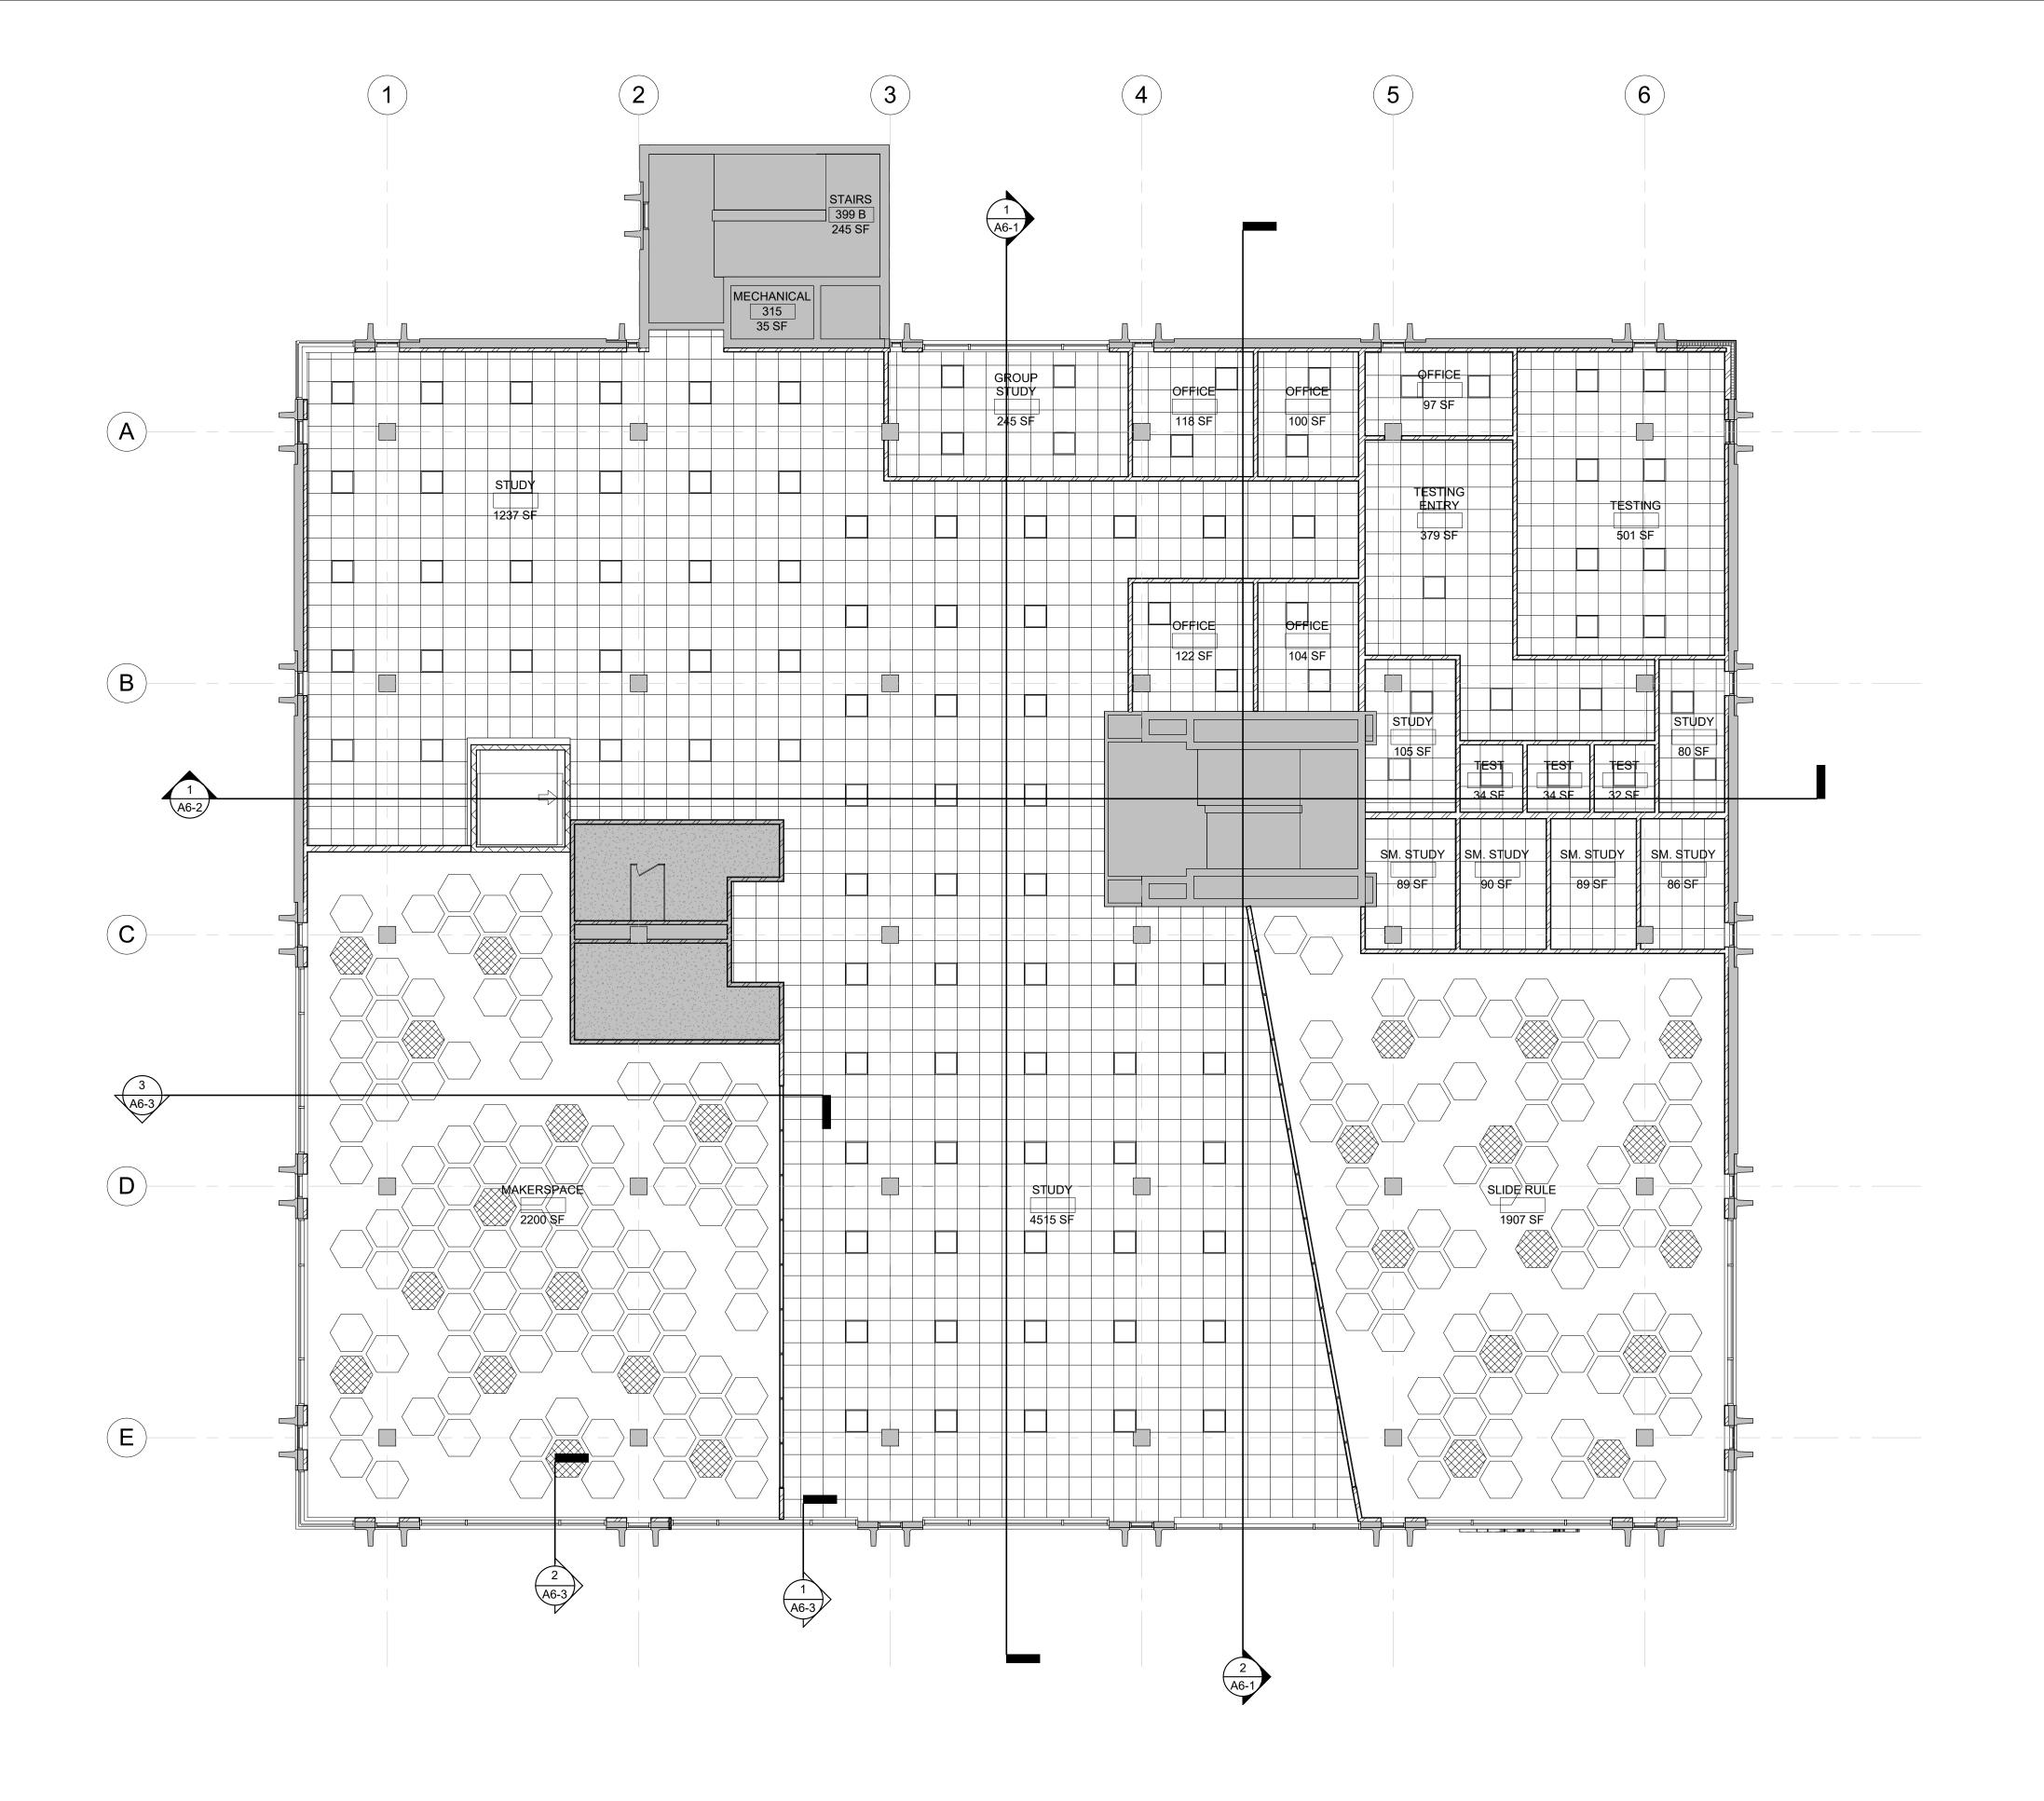




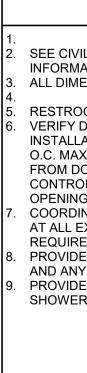


KEYNOTE SCHEDULE	
	Arch <b>OP</b>
	1108 S. Main St. 102
	Aberdeen, SD 57401 Phone: 605-725-4852
	601 Kansas City St. 7 Rapid City, SD 57701 Phone: 605-716-3652
	300 N. Phillips Ave. 120 Sioux Falls, SD 57104
	Phone: 605-334-9999 co-oparch.com
	I
IL, STRUCTURAL, MECHANICAL, AND ELECTRICAL FOR ADDITIONAL	STRANG
ATION AND COORDINATION. ENSIONS ARE FROM FACE OF FRAMING U.N.O.	DESIGN SYNCHRONICITY
DRYWALL CONTROL JOINT LOCATIONS W/ARCHITECT ON SITE PRIOR TO ATION. THIS INCLUDES, BUT IS NOT LIMITED TO, CONTROL JOINTS AT 30'-0" X. IN LONG WALL EXPANSES. CONTROL JOINTS AT DOOR JAMBS EXTENDING OOR HEAD TO CEILING. CONSIDERATION SHALL ALSO BE GIVEN TO LOCATING	811 East Washington Ave. 200 Madison, WI 53703 Phone: 608-276-9200
DL JOINTS FROM FLOOR TO CEILING AT EITHER EDGE OF LARGE WINDOW GS. INATE ALL CHASE SIZES AND LOCATIONS W/ MECHANICAL. PROVIDE CHASES EXPOSED MACHANICAL & ELECTRICAL WITH ADJACENT WALL MATERIAL AS	W238N1610 Busse Rd. 102 Waukesha, WI 53188
ED. E WATER-RESISTANT GYPSUM BOARD PANELS AT ALL BATHROOM WALLS Y WALLS EXPOSED TO MOISTURE. E GLASS-MATT FACED GYPSUM SHEATHING BEHIND TILE FINISHES AT ALL RS AND BATHTUBS.	Phone: 262-875-6760 strang-inc.com
RS AND DATITUDS.	
	CO-OP PROJECT NO: 1936
	PRELIMINARY NOT FOR
	CONSTRUCTION
	ISSUE:
	REVISION SCHEDULE:
	REV. # REV. DSC. REV. DATE
	PROJECT:
	SOUTH DAKOTA SCHOOL OF
	MINES AND TECHNOLOGY RAPID CITY, SOUTH DAKOTA
	SHEET TITLE:
	SECOND FLOOR REFLECTED CEILING PLAN
	A3-3

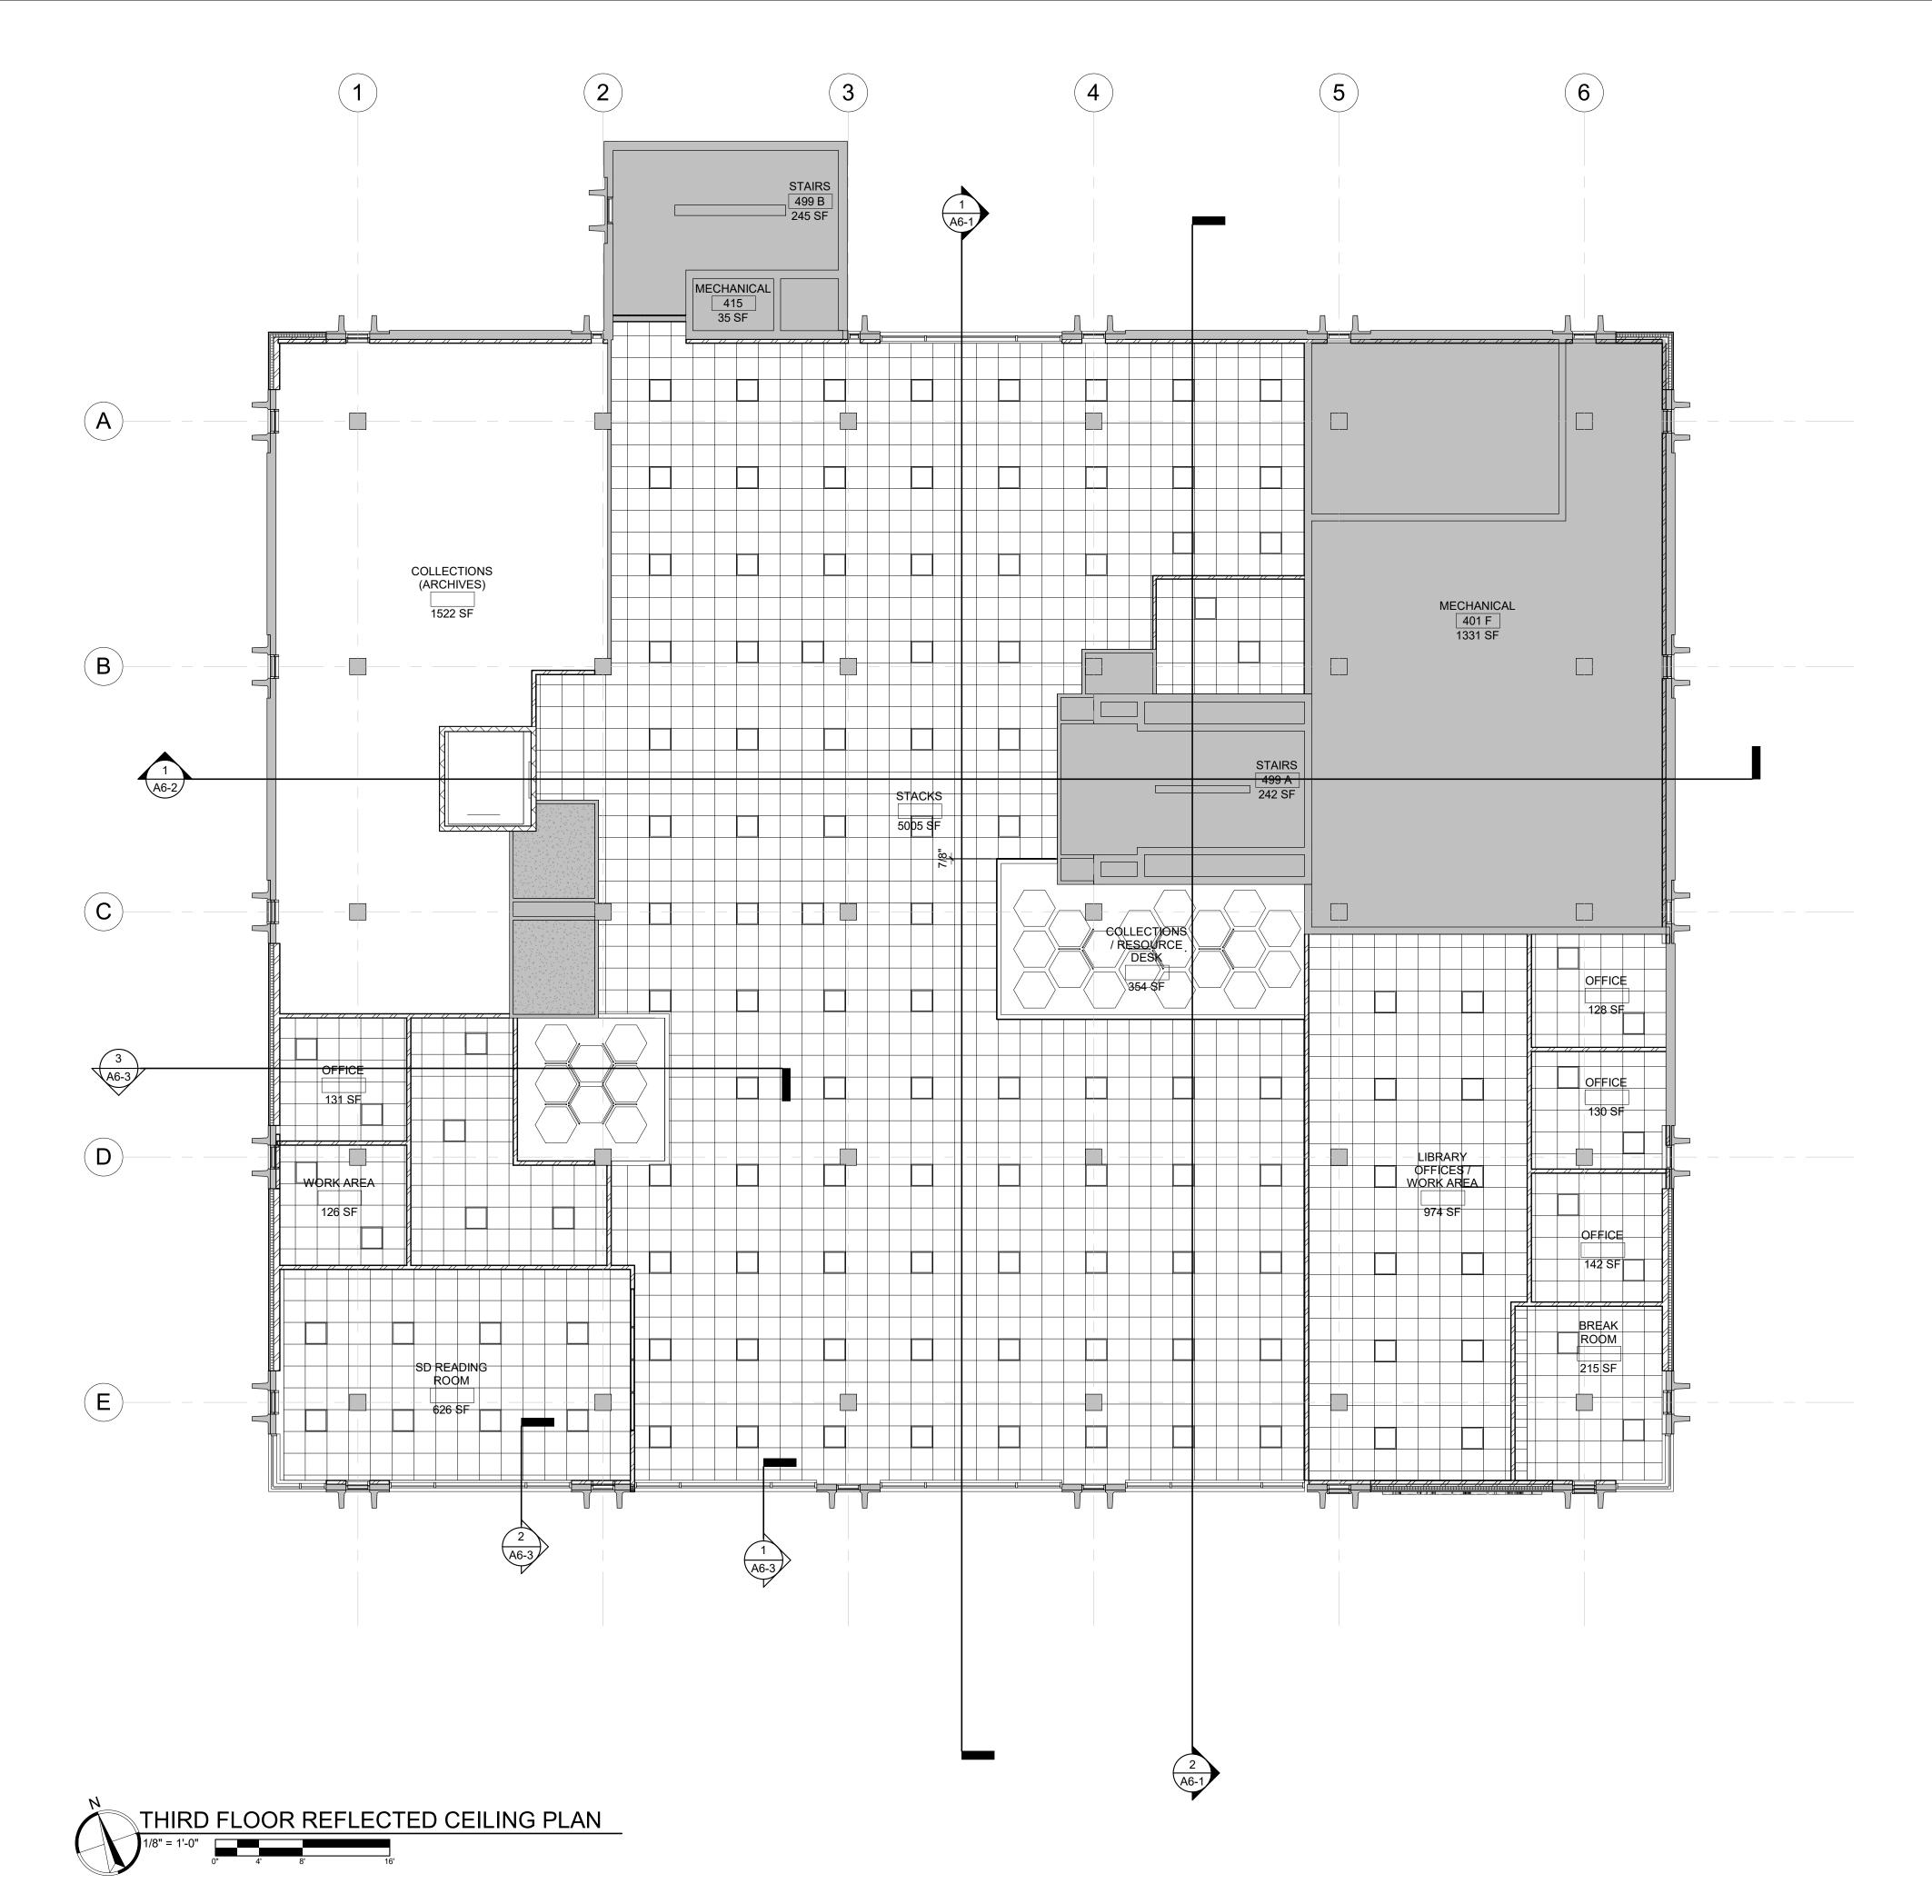


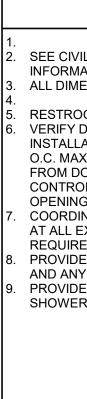

KEYNOTE SCHEDULE	СО
	Arch <b>OP</b>
	1108 S. Main St. 102
	Aberdeen, SD 57401 Phone: 605-725-4852
	601 Kansas City St. 7 Rapid City, SD 57701 Phone: 605-716-3652
	300 N. Phillips Ave. 120 Sioux Falls, SD 57104 Phone: 605-334-9999
	co-oparch.com
GENERAL NOTES	
IL, STRUCTURAL, MECHANICAL, AND ELECTRICAL FOR ADDITIONAL ATION AND COORDINATION. ENSIONS ARE FROM FACE OF FRAMING U.N.O.	STRANG DESIGN SYNCHRONICITY
DOM WALLS ARE SOUND INSULATED AND EXTEND TO THE DECK. DRYWALL CONTROL JOINT LOCATIONS WARCHITECT ON SITE PRIOR TO ATION. THIS INCLUDES, BUT IS NOT LIMITED TO, CONTROL JOINTS AT 30'-0" X. IN LONG WALL EXPANSES. CONTROL JOINTS AT DOOR JAMBS EXTENDING	811 East Washington Ave. 200
OOR HEAD TO CEILING. CONSIDERATION SHALL ALSO BE GIVEN TO LOCATING DL JOINTS FROM FLOOR TO CEILING AT EITHER EDGE OF LARGE WINDOW GS. INATE ALL CHASE SIZES AND LOCATIONS W/ MECHANICAL. PROVIDE CHASES	Madison, WI 53703 Phone: 608-276-9200 W238N1610 Busse Rd. 102
EXPOSED MACHANICAL & ELECTRICAL WITH ADJACENT WALL MATERIAL AS ED. E WATER-RESISTANT GYPSUM BOARD PANELS AT ALL BATHROOM WALLS Y WALLS EXPOSED TO MOISTURE.	Waukesha, WI 53188 Phone: 262-875-6760
E GLASS-MATT FACED GYPSUM SHEATHING BEHIND TILE FINISHES AT ALL RS AND BATHTUBS.	strang-inc.com
	CO-OP PROJECT NO: 1936
	PRELIMINARY NOT FOR
	CONSTRUCTION
	ISSUE: 11-04-2020 DESIGN DEVELOPMENT
	REVISION SCHEDULE: REV. # REV. DSC. REV. DATE
	PROJECT:
	SDSMT DEVEREAUX LIBRARY SOUTH DAKOTA SCHOOL OF MINES AND TECHNOLOGY
	RAPID CITY, SOUTH DAKOTA
	<u>SHEET TITLE:</u> THIRD FLOOR REFLECTED CEILING PLAN
	A3-4
	1

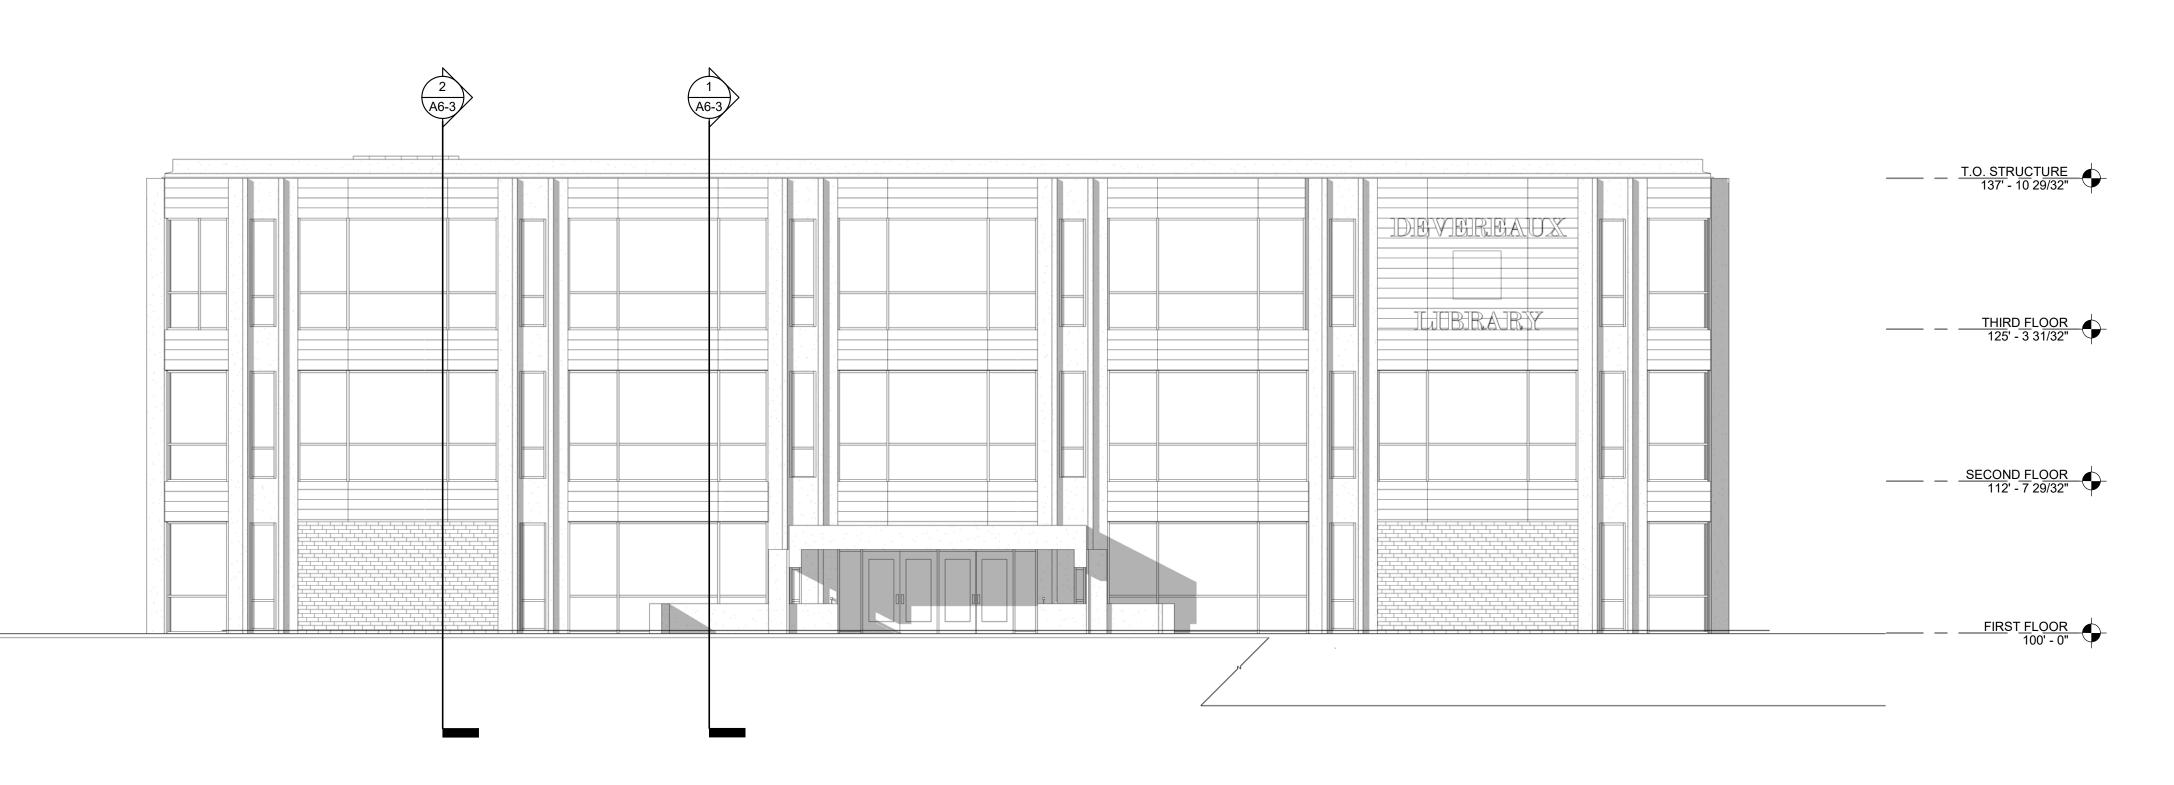


# 1 NORTH ELEVATION

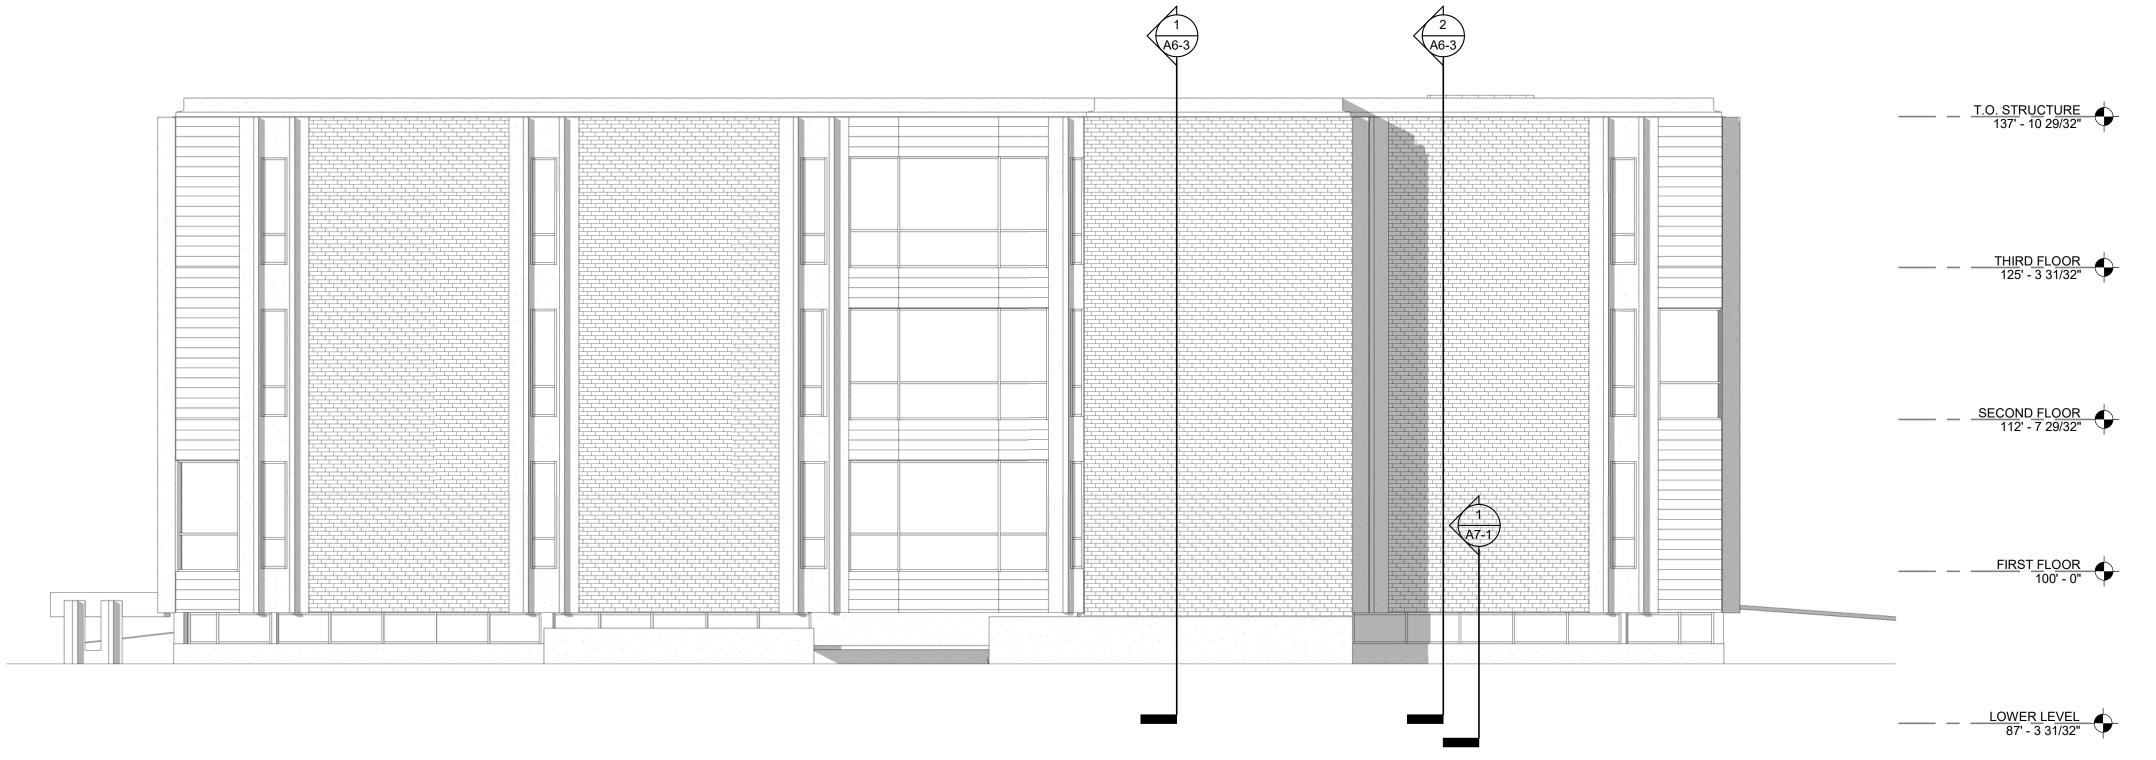


. SEE SITE PLAN STAGING, LAW 2. SEE CIVIL, STF INFORMATION 5. THE AIR & MOI THE WALLS UI

KEYNOTE SCHEDULE	
	Arch <b>OP</b>
	1108 S. Main St. 102 Aberdeen, SD 57401 Phone: 605-725-4852
	601 Kansas City St. 7 Rapid City, SD 57701 Phone: 605-716-3652
	300 N. Phillips Ave. 120 Sioux Falls, SD 57104 Phone: 605-334-9999
	co-oparch.com
<b>GENERAL NOTES</b> AN FOR ADDITIONAL INFORMATION REGARDING CONSTRUCTION LIMITS, AWN IRRIGATION, SOD & LANDSCAPING. TRUCTURAL, MECHANICAL, AND ELECTRICAL FOR ADDITIONAL ON AND COORDINATION. OISTURE WEATHER BARRIER IS TO BE CONTINUOUS FROM THE BASE OF	STRANG DESIGN SYNCHRONICITY
UP TO & TYING INTO THE ROOF BARRIER SYSTEM.	811 East Washington Ave. 200 Madison, WI 53703 Phone: 608-276-9200
	W238N1610 Busse Rd. 102 Waukesha, WI 53188 Phone: 262-875-6760
	strang-inc.com
	CO-OP PROJECT NO: 1936
	PRELIMINARY NOT FOR CONSTRUCTION
	ISSUE: 11-04-2020 DESIGN DEVELOPMENT REVISION SCHEDULE: REV. # REV. DSC. REV. DATE
	PROJECT:
	SDSMT DEVEREAUX LIBRARY SOUTH DAKOTA SCHOOL OF MINES AND TECHNOLOGY RAPID CITY, SOUTH DAKOTA
	SHEET TITLE: EXTERIOR ELEVATIONS
	A5-1



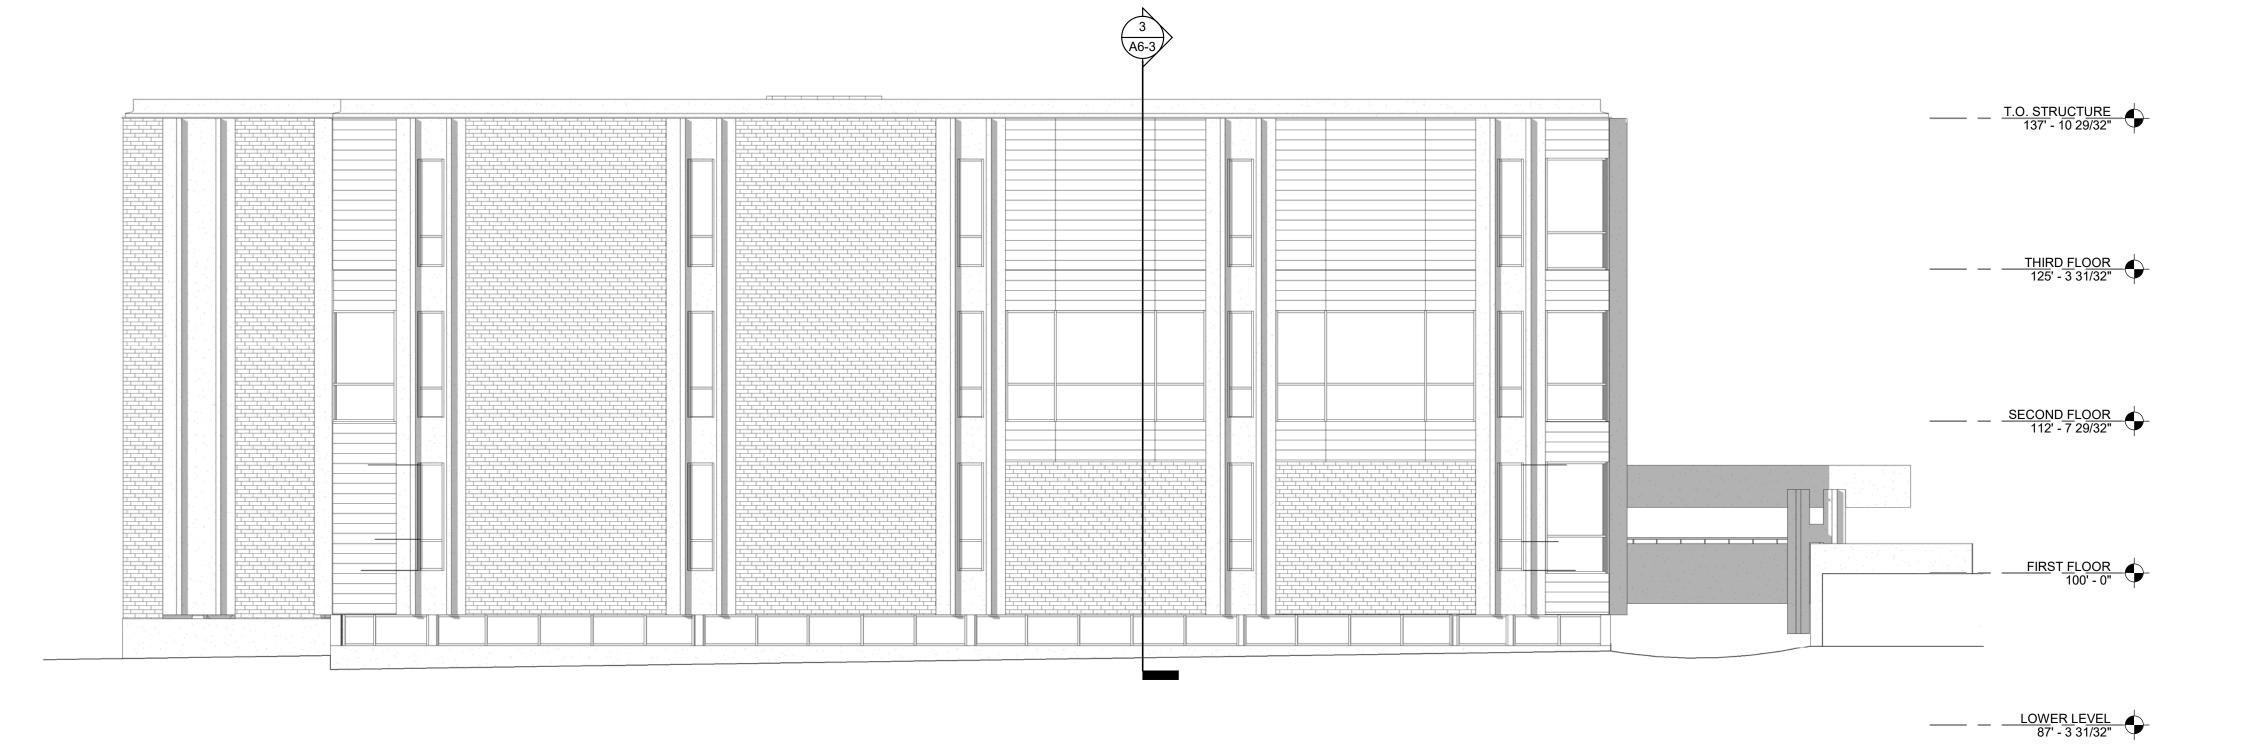




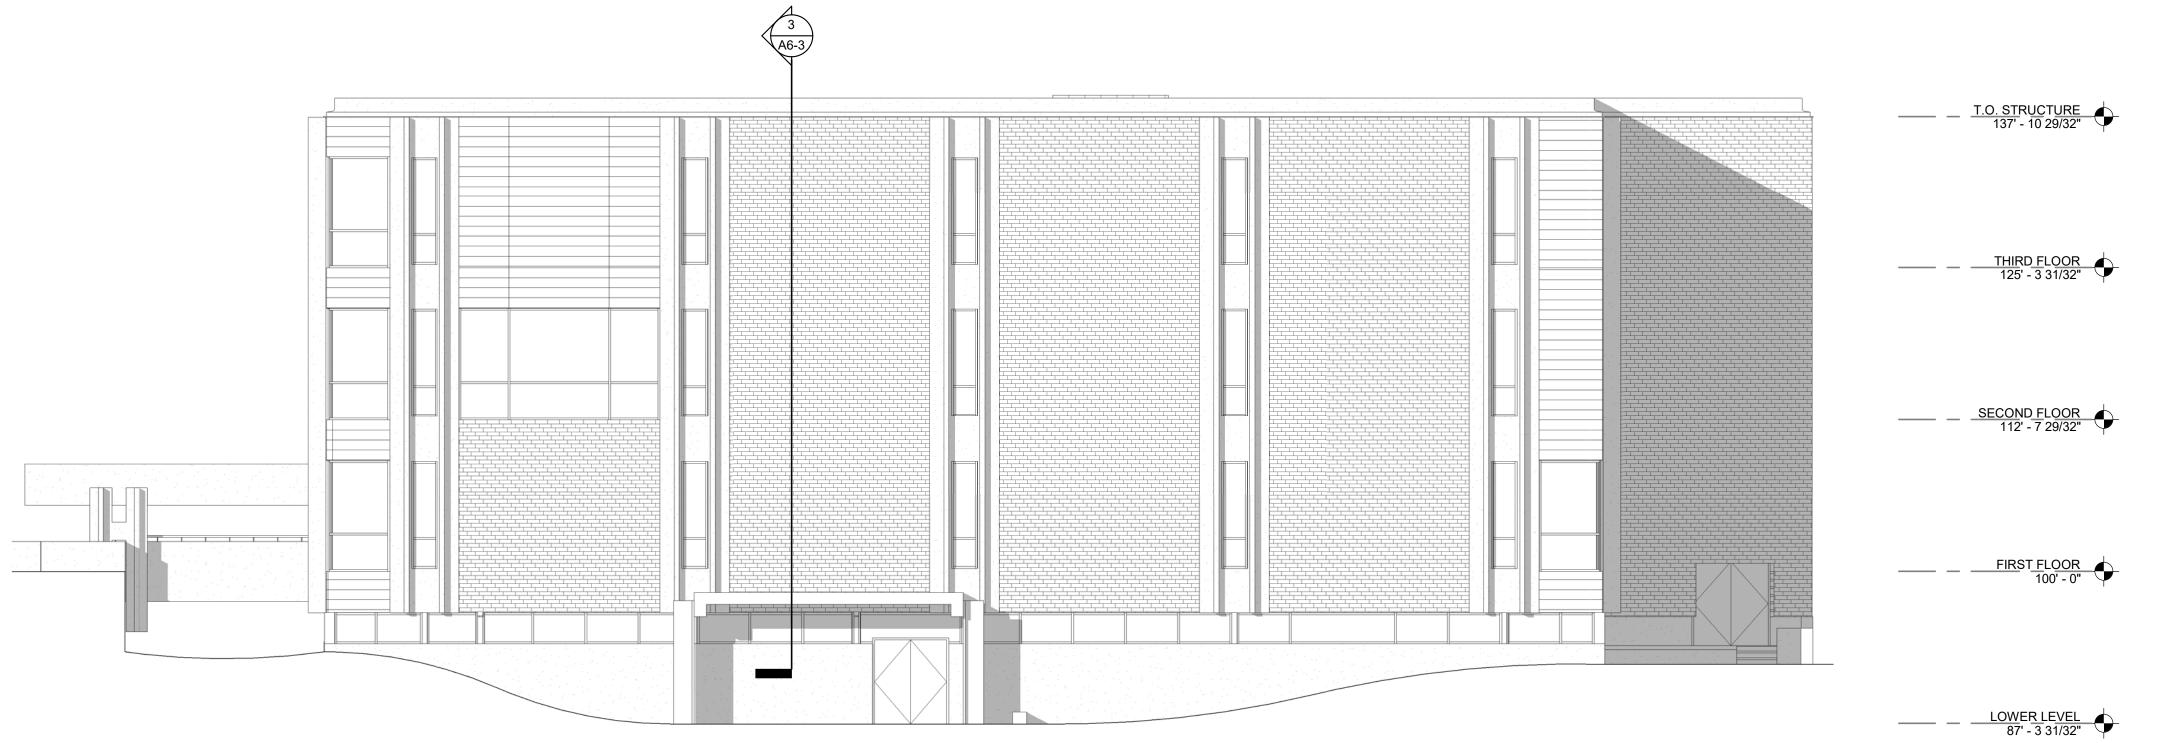


 SEE SITE PLAN STAGING, LAW
 SEE CIVIL, STF INFORMATION
 THE AIR & MOI THE WALLS UI

KEYNOTE SCHEDULE	CO Arch OP
	1108 S. Main St. 102 Aberdeen, SD 57401 Phone: 605-725-4852 601 Kansas City St. 7 Rapid City, SD 57701 Phone: 605-716-3652 300 N. Phillips Ave. 120 Sioux Falls, SD 57104 Phone: 605-334-9999 co-oparch.com
<b>GENERAL NOTES</b> AN FOR ADDITIONAL INFORMATION REGARDING CONSTRUCTION LIMITS, AWN IRRIGATION, SOD & LANDSCAPING. TRUCTURAL, MECHANICAL, AND ELECTRICAL FOR ADDITIONAL ON AND COORDINATION. OISTURE WEATHER BARRIER IS TO BE CONTINUOUS FROM THE BASE OF	STRANG DESIGN SYNCHRONICITY
UP TO & TYING INTO THE ROOF BARRIER SYSTEM.	811 East Washington Ave. 200 Madison, WI 53703 Phone: 608-276-9200 W238N1610 Busse Rd. 102 Waukesha, WI 53188 Phone: 262-875-6760 strang-inc.com
	CO-OP PROJECT NO: 1936 PRELIMINARY NOT FOR CONSTRUCTION
	ISSUE: 11-04-2020 DESIGN DEVELOPMENT REVISION SCHEDULE: REV. # REV. DSC. REV. DATE
	PROJECT: SDSMT DEVEREAUX LIBRARY SOUTH DAKOTA SCHOOL OF MINES AND TECHNOLOGY RAPID CITY, SOUTH DAKOTA
	SHEET TITLE: EXTERIOR ELEVATIONS
	A5-2

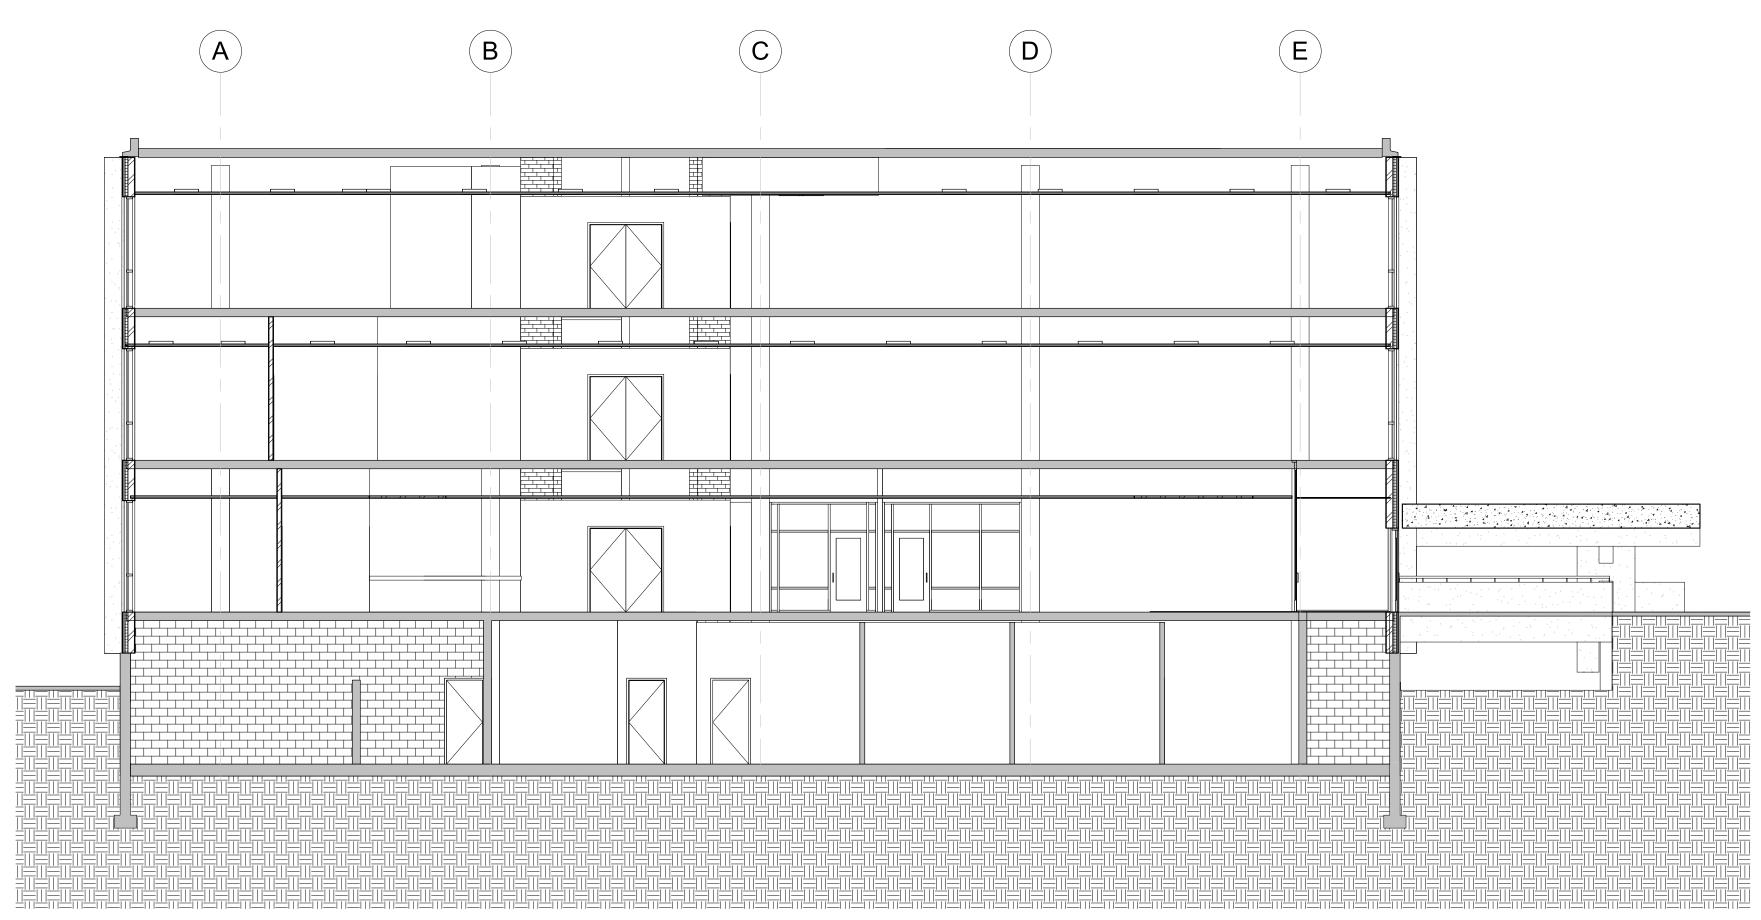


Section 1 1/8" = 1'-0"

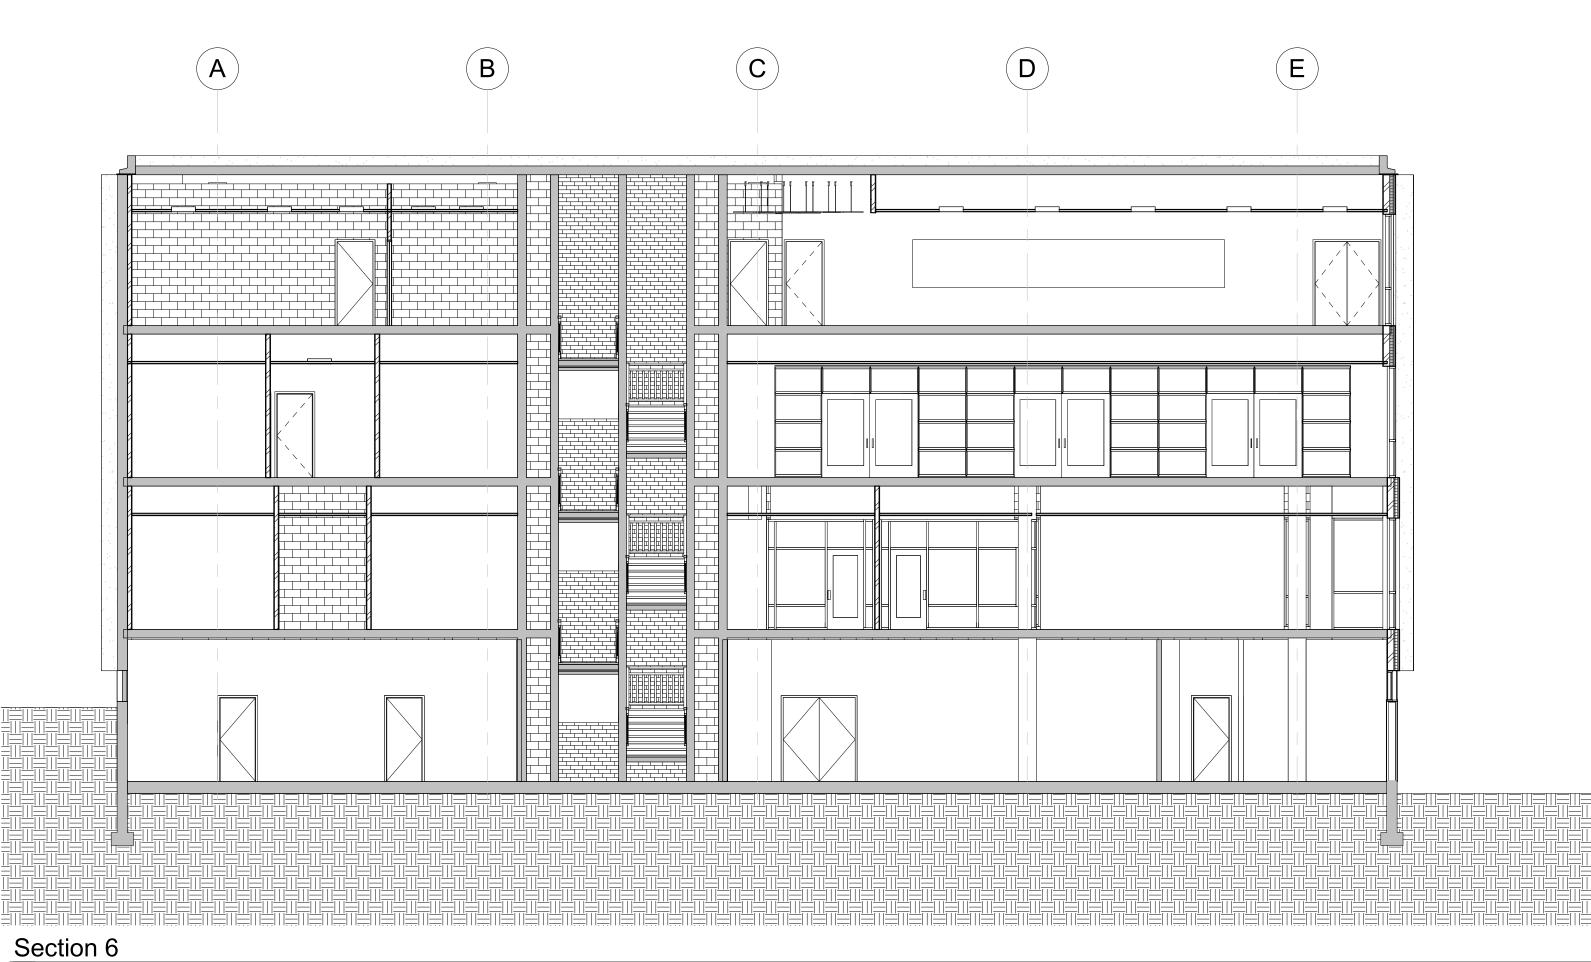

## **KEYNOTE SCHEDULE**


CO Arch OP
1108 S. Main St. 102 Aberdeen, SD 57401 Phone: 605-725-4852 601 Kansas City St. 7 Rapid City, SD 57701 Phone: 605-716-3652 300 N. Phillips Ave. 120
Sioux Falls, SD 57104 Phone: 605-334-9999 co-oparch.com
811 East Washington Ave. 200 Madison, WI 53703 Phone: 608-276-9200
W238N1610 Busse Rd. 102 Waukesha, WI 53188 Phone: 262-875-6760 strang-inc.com
CO-OP PROJECT NO: 1936
PRELIMINARY NOT FOR CONSTRUCTION
ISSUE: 11-04-2020 DESIGN DEVELOPMENT REVISION SCHEDULE: REV. # REV. DSC. REV. DATE
PROJECT: SDSMT DEVEREAUX LIBRARY SOUTH DAKOTA SCHOOL OF MINES AND TECHNOLOGY RAPID CITY, SOUTH DAKOTA
SHEET TITLE: BUILDING SECTIONS & DETAILS
A6-1

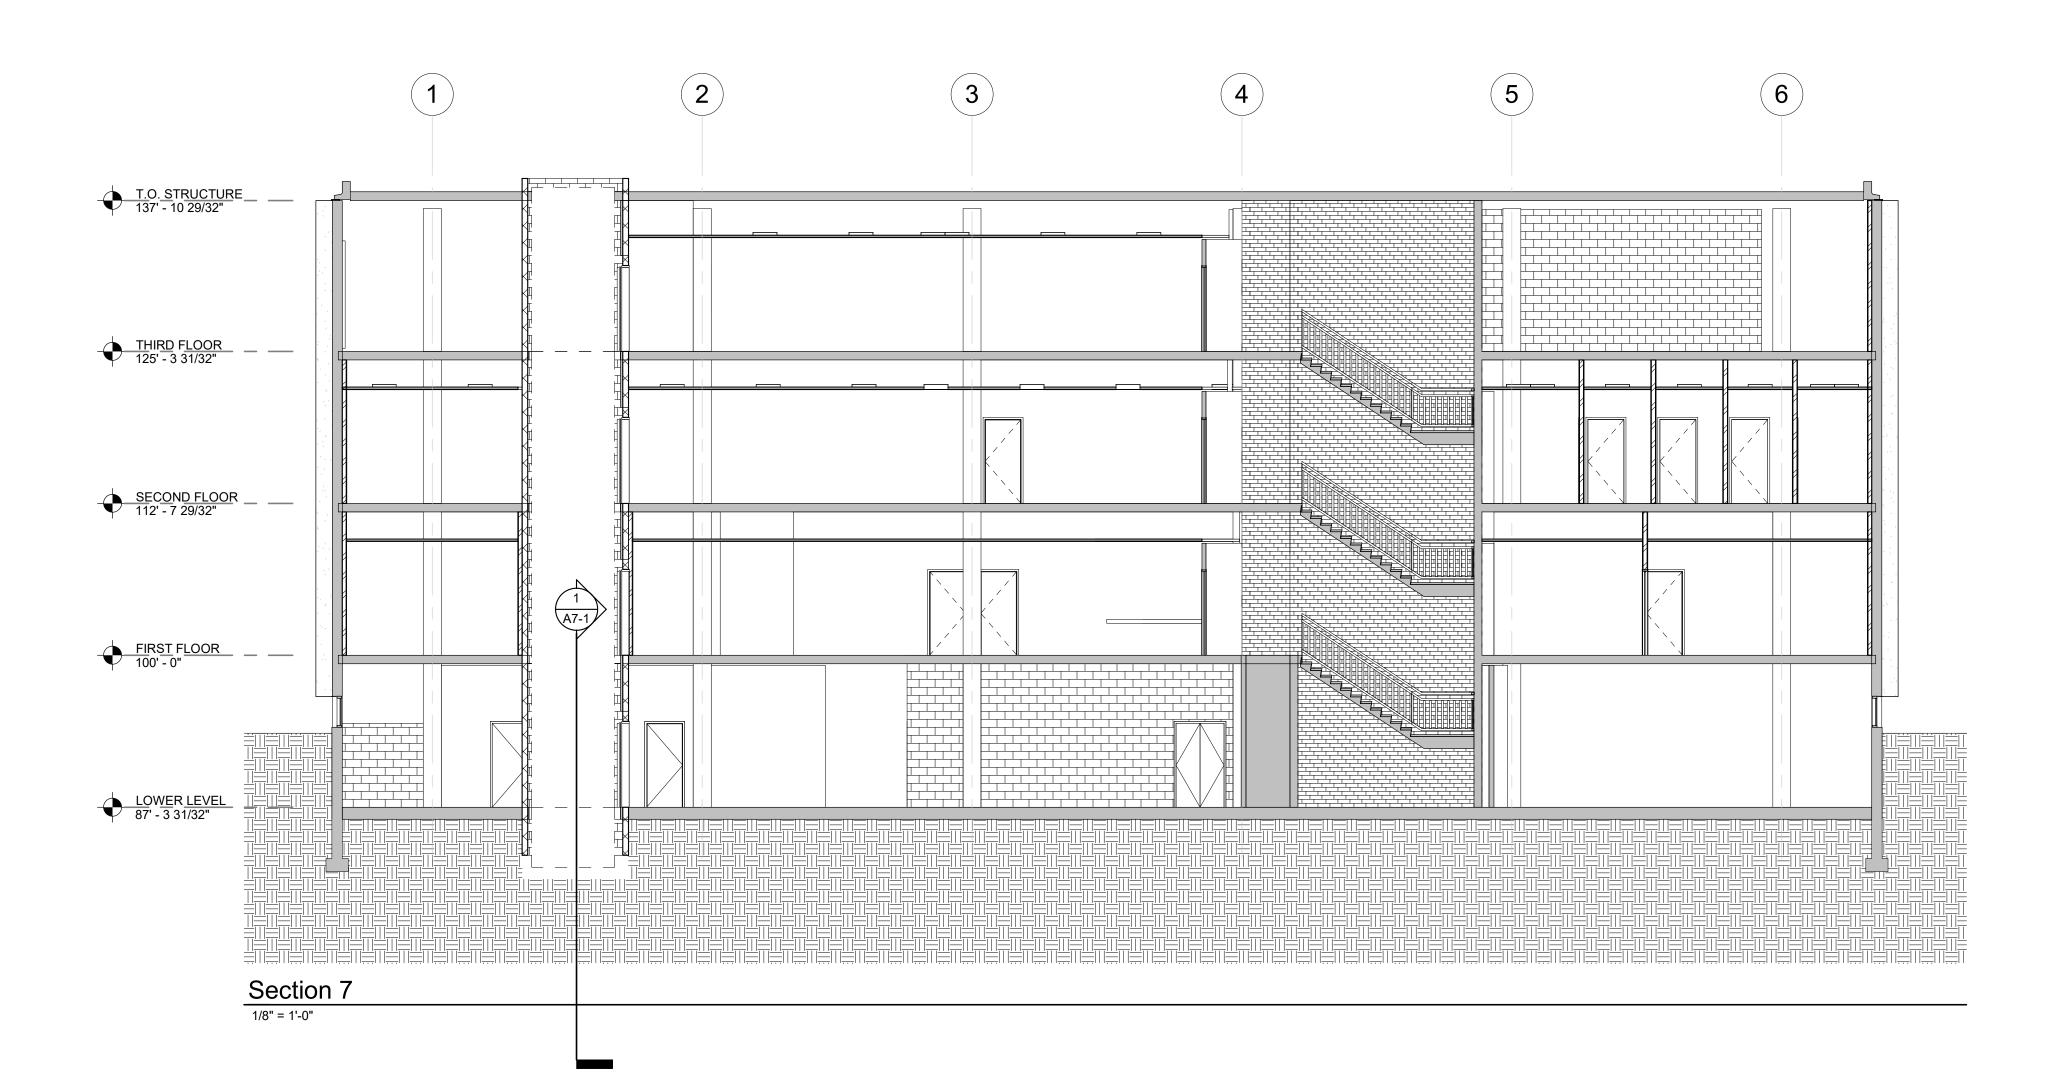

## **KEYNOTE SCHEDULE**

СО
Arch <b>OP</b>
1108 S. Main St. 102 Aberdeen, SD 57401 Phone: 605-725-4852 601 Kansas City St. 7 Rapid City, SD 57701 Phone: 605-716-3652 300 N. Phillips Ave. 120 Sioux Falls, SD 57104 Phone: 605-334-9999 co-oparch.com
STRANG DESIGN SYNCHRONICITY
811 East Washington Ave. 200 Madison, WI 53703 Phone: 608-276-9200 W238N1610 Busse Rd. 102 Waukesha, WI 53188 Phone: 262-875-6760 strang-inc.com
CO-OP PROJECT NO: 1936
PRELIMINARY NOT FOR CONSTRUCTION
ISSUE: 11-04-2020 DESIGN DEVELOPMENT REVISION SCHEDULE: REV. # REV. DSC. REV. DATE
PROJECT: SDSMT DEVEREAUX LIBRARY SOUTH DAKOTA SCHOOL OF MINES AND TECHNOLOGY RAPID CITY, SOUTH DAKOTA
<u>SHEET TITLE:</u> BUILDING SECTIONS & DETAILS
A6-2




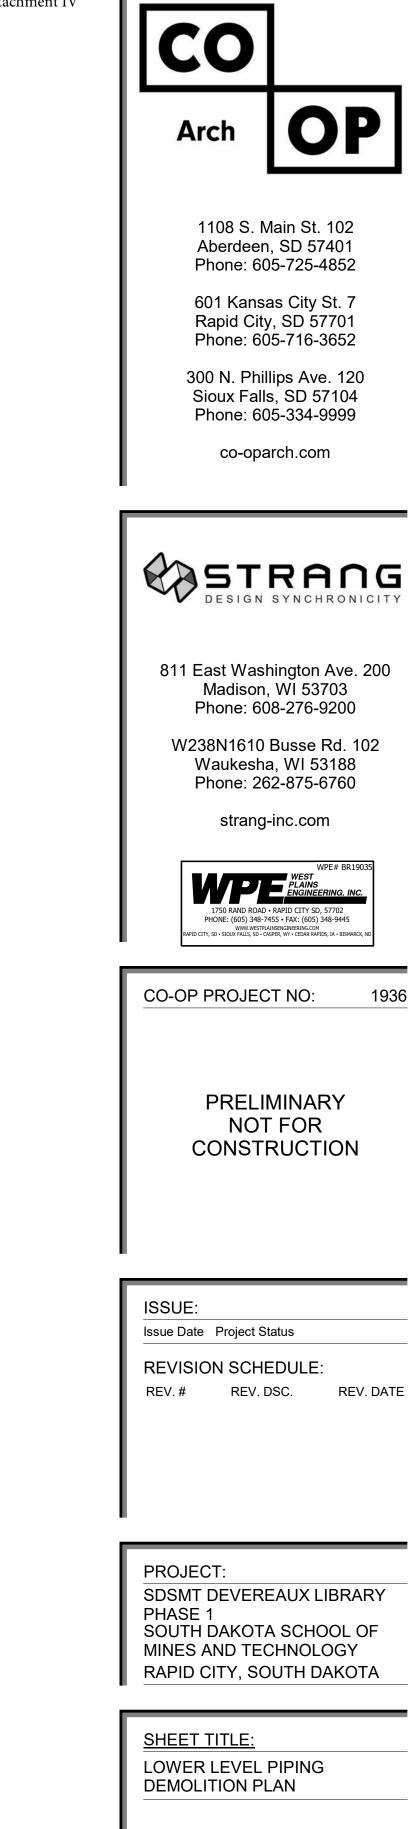

M1-0

GENERAL MECHANICAL NOTES

- A COORDINATE PHASING AND REMOVAL OF EXISTING PIPING, FIXTURES, AND EQUIPMENT WITH OWNER.
- B REMOVE EXISTING PIPING, ETC. WHERE INDICATED DASHED. CAP PIPING DURING CONSTRUCTION.
- C CONTRACTOR TO CONFIRM LOCATIONS OF EXISTING PIPING AND EQUIPMENT. (#) MECHANICAL SPECIFIC NOTES
- M100 REMOVE EXISTING 4" SAN, 1-1/2" CW, 4" VENT, AND 4" ST PIPING FROM EXISTING ELEVATOR SHAFT.
- M101 REMOVE EXISTING PLUMBING FIXTURES WITHIN THIS AREA.

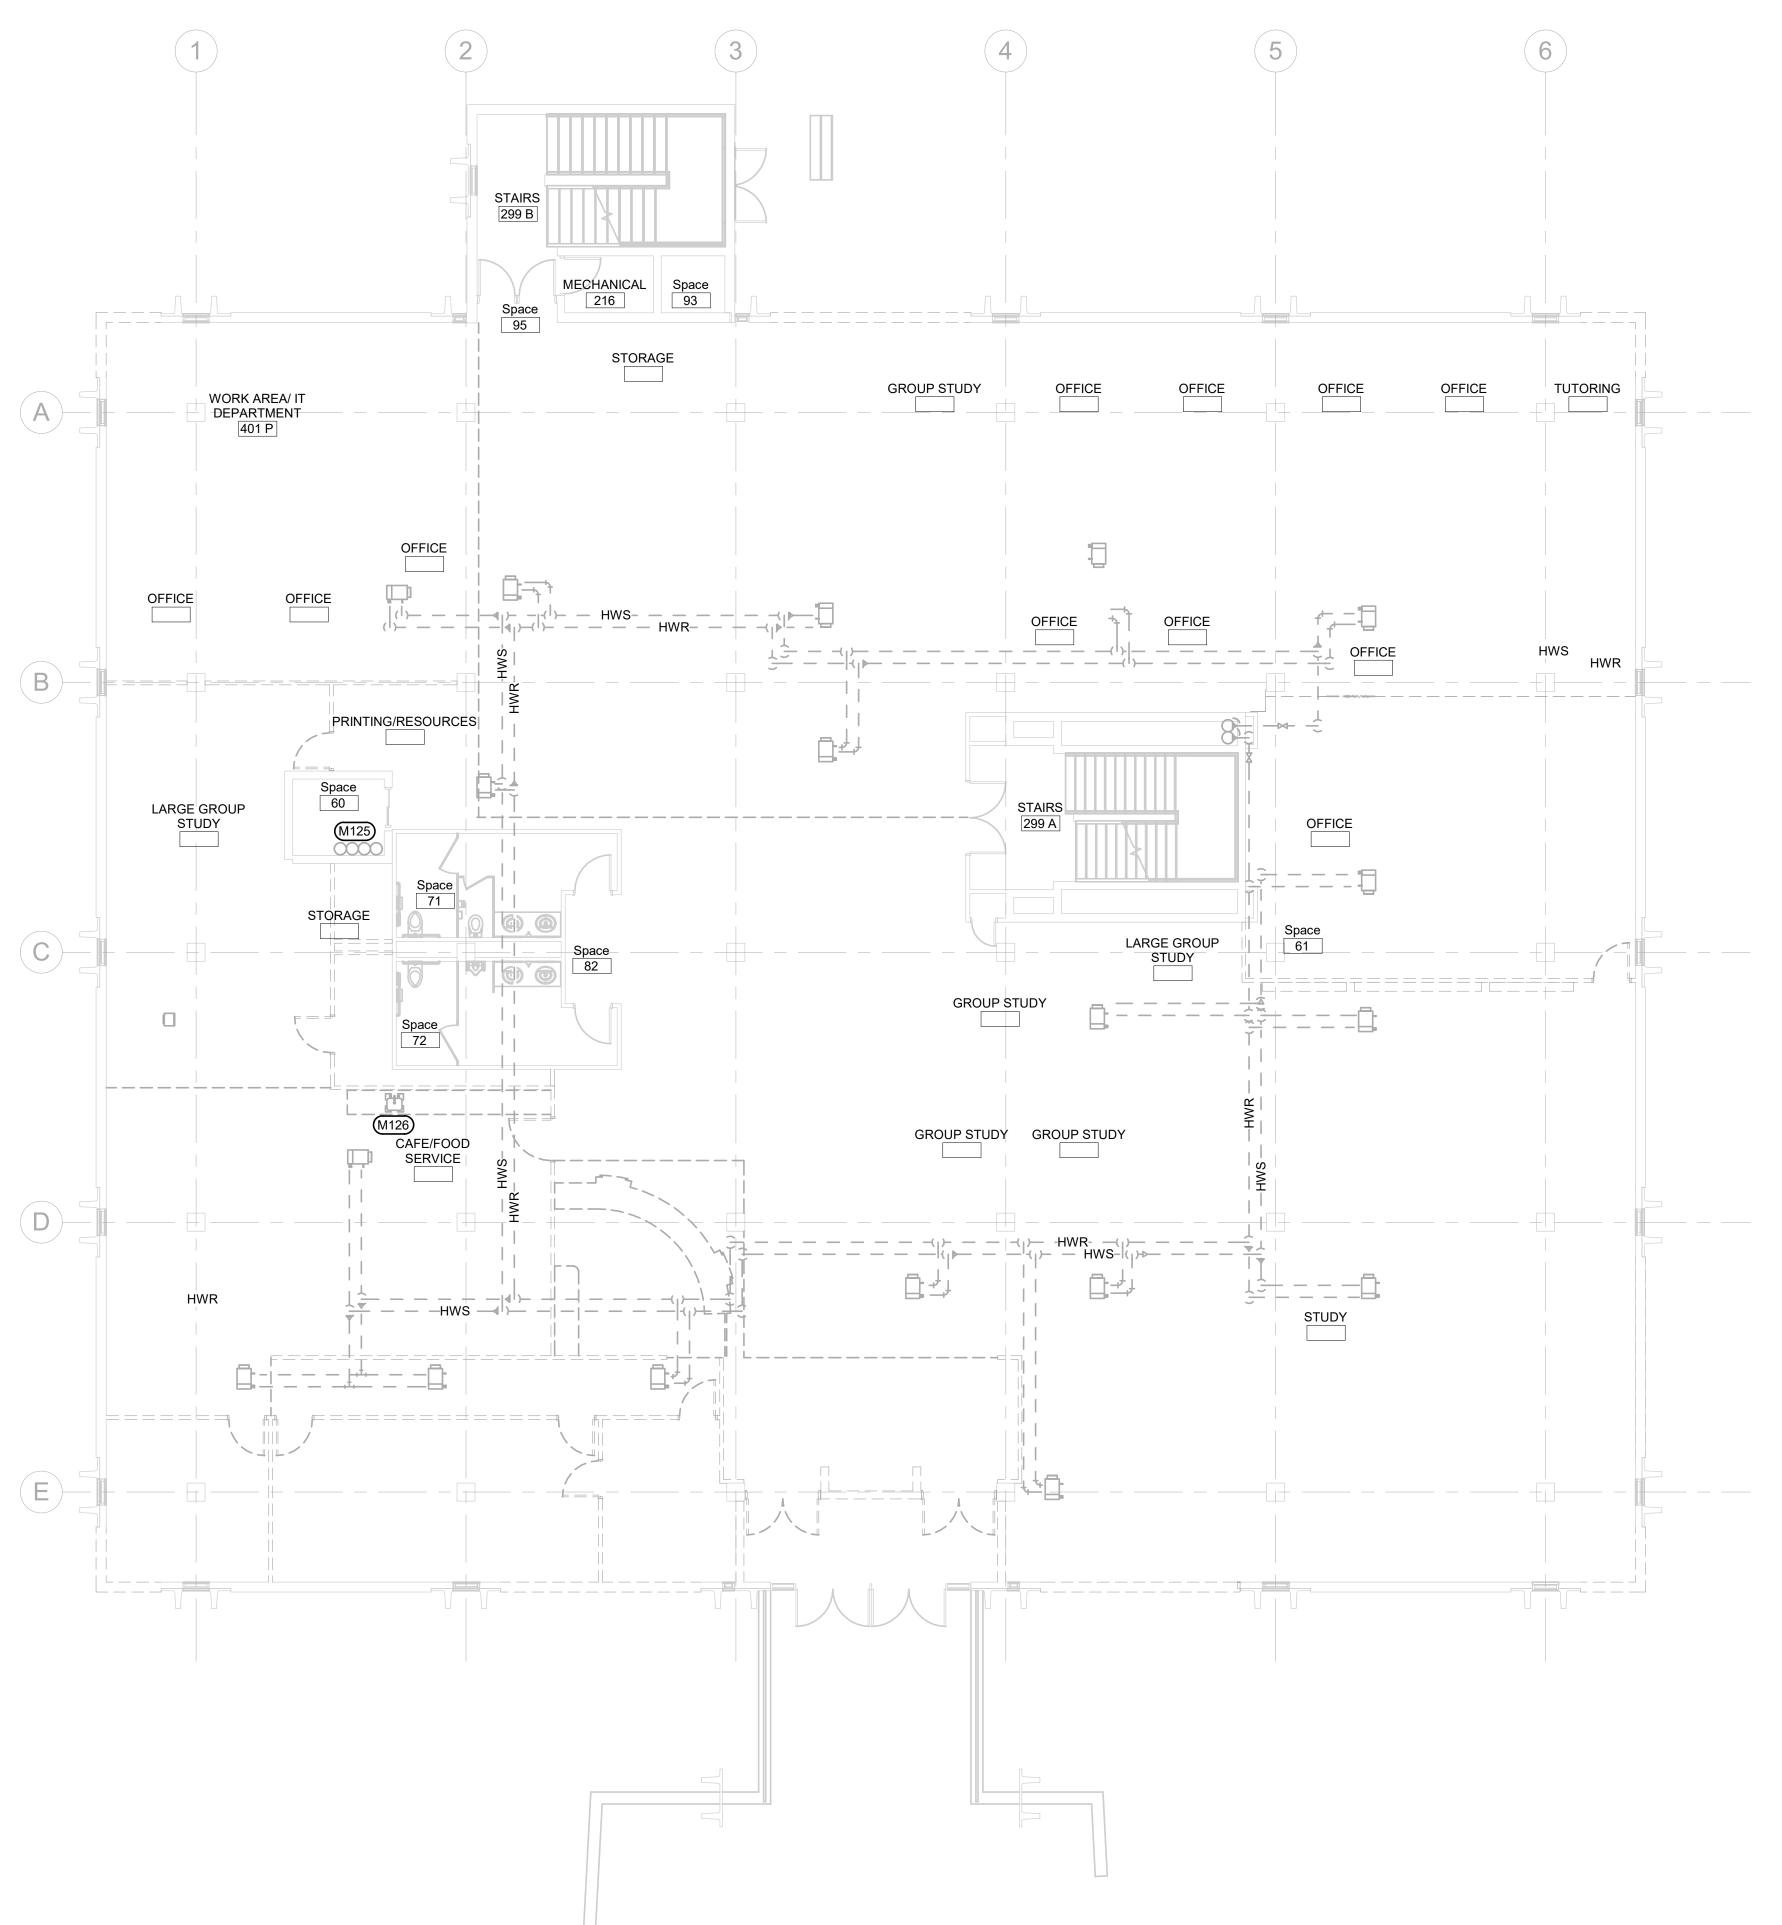




	CO	
	Arch	OP
		lain St. 102
_	Phone: 60 601 Kansa	, SD 57401 5-725-4852 as City St. 7 r, SD 57701
	Phone: 60 300 N. Phill Sioux Falls	5-716-3652 ips Ave. 120 s, SD 57104
<del>1"</del> IS		5-334-9999 rch.com
		RANG
	Madison,	nington Ave. 200 WI 53703 8-276-9200
	Waukesha	Busse Rd. 102 a, WI 53188 2-875-6760
	WPI	WPE# BR19035
	WWW.WESTPLA	55 - FAX: (605) 348-9445 NSENGINEERING.COM PER, WY - CEDAR RAPIDS, IA - BISMARCK, ND
	PRELII	MINARY FOR RUCTION
	ISSUE: Issue Date Project St	atus
	REVISION SCHE REV. # REV. D	EDULE: ISC. REV. DATE
	PROJECT: SDSMT DEVERE PHASE 1 SOUTH DAKOTA MINES AND TEC RAPID CITY, SO	A SCHOOL OF CHNOLOGY
	<u>SHEET TITLE:</u> FIRST FLOOR P DEMOLITION PL	
	M	1-1


## GENERAL MECHANICAL NOTES

- A COORDINATE PHASING AND REMOVAL OF EXISTING PIPING, FIXTURES, AND EQUIPMENT WITH OWNER.
- B REMOVE EXISTING PIPING, ETC. WHERE INDICATED DASHED. CAP PIPING DURING CONSTRUCTION.
- C CONTRACTOR TO CONFIRM LOCATIONS OF EXISTING PIPING AND EQUIPMENT.


 
 #
 MECHANICAL SPECIFIC NOTES

 M125
 REMOVE EXISTING 4" SAN, 1-1/2" CW, 4" VENT, AND 4"
 ST PIPING FROM EXISTING ELEVATOR SHAFT. M126 REMOVE EXISTING PLUMBING FIXTURES WITHIN THIS AREA.

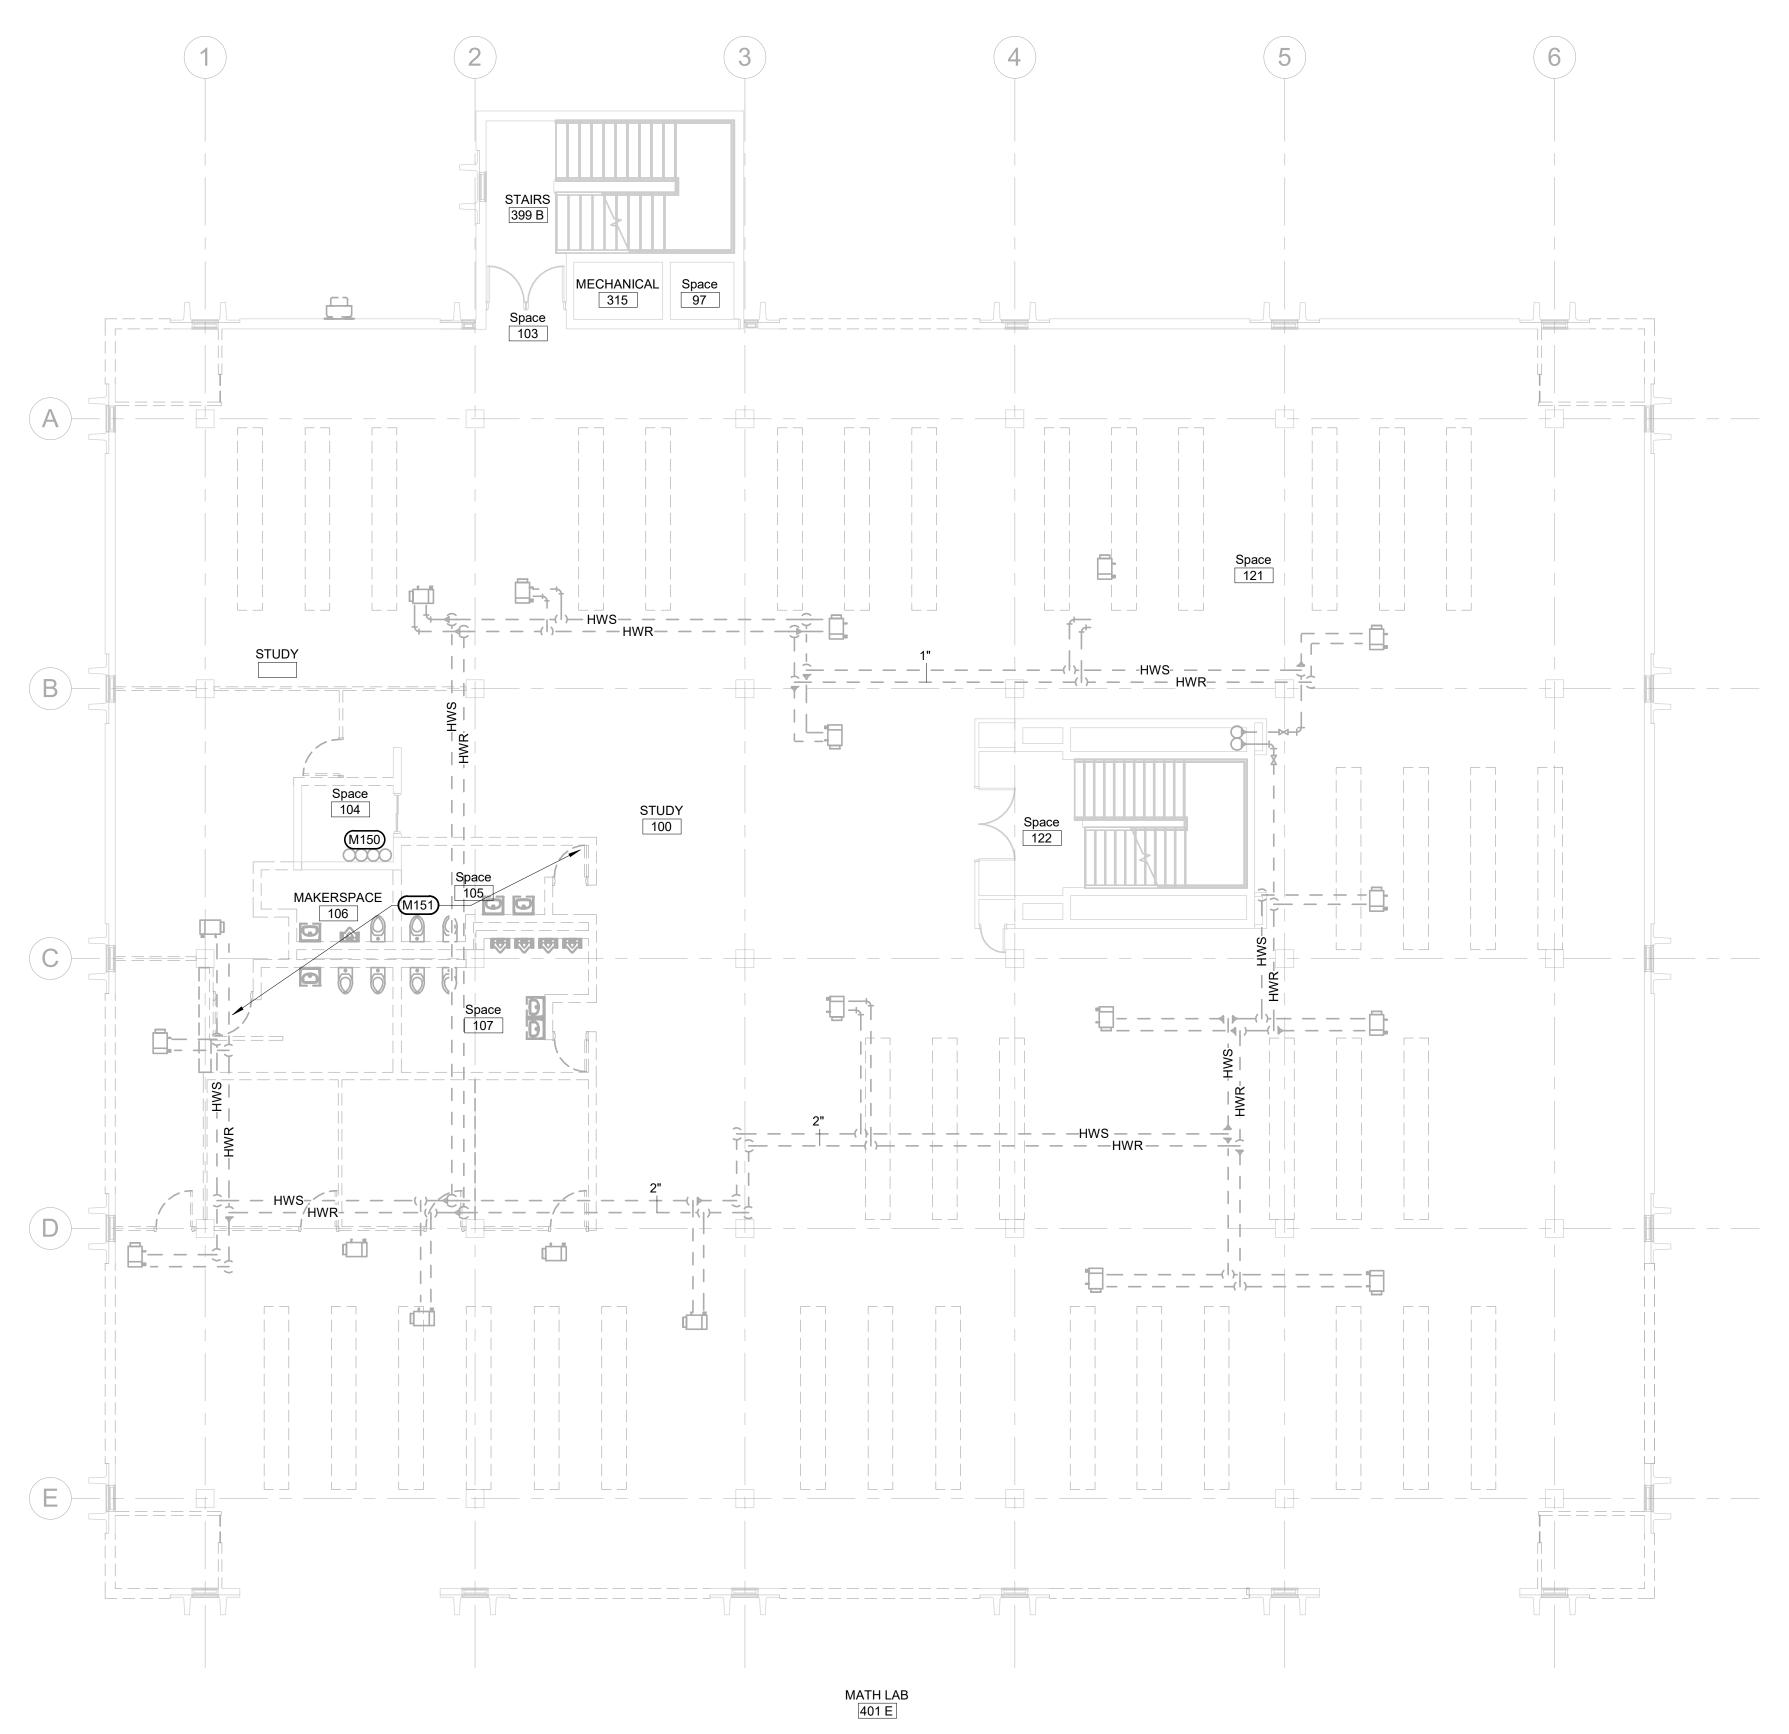

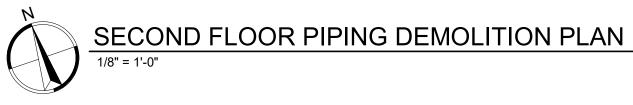


	CO
	Arch <b>OP</b>
	1108 S. Main St. 102 Aberdeen, SD 57401 Phone: 605-725-4852 601 Kansas City St. 7
GENERAL MECHANICAL NOTES	Rapid City, SD 57701 Phone: 605-716-3652 300 N. Phillips Ave. 120 Sioux Falls, SD 57104 Phone: 605-334-9999
COORDINATE PHASING AND REMOVAL OF EXISTING PIPING, FIXTURES, AND EQUIPMENT WITH OWNER. REMOVE EXISTING PIPING, ETC. WHERE INDICATED DASHED. CAP PIPING DURING CONSTRUCTION. CONTRACTOR TO CONFIRM LOCATIONS OF EXISTING PIPING AND EQUIPMENT.	co-oparch.com
#         MECHANICAL SPECIFIC NOTES           M150         REMOVE EXISTING 4" SAN, 1-1/2" CW, 4" VENT, AND 4" ST PIPING FROM EXISTING ELEVATOR SHAFT.           M151         REMOVE EXISTING PLUMBING FIXTURES WITHIN THIS AREA.	STRANG DESIGN SYNCHRONICITY
	811 East Washington Ave. 200 Madison, WI 53703 Phone: 608-276-9200
	W238N1610 Busse Rd. 102 Waukesha, WI 53188 Phone: 262-875-6760 strang-inc.com
	WPE# BR19035 WEST PLAINS PLAIN
	CO-OP PROJECT NO: 1936
	PRELIMINARY NOT FOR CONSTRUCTION
	ISSUE: Issue Date Project Status
	REVISION SCHEDULE: REV. # REV. DSC. REV. DATE
	PROJECT: SDSMT DEVEREAUX LIBRARY PHASE 1 SOUTH DAKOTA SCHOOL OF MINES AND TECHNOLOGY RAPID CITY, SOUTH DAKOTA
	<u>SHEET TITLE:</u> SECOND FLOOR PIPING DEMOLITION PLAN
	M1-2

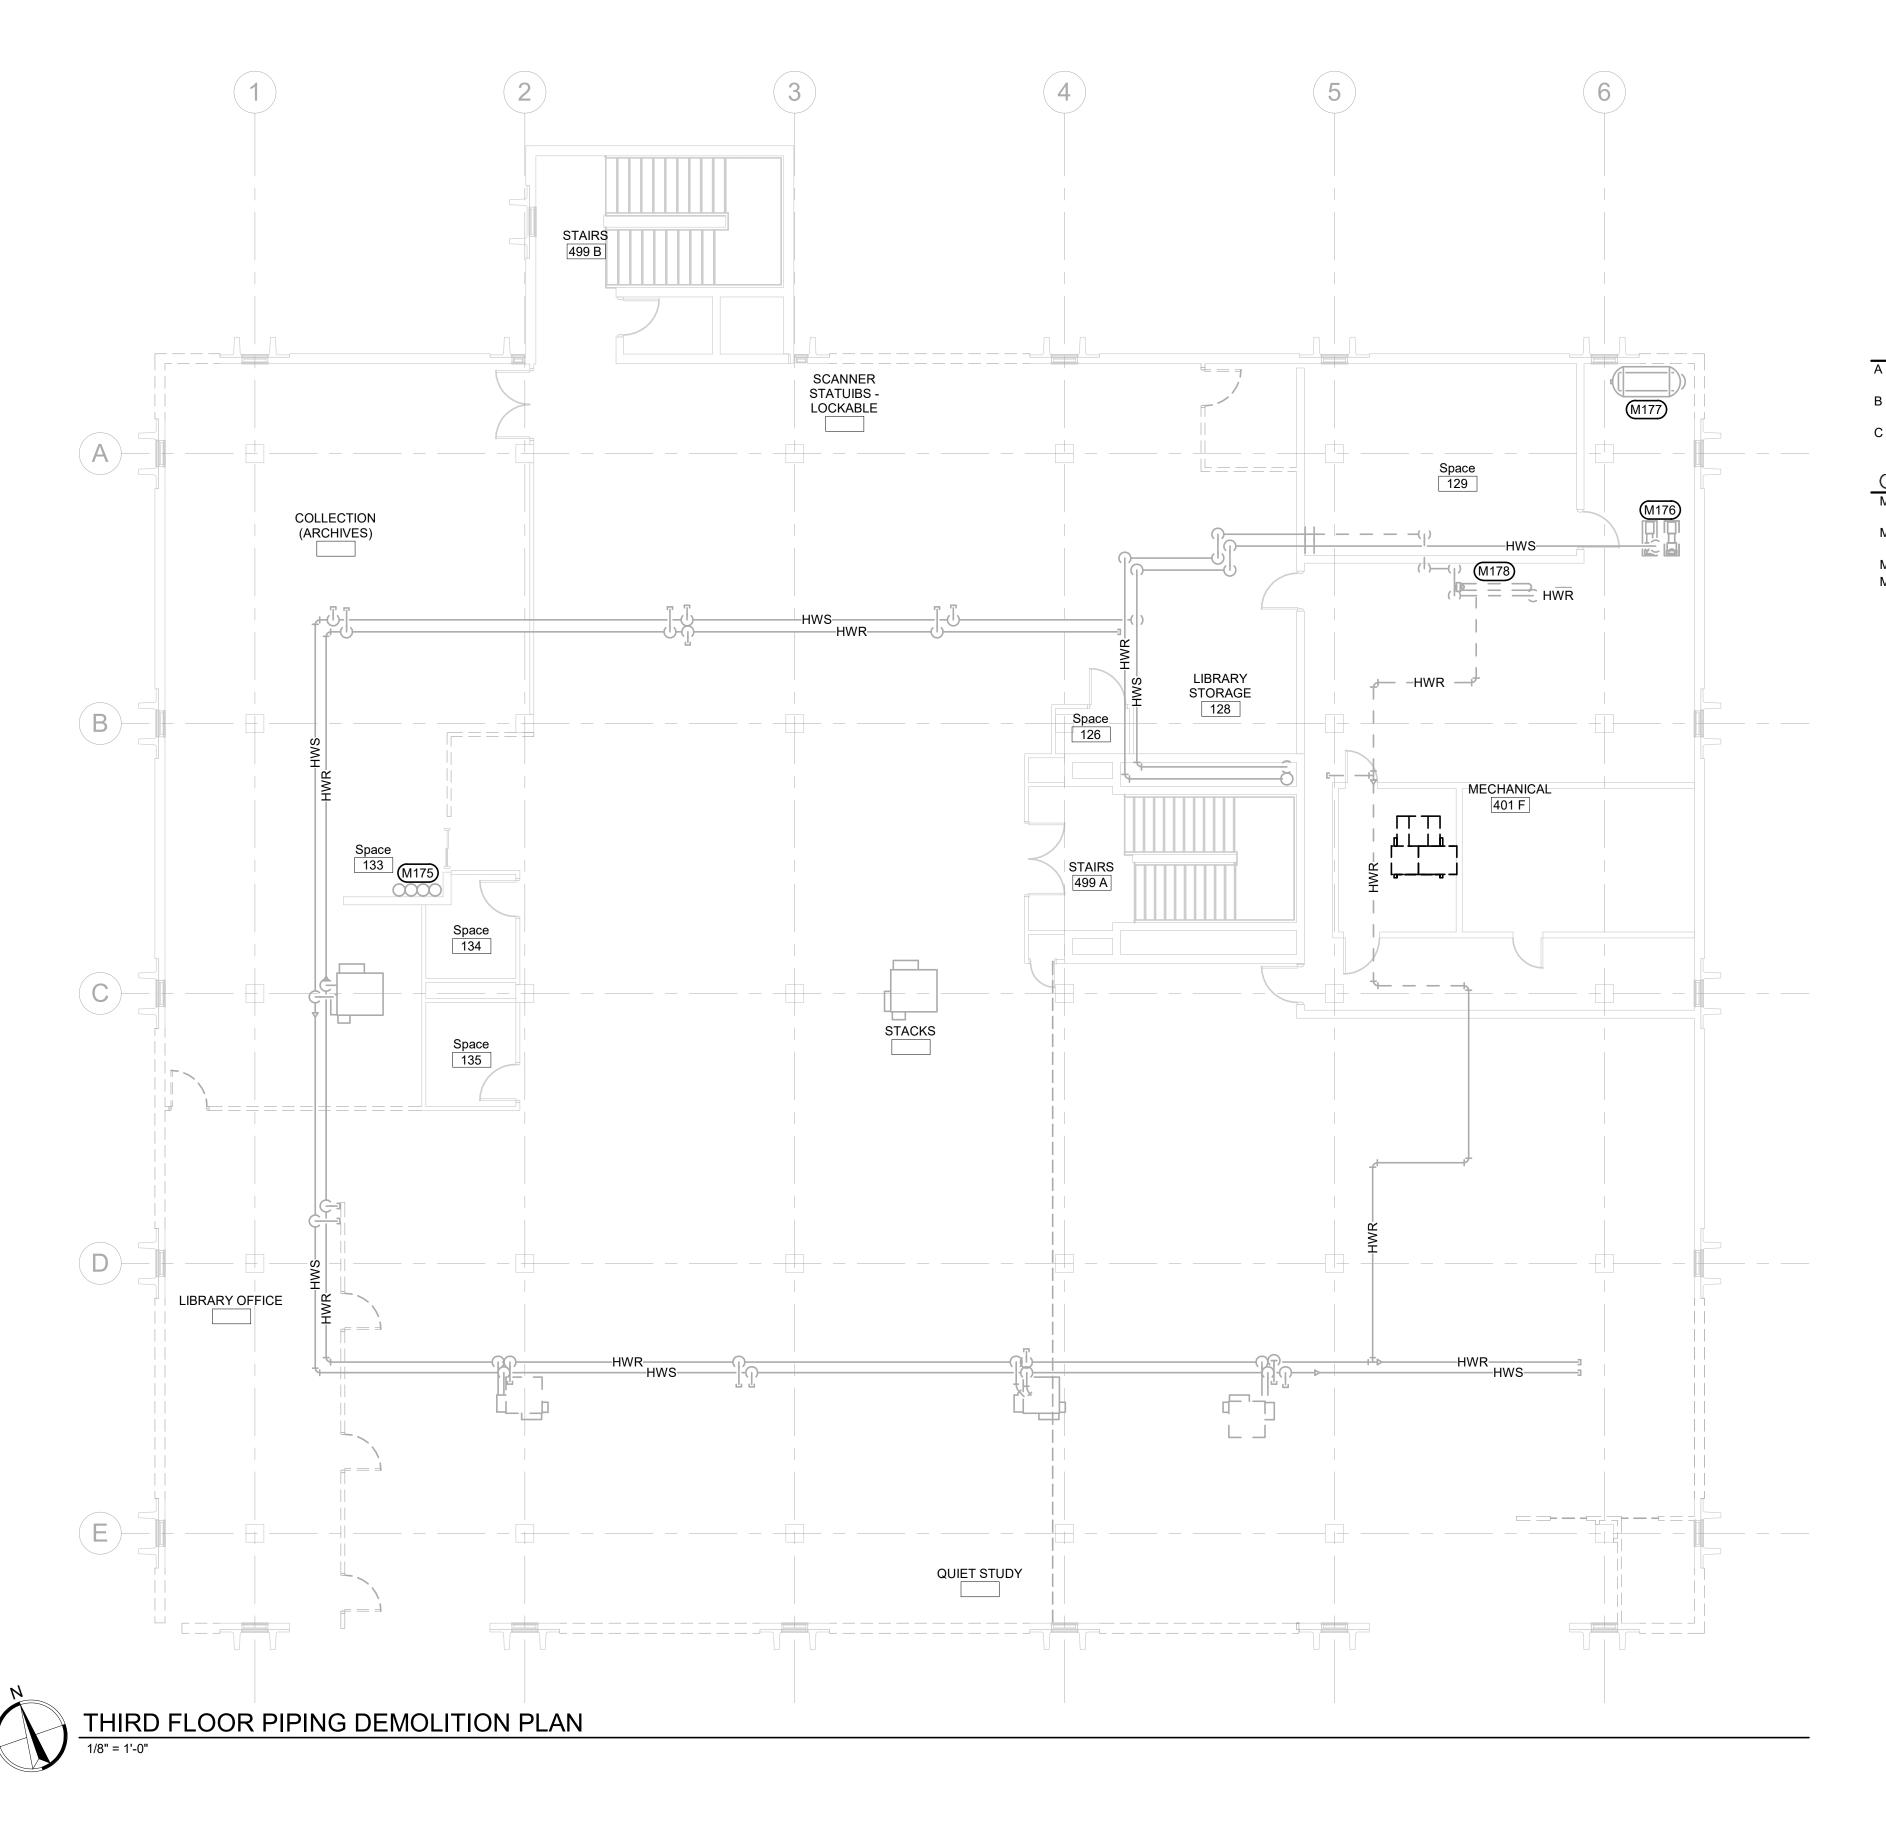

	CO Arch OP
GENERAL MECHANICAL NOTES	1108 S. Main St. 102 Aberdeen, SD 57401 Phone: 605-725-4852 601 Kansas City St. 7 Rapid City, SD 57701 Phone: 605-716-3652 300 N. Phillips Ave. 120 Sioux Falls, SD 57104 Phone: 605-334-9999
<ul> <li>COORDINATE PHASING AND REMOVAL OF EXISTING PIPING, FIXTURES, AND EQUIPMENT WITH OWNER.</li> <li>REMOVE EXISTING PIPING, ETC. WHERE INDICATED DASHED. CAP PIPING DURING CONSTRUCTION.</li> <li>CONTRACTOR TO CONFIRM LOCATIONS OF EXISTING PIPING AND EQUIPMENT.</li> </ul>	co-oparch.com
#         MECHANICAL SPECIFIC NOTES           M175         REMOVE EXISTING 4" SAN, 1-1/2" CW, 4" VENT, AND 4" ST PIPING FROM EXISTING ELEVATOR SHAFT.           M176         REMOVE EXISTING CHILLED WATER AND HEATING WATER PUMPS.           M177         REMOVE EXISTING EXPANSION TANKS.	STRANG DESIGN SYNCHRONICITY
M178 REMOVE EXISTING STEAM TO HOT WATER CONVERTER.	811 East Washington Ave. 200 Madison, WI 53703 Phone: 608-276-9200 W238N1610 Busse Rd. 102
	Waukesha, WI 53188 Phone: 262-875-6760 strang-inc.com
	WEST PLAINS ENGINEERING. INC. 1750 RAND ROAD • RAPID CITY SD, 57702 PHONE: (605) 348-7455 • FAX: (605) 348-9445 www.westplaineenaine
	CO-OP PROJECT NO: 1936
	PRELIMINARY NOT FOR CONSTRUCTION
	ISSUE: Issue Date Project Status REVISION SCHEDULE: REV. # REV. DSC. REV. DATE
	PROJECT: SDSMT DEVEREAUX LIBRARY PHASE 1 SOUTH DAKOTA SCHOOL OF MINES AND TECHNOLOGY RAPID CITY, SOUTH DAKOTA
	<u>SHEET TITLE:</u> THIRD FLOOR PIPING DEMOLITION PLAN
	M1-3



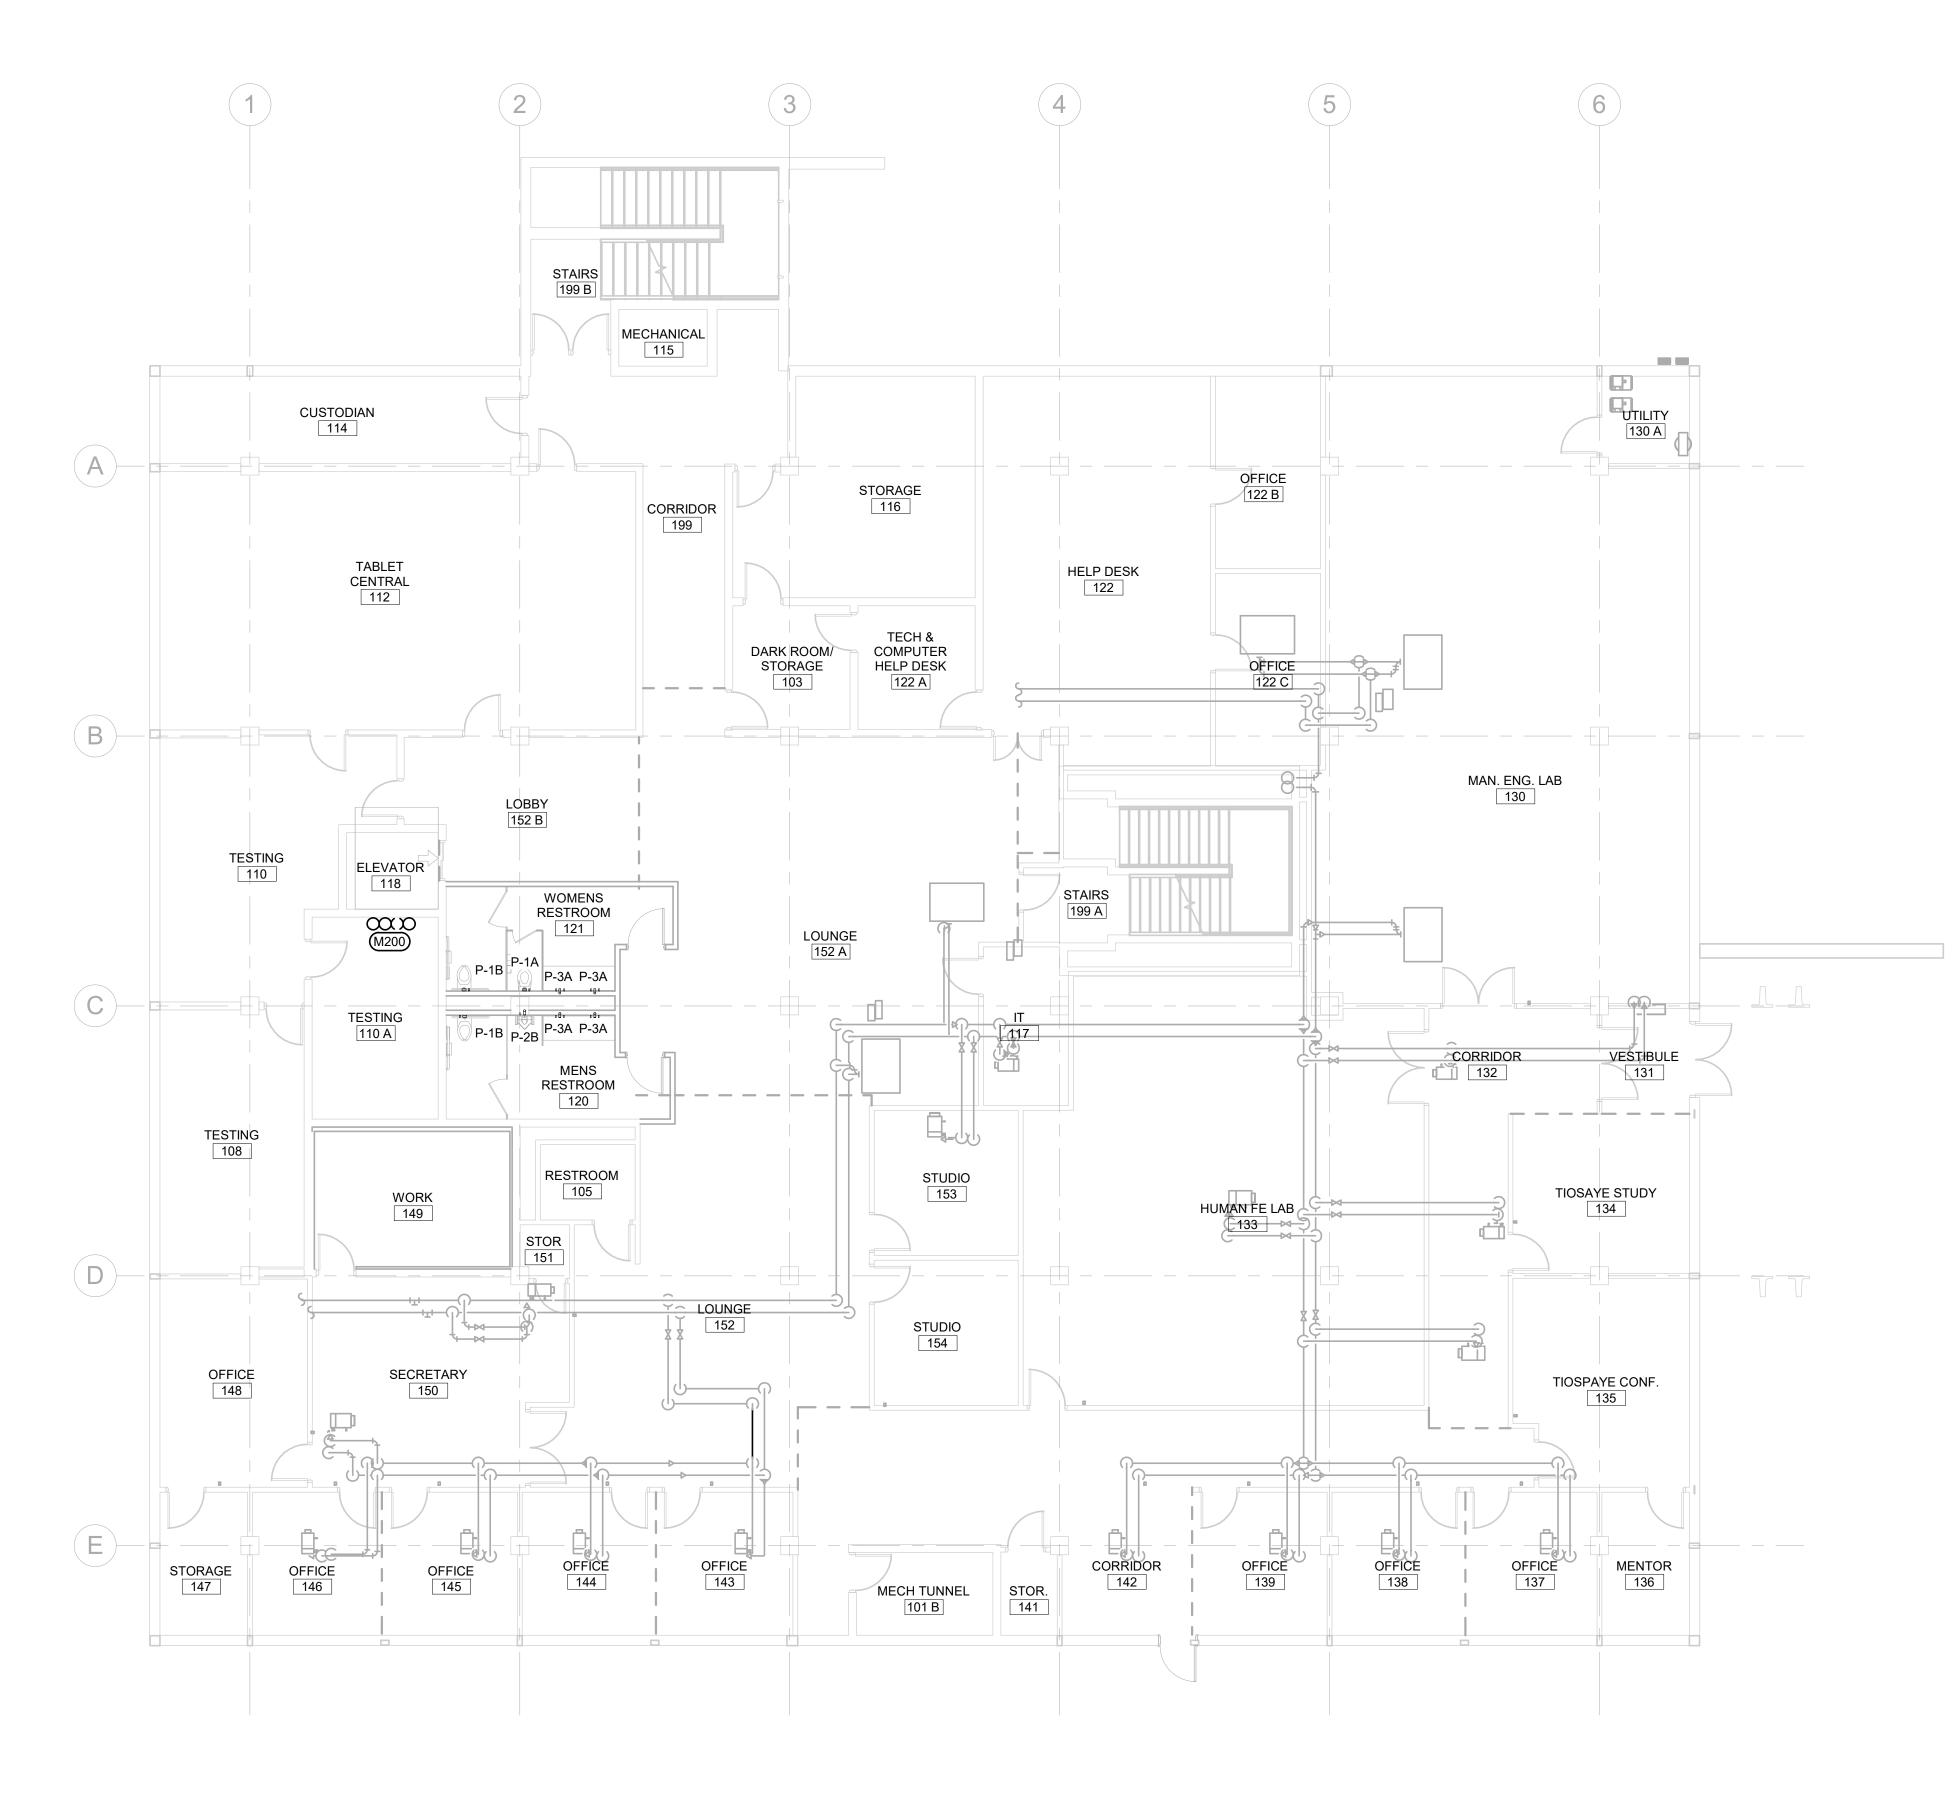

\_\_\_\_\_

GENERAL M	MECHANICAL NOTES
-----------	------------------


- A CONTRACTOR TO CONFIRM SIZE AND LOCATION OF EXISTING PIPING.
- B WORK ON THIS PROJECT WILL BE PHASED. THE MECHANICAL CONTRACTOR WILL BE RESPONSIBLE FOR ENSURING THAT AREAS OUTSIDE THE CURRENT PHASE OF WORK CONTINUE TO BE SERVED BY HEATING, COOLING, DOMESTIC WATER, SANITARY, ETC. SO AS NOT TO INTERRUPT OWNER WORK FLOW. ALL OUTAGES OF DOMESTIC WATER SHALL BE COORDINATED IN ADVANCE WITH OWNER AND WILL BE REQUIRED TO OCCUR DURING TIMES OF LOW USE. THIS WILL REQUIRE THE CONTRACTOR TO WORK OTHER THAN NORMAL WORK HOURS AT NO ADDITIONAL COST TO THE OWNER.
- C THE MECHANICAL CONTRACTOR IS TO EXTEND, MODIFY AND/OR RELOCATE ANY PIPING, THAT CONTINUES TO SERVE THE SPACE, AS NEEDED SO THAT ALL NEW ARCHITECTURAL, MECHANICAL AND ELECTRICAL WORK SHOWN IN THE REMODEL PLANS CAN BE INSTALLED.
- D ALL PIPING INSULATION SERVING SERVING DOMESTIC COLD WATER PIPING AND CHILLED WATER PIPING SHALL BE INSTALLED WITH UNBROKEN VAPOR BARRIERS AS PER SPECIFICATIONS. CONTRACTOR TO USE METAL SADDLES AND STRAPS ON EXTERIOR OF INSULATION FOR SUPPORT OF PIPING AT HANGERS, UNISTRUT, ETC.
- E ISOLATE ALL COPPER PIPES FROM BEARING ON FERROUS HANGERS, ETC. WITH ELECTRICALLY INSULATING MATERIALS AS SPECIFIED. USE DIELECTRIC UNIONS IN CONNECTION OF ALL COPPER PIPING TO FERROUS PIPING AS SPECIFIED.
- #
   MECHANICAL SPECIFIC NOTES


   M200
   INSTALL NEW 4" SAN, 1-1/2" CW, 4" VENT, AND 4" ST PIPING. CONNECT TO EXISTING WITHIN THIS AREA.

CO
Arch <b>OP</b>
1108 S. Main St. 102 Aberdeen, SD 57401 Phone: 605-725-4852
601 Kansas City St. 7 Rapid City, SD 57701 Phone: 605-716-3652
300 N. Phillips Ave. 120 Sioux Falls, SD 57104 Phone: 605-334-9999
co-oparch.com
STRANG DESIGN SYNCHRONICITY
811 East Washington Ave. 200 Madison, WI 53703 Phone: 608-276-9200
W238N1610 Busse Rd. 102 Waukesha, WI 53188 Phone: 262-875-6760
strang-inc.com
WPE# BR19035 WEST PLAINS ENGINEERING. INC. 1750 RAND ROAD • RAPID CITY SD, 57702 PHONE: (605) 348-7455 • FAX: (605) 348-9445 WWW.WESTMAINSENGINEERING.COM RAPID CITY, SD • SIOUX FALLS, SD • CASPER. W1 • CEDAR RAPIDS, IA • BISMARCK, ND
CO-OP PROJECT NO: 1936
PRELIMINARY NOT FOR CONSTRUCTION
ISSUE: Issue Date Project Status
REVISION SCHEDULE: REV. # REV. DSC. REV. DATE
PROJECT: SDSMT DEVEREAUX LIBRARY PHASE 1 SOUTH DAKOTA SCHOOL OF MINES AND TECHNOLOGY RAPID CITY, SOUTH DAKOTA

<u>SHEET TITLE:</u> LOWER LEVEL PIPING PLAN

M2-0

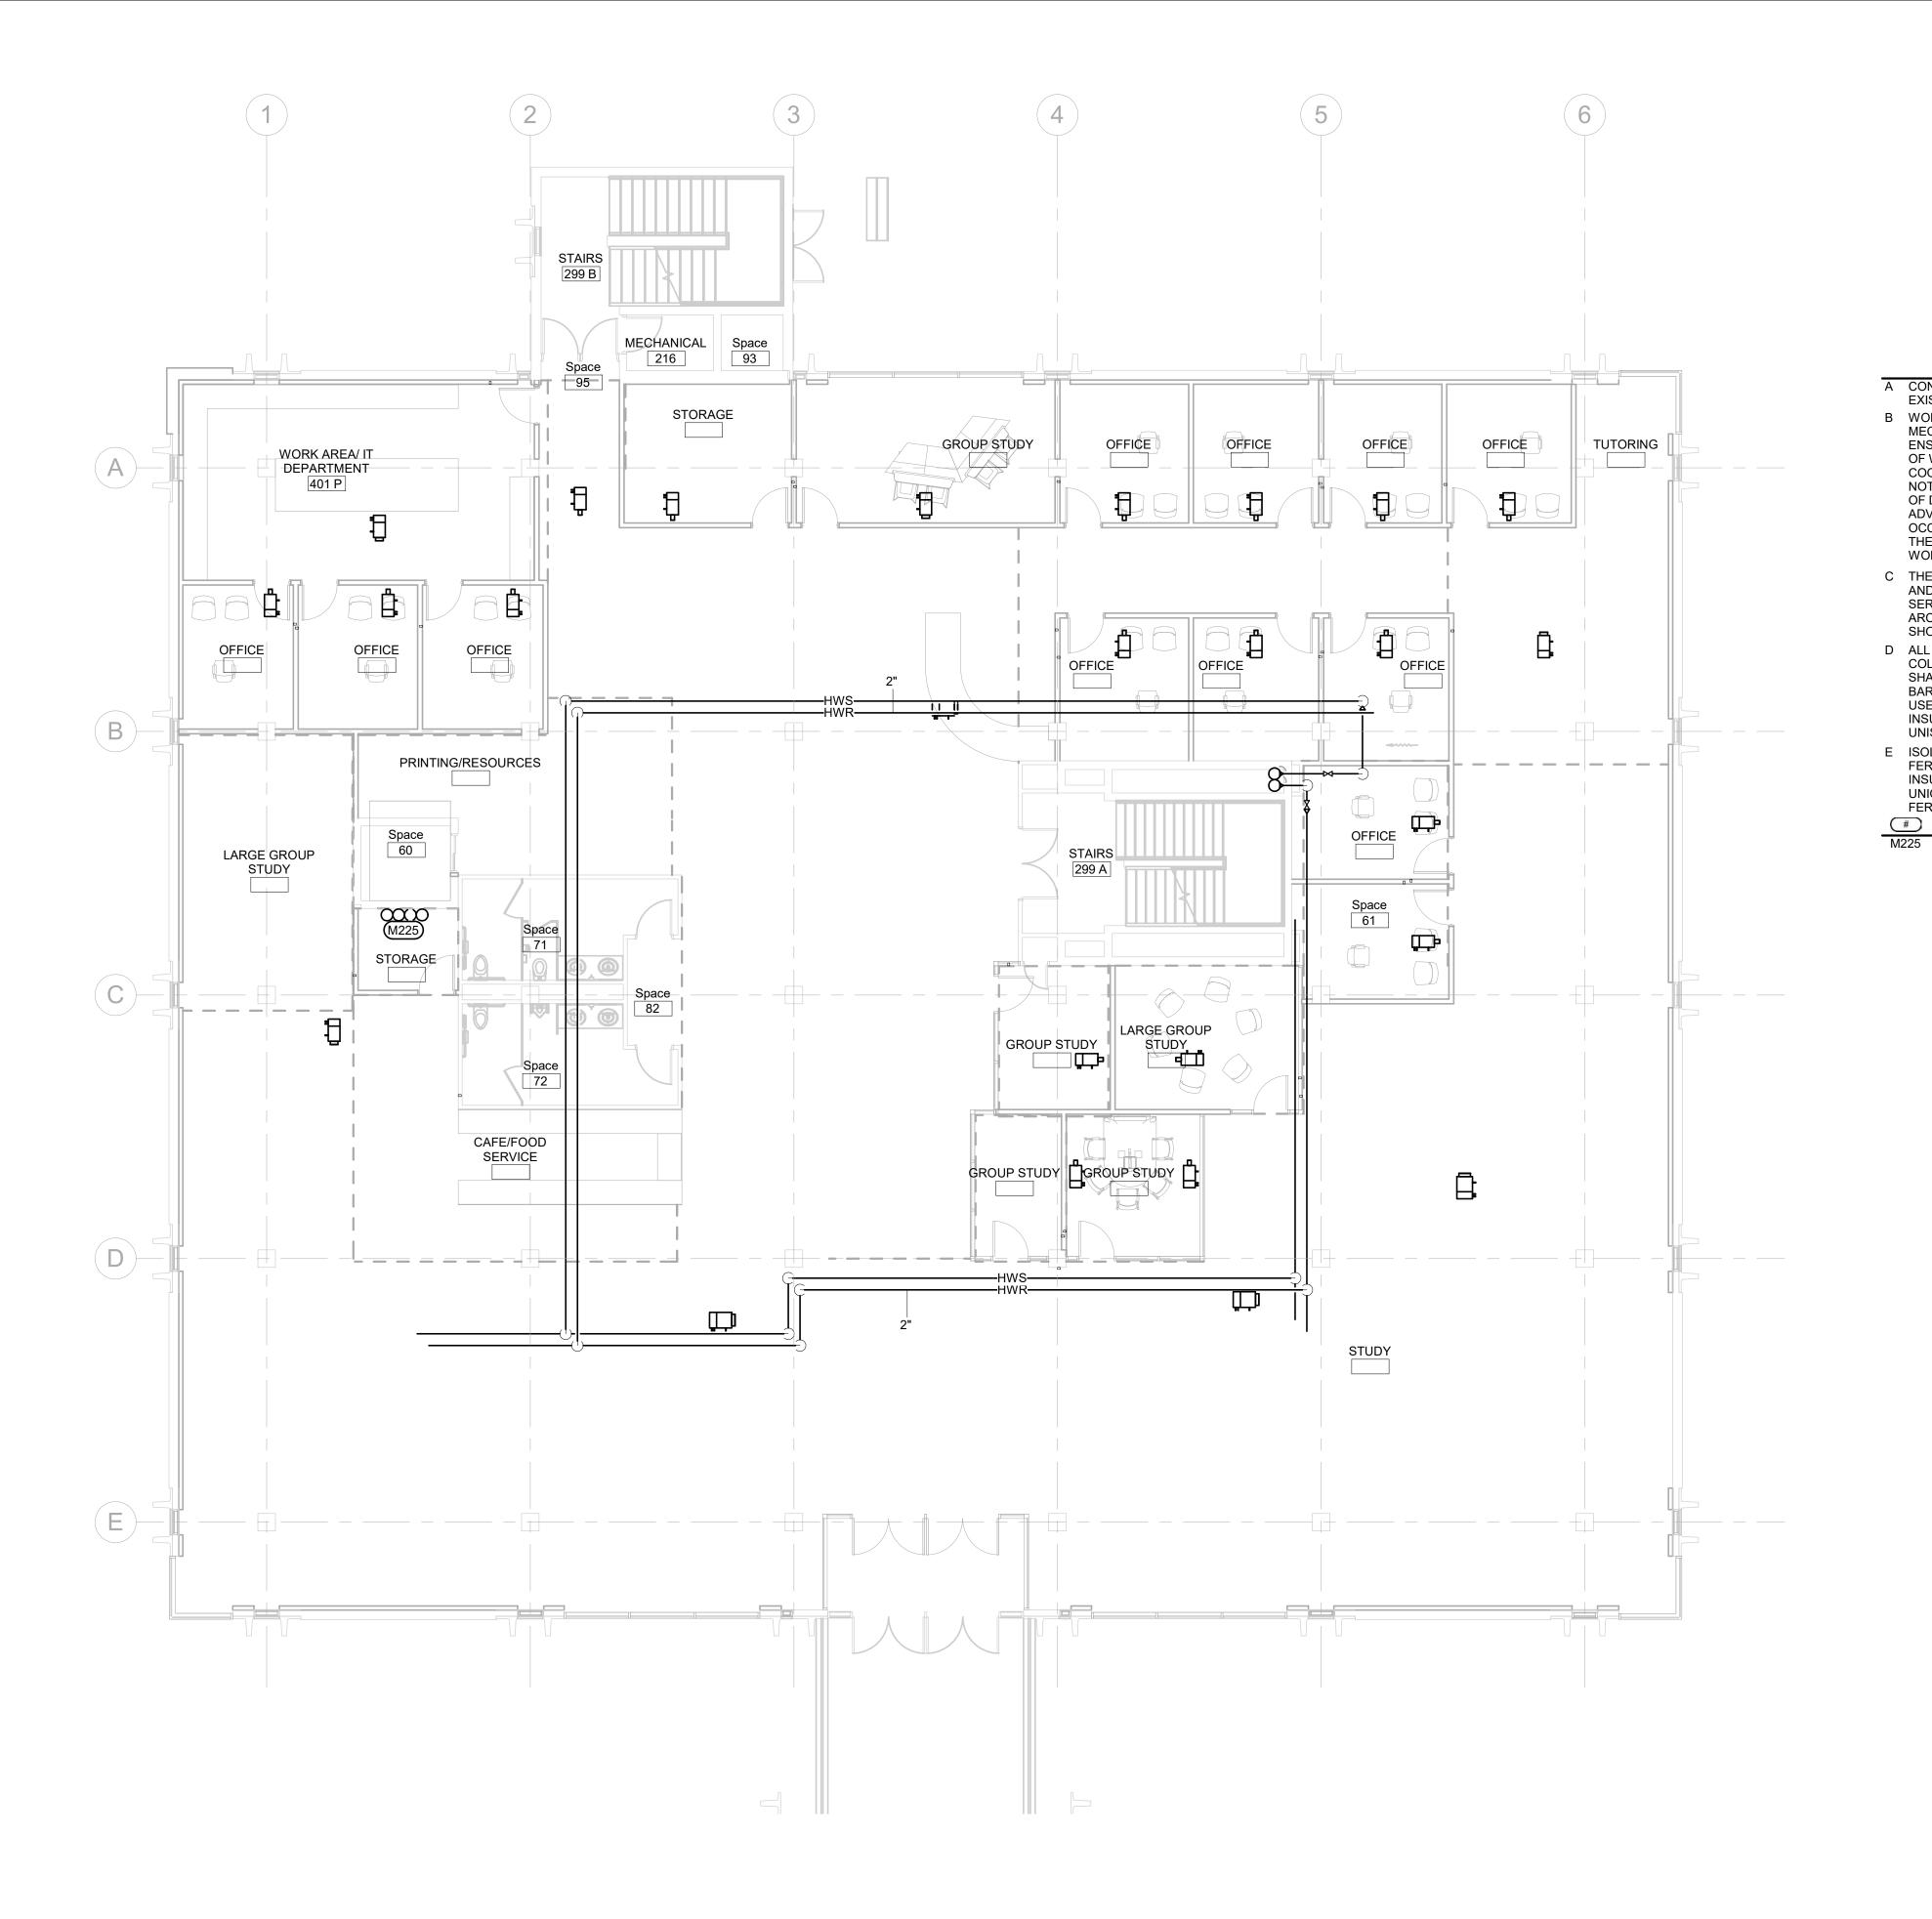

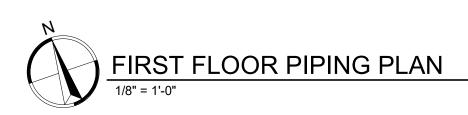


OP Arch 1108 S. Main St. 102 Aberdeen, SD 57401 Phone: 605-725-4852 601 Kansas City St. 7 **GENERAL MECHANICAL NOTES** Rapid City, SD 57701 A CONTRACTOR TO CONFIRM SIZE AND LOCATION OF Phone: 605-716-3652 B WORK ON THIS PROJECT WILL BE PHASED. THE MECHANICAL CONTRACTOR WILL BE RESPONSIBLE FOR 300 N. Phillips Ave. 120 ENSURING THAT AREAS OUTSIDE THE CURRENT PHASE Sioux Falls, SD 57104 OF WORK CONTINUE TO BE SERVED BY HEATING, Phone: 605-334-9999 COOLING, DOMESTIC WATER, SANITARY, ETC. SO AS NOT TO INTERRUPT OWNER WORK FLOW. ALL OUTAGES OF DOMESTIC WATER SHALL BE COORDINATED IN co-oparch.com ADVANCE WITH OWNER AND WILL BE REQUIRED TO OCCUR DURING TIMES OF LOW USE. THIS WILL REQUIRE THE CONTRACTOR TO WORK OTHER THAN NORMAL WORK HOURS AT NO ADDITIONAL COST TO THE OWNER. C THE MECHANICAL CONTRACTOR IS TO EXTEND, MODIFY AND/OR RELOCATE ANY PIPING. THAT CONTINUES TO SERVE THE SPACE, AS NEEDED SO THAT ALL NEW STRANG DESIGN SYNCHRONICITY ARCHITECTURAL, MECHANICAL AND ELECTRICAL WORK SHOWN IN THE REMODEL PLANS CAN BE INSTALLED. D ALL PIPING INSULATION SERVING SERVING DOMESTIC COLD WATER PIPING AND CHILLED WATER PIPING SHALL BE INSTALLED WITH UNBROKEN VAPOR BARRIERS AS PER SPECIFICATIONS. CONTRACTOR TO USE METAL SADDLES AND STRAPS ON EXTERIOR OF 811 East Washington Ave. 200 INSULATION FOR SUPPORT OF PIPING AT HANGERS, Madison, WI 53703 E ISOLATE ALL COPPER PIPES FROM BEARING ON Phone: 608-276-9200 FERROUS HANGERS, ETC. WITH ELECTRICALLY INSULATING MATERIALS AS SPECIFIED. USE DIELECTRIC W238N1610 Busse Rd. 102 UNIONS IN CONNECTION OF ALL COPPER PIPING TO Waukesha, WI 53188 MECHANICAL SPECIFIC NOTES Phone: 262-875-6760 M225 INSTALL NEW 4" SAN, 1-1/2" CW, 4" VENT, AND 4" ST PIPING. CONNECT TO EXISTING WITHIN THIS AREA. strang-inc.com 1750 RAND ROAD • RAPID CITY SD, 57702 PHONE: (605) 348-7455 • FAX: (605) 348-9445 WWW.WESTPLAINSENGINEERING.COM CITY, SD • SIOUX FALLS, SD • CASPER, WY • CEDAR RAPIDS, IA • BISMAF CO-OP PROJECT NO: 1936 PRELIMINARY NOT FOR CONSTRUCTION ISSUE: Issue Date Project Status **REVISION SCHEDULE:** REV. # REV. DSC. REV. DATE PROJECT: SDSMT DEVEREAUX LIBRARY PHASE 1 SOUTH DAKOTA SCHOOL OF MINES AND TECHNOLOGY RAPID CITY, SOUTH DAKOTA SHEET TITLE: FIRST FLOOR PIPING PLAN

EXISTING PIPING.

UNISTRUT, ETC.

FERROUS PIPING AS SPECIFIED.

M2-1

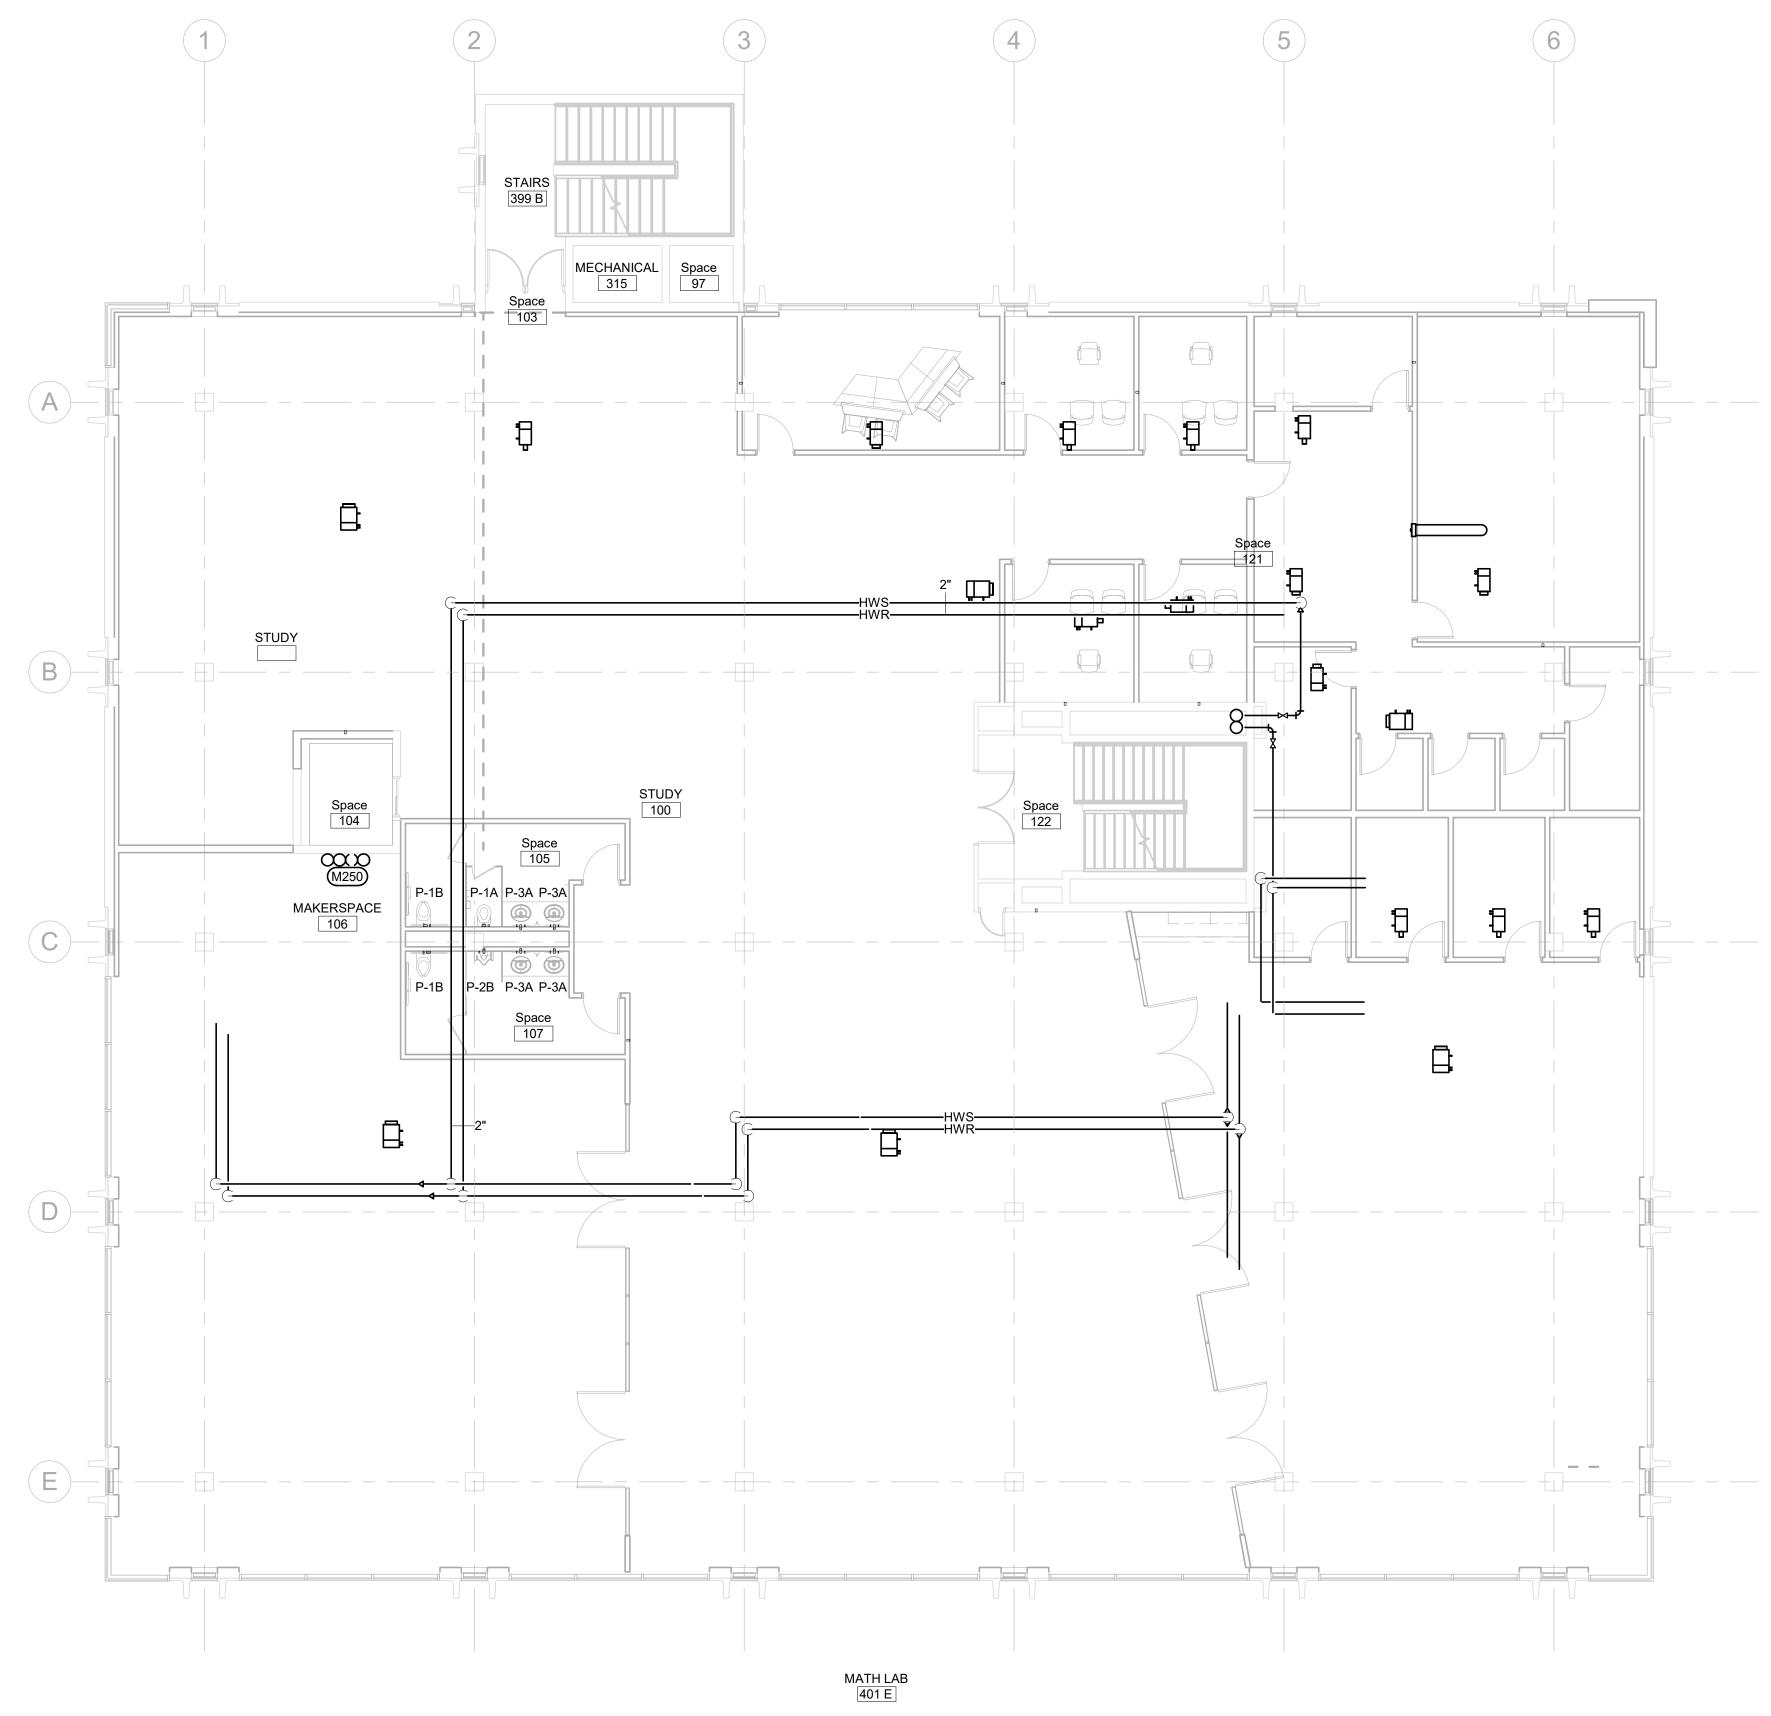





GENERAL MECHANICAL NOTES

A CONTRACTOR TO CONFIRM SIZE AND LOCATION OF EXISTING PIPING.

- B WORK ON THIS PROJECT WILL BE PHASED. THE MECHANICAL CONTRACTOR WILL BE RESPONSIBLE FOR ENSURING THAT AREAS OUTSIDE THE CURRENT PHASE OF WORK CONTINUE TO BE SERVED BY HEATING, COOLING, DOMESTIC WATER, SANITARY, ETC. SO AS NOT TO INTERRUPT OWNER WORK FLOW. ALL OUTAGES OF DOMESTIC WATER SHALL BE COORDINATED IN ADVANCE WITH OWNER AND WILL BE REQUIRED TO OCCUR DURING TIMES OF LOW USE. THIS WILL REQUIRE THE CONTRACTOR TO WORK OTHER THAN NORMAL WORK HOURS AT NO ADDITIONAL COST TO THE OWNER.
- C THE MECHANICAL CONTRACTOR IS TO EXTEND, MODIFY AND/OR RELOCATE ANY PIPING, THAT CONTINUES TO SERVE THE SPACE, AS NEEDED SO THAT ALL NEW ARCHITECTURAL, MECHANICAL AND ELECTRICAL WORK
- SHOWN IN THE REMODEL PLANS CAN BE INSTALLED.
  D ALL PIPING INSULATION SERVING SERVING DOMESTIC COLD WATER PIPING AND CHILLED WATER PIPING SHALL BE INSTALLED WITH UNBROKEN VAPOR BARRIERS AS PER SPECIFICATIONS. CONTRACTOR TO USE METAL SADDLES AND STRAPS ON EXTERIOR OF INSULATION FOR SUPPORT OF PIPING AT HANGERS,
- UNISTRUT, ETC. E ISOLATE ALL COPPER PIPES FROM BEARING ON FERROUS HANGERS, ETC. WITH ELECTRICALLY INSULATING MATERIALS AS SPECIFIED. USE DIELECTRIC UNIONS IN CONNECTION OF ALL COPPER PIPING TO FERROUS PIPING AS SPECIFIED.
- #MECHANICAL SPECIFIC NOTESM250INSTALL NEW 4" SAN, 1-1/2" CW, 4" VENT, AND 4" ST<br/>PIPING. CONNECT TO EXISTING WITHIN THIS AREA.

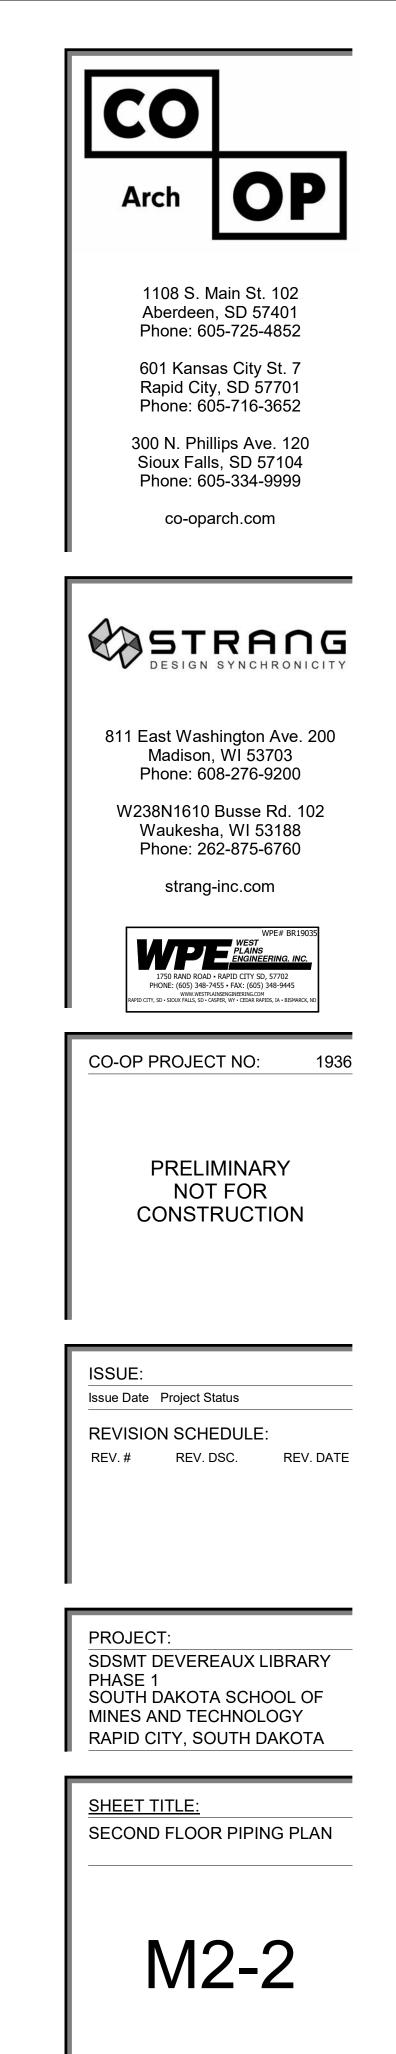


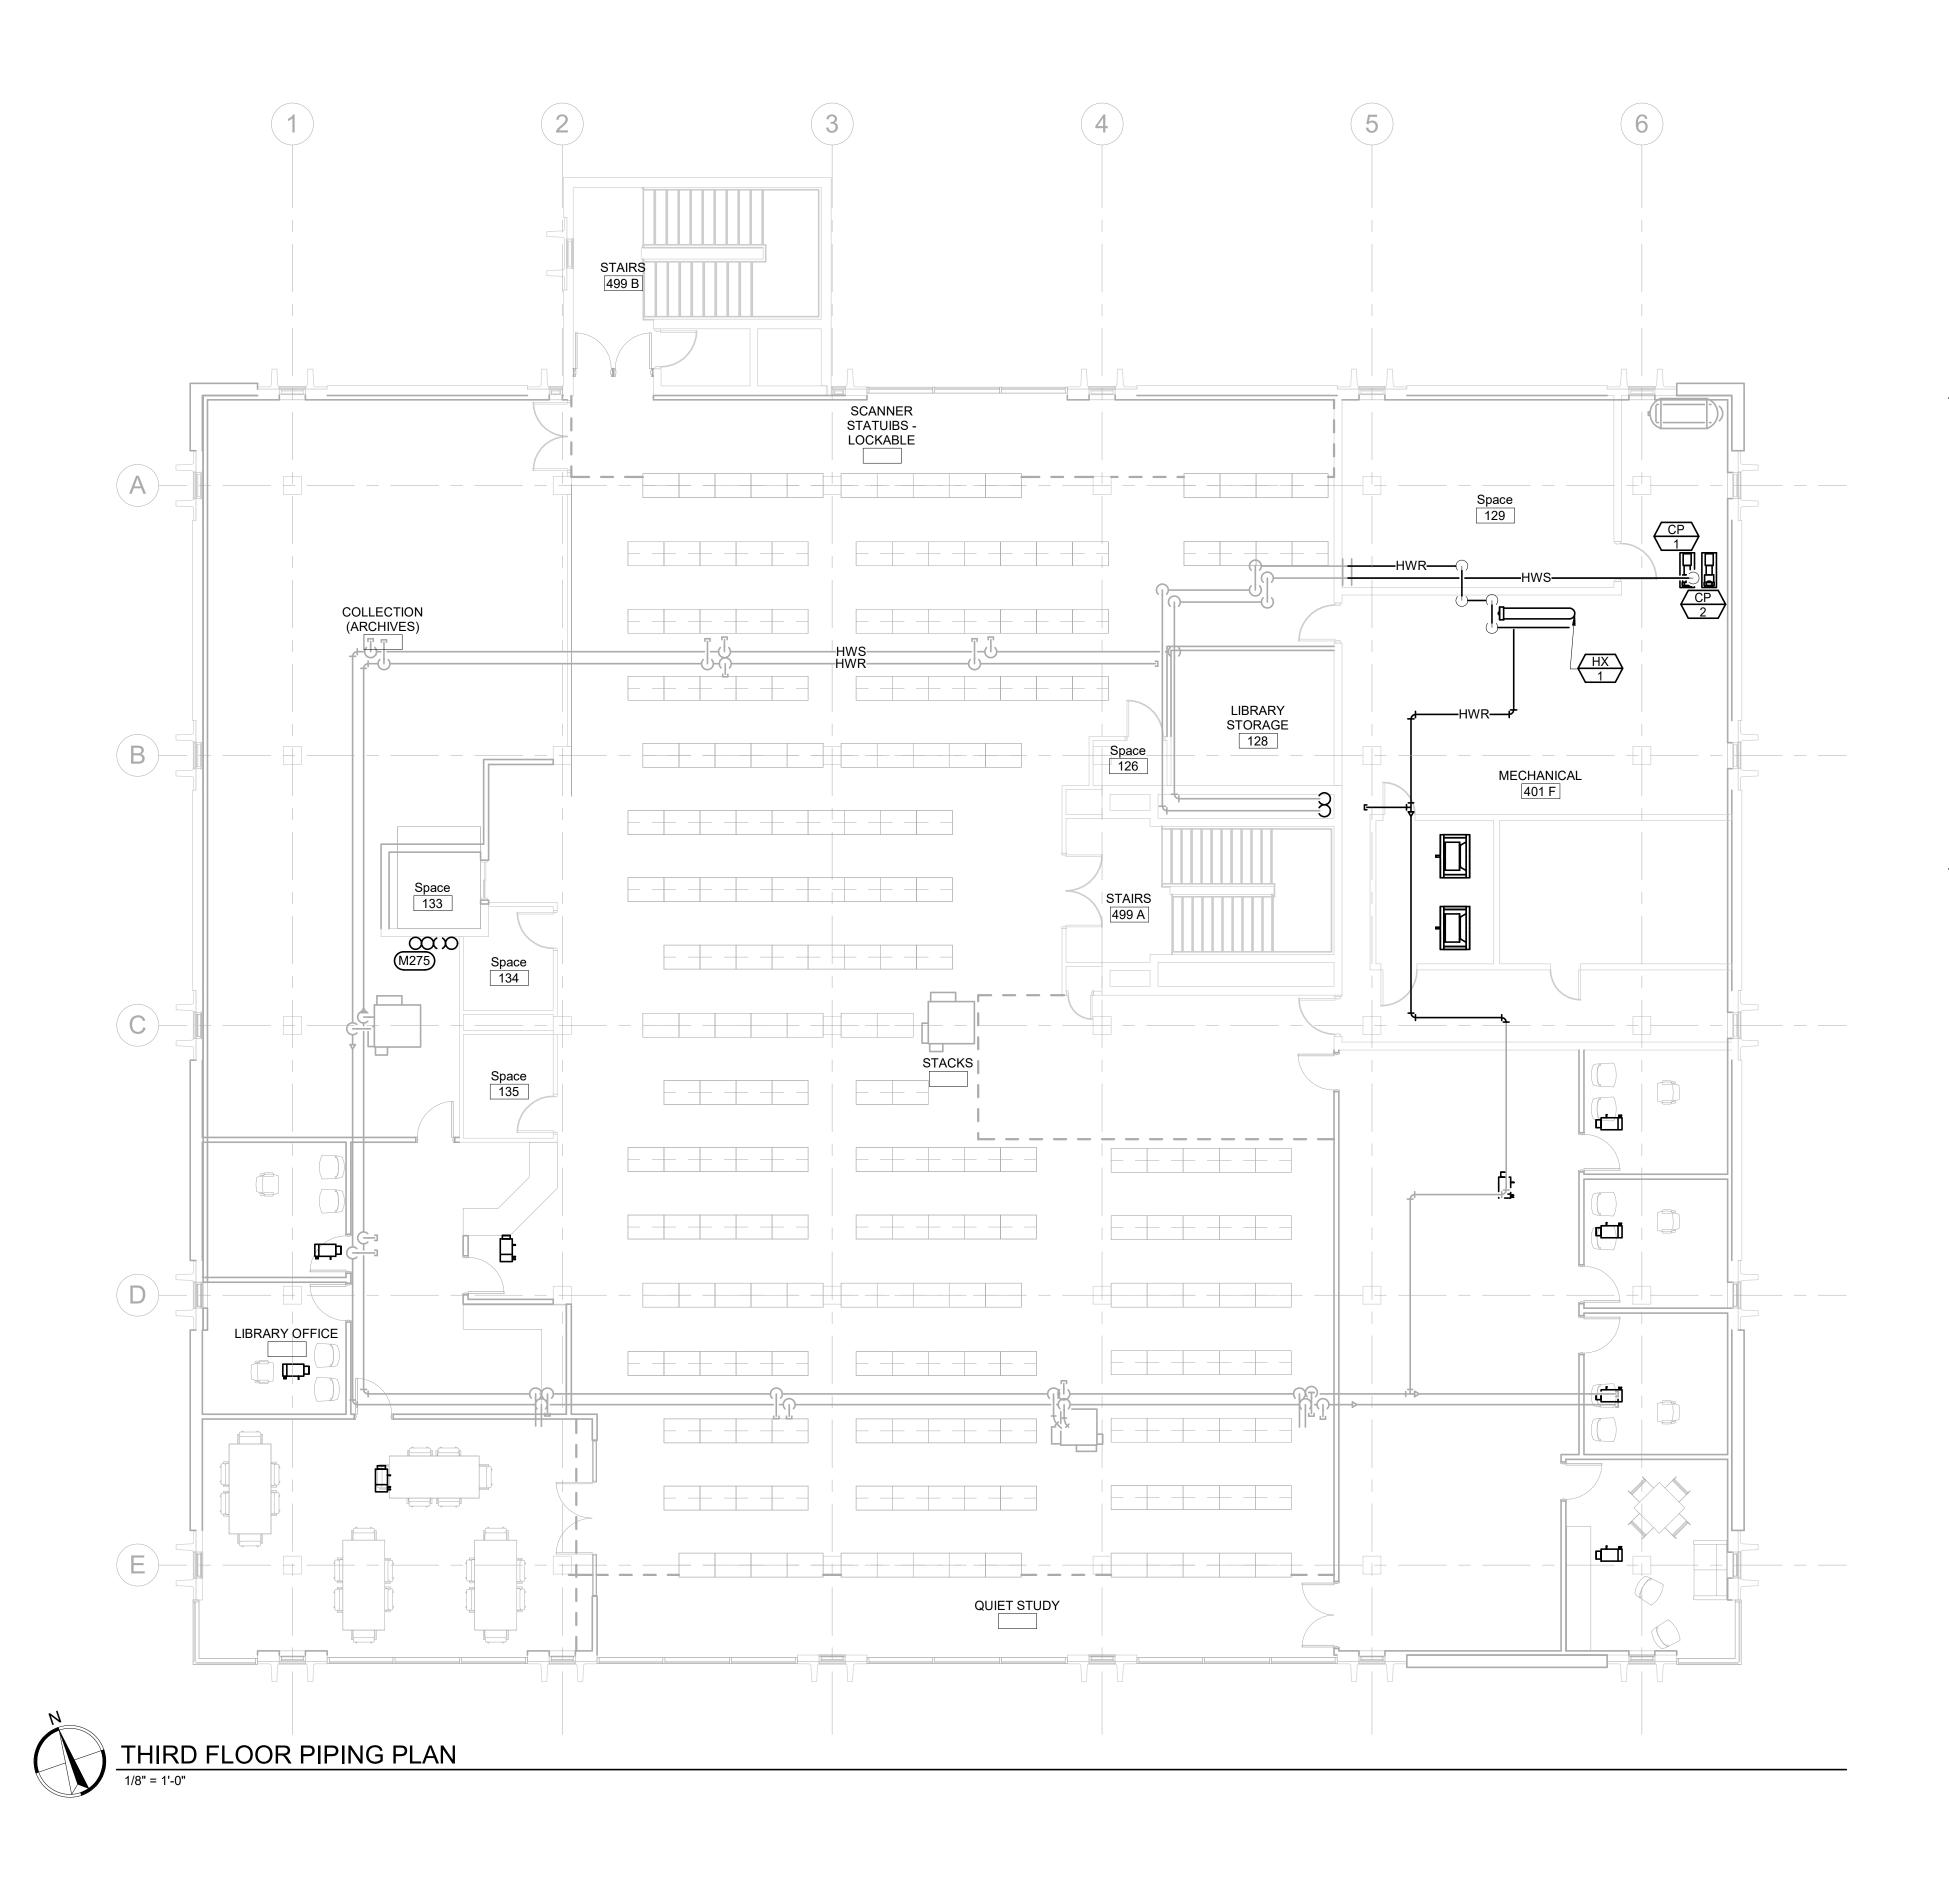

	CO Arch OP
	1108 S. Main St. 102 Aberdeen, SD 57401 Phone: 605-725-4852 601 Kansas City St. 7 Rapid City, SD 57701 Phone: 605-716-3652 300 N. Phillips Ave. 120
CHANICAL NOTES RM SIZE AND LOCATION OF	Sioux Falls, SD 57104 Phone: 605-334-9999 co-oparch.com
WILL BE PHASED. THE OR WILL BE RESPONSIBLE FOR DUTSIDE THE CURRENT PHASE BE SERVED BY HEATING, TER, SANITARY, ETC. SO AS IER WORK FLOW. ALL OUTAGES IALL BE COORDINATED IN AND WILL BE REQUIRED TO F LOW USE. THIS WILL REQUIRE ORK OTHER THAN NORMAL DITIONAL COST TO THE OWNER. RACTOR IS TO EXTEND, MODIFY PIPING, THAT CONTINUES TO EEDED SO THAT ALL NEW INICAL AND ELECTRICAL WORK	811 East Washington Ave. 200 Madison, WI 53703 Phone: 608-276-9200
L PLANS CAN BE INSTALLED. SERVING SERVING DOMESTIC D CHILLED WATER PIPING ITH UNBROKEN VAPOR FICATIONS. CONTRACTOR TO D STRAPS ON EXTERIOR OF RT OF PIPING AT HANGERS,	W238N1610 Busse Rd. 102 Waukesha, WI 53188 Phone: 262-875-6760 strang-inc.com
PES FROM BEARING ON C. WITH ELECTRICALLY AS SPECIFIED. USE DIELECTRIC OF ALL COPPER PIPING TO CIFIED. CAL SPECIFIC NOTES 1-1/2" CW, 4" VENT, AND 4" ST D EXISTING WITHIN THIS AREA.	WPE# BR19035 WEST PLAINS ENGINEERING. INC. 1750 RAND ROAD • RAPID CITY SD, 57702 PHONE: 005) 348-7455 • FAX: (605) 348-9445 WWW.WESTDAINSENGEREING.COM RAPID CITY, SD • SIOUX FALLS, SD • CASPER, WY • CEDAR RAPIDS, IA • BISMARCK, ND
	CO-OP PROJECT NO: 1936 PRELIMINARY NOT FOR CONSTRUCTION
	ISSUE: Issue Date Project Status REVISION SCHEDULE: REV. # REV. DSC. REV. DATE
	PROJECT: SDSMT DEVEREAUX LIBRARY PHASE 1 SOUTH DAKOTA SCHOOL OF MINES AND TECHNOLOGY RAPID CITY, SOUTH DAKOTA
	<u>SHEET TITLE:</u> THIRD FLOOR PIPING PLAN
	M2-3

GENERAL MEC A CONTRACTOR TO CONFIR EXISTING PIPING.


- B WORK ON THIS PROJECT V MECHANICAL CONTRACTO ENSURING THAT AREAS OL OF WORK CONTINUE TO BE COOLING, DOMESTIC WATE NOT TO INTERRUPT OWNE OF DOMESTIC WATER SHA ADVANCE WITH OWNER AN OCCUR DURING TIMES OF THE CONTRACTOR TO WOI WORK HOURS AT NO ADDI
- C THE MECHANICAL CONTRA AND/OR RELOCATE ANY PI SERVE THE SPACE, AS NEE ARCHITECTURAL, MECHAN SHOWN IN THE REMODEL F
- D ALL PIPING INSULATION SE COLD WATER PIPING AND SHALL BE INSTALLED WIT BARRIERS AS PER SPECIF USE METAL SADDLES AND INSULATION FOR SUPPOR UNISTRUT, ETC.
- E ISOLATE ALL COPPER PIPE FERROUS HANGERS, ETC. INSULATING MATERIALS AS UNIONS IN CONNECTION O FERROUS PIPING AS SPEC
- (#) MECHANIC M275 INSTALL NEW 4" SAN, 7 PIPING. CONNECT TO

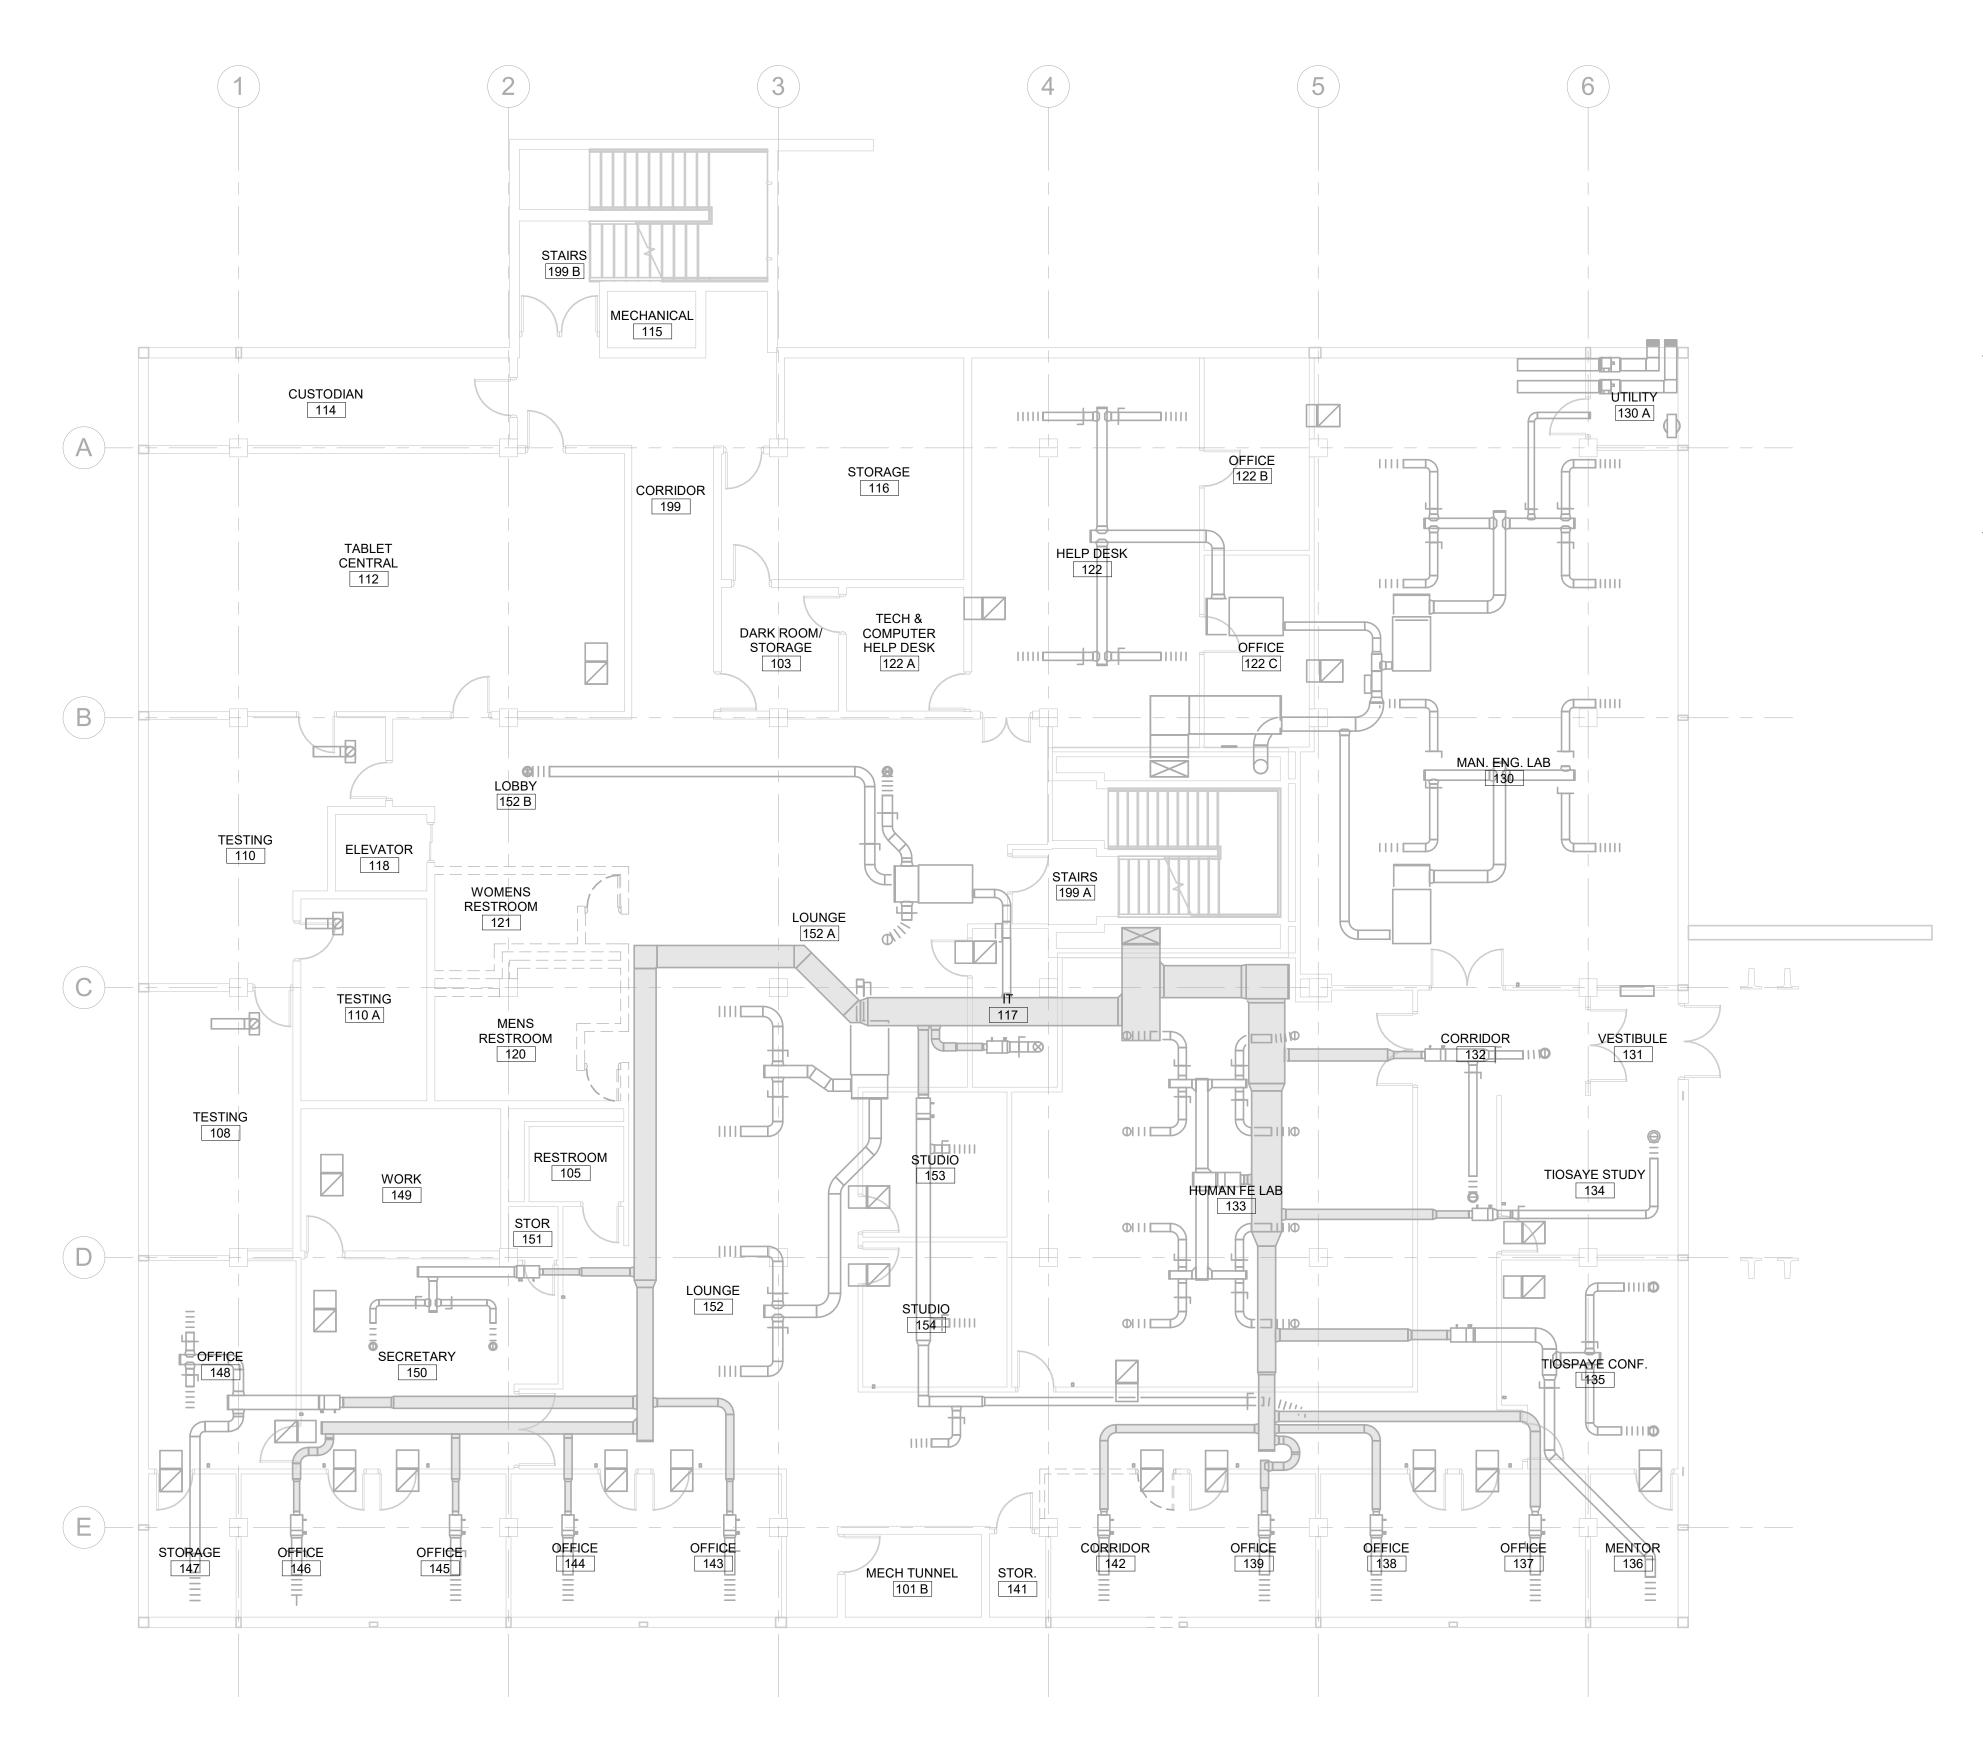




\_\_\_\_] Γ\_\_\_\_

	CO	
	Arch	OP
	Aberdeen Phone: 60 601 Kansa Rapid City	Main St. 102 , SD 57401 95-725-4852 as City St. 7 7, SD 57701 95-716-3652
GENERAL MECHANICAL NOTES A COORDINATE PHASING AND REMOVAL OF EXISTING DUCTWORK AND EQUIPMENT WITH OWNER. B REMOVE EXISTING GRILLES, REGISTERS, DUCTWORK,	Sioux Falls Phone: 60	lips Ave. 120 s, SD 57104 95-334-9999 urch.com
<ul> <li>B REMOVE EXISTING GRILLES, REGISTERS, DUCTWORK, ETC. WHERE INDICATED DASHED. CAP DUCTWORK DURING CONSTRUCTION. THIS CONTRACTOR TO ASSIST IN REMOVAL AND REINSTALLATION OF DUCTWORK THAT RESTRICTS THE WORK OF OTHER TRADES.</li> <li>C CONTRACTOR TO CONFIRM LOCATIONS OF EXISTING DUCTWORK.</li> </ul>	C0-0p2	
MECHANICAL SPECIFIC NOTES		SYNCHRONICITY
	Madison	nington Ave. 200 WI 53703 8-276-9200
	Waukesha Phone: 26	Busse Rd. 102 a, WI 53188 52-875-6760
	1750 RAND ROAD PHONE: (605) 348-7 www.westpu	WPE# BR19035 WEST PLAINS ENGINEERING. INC. • RAPID CITY SD, 57702 455 - FAX: (605) 348-9445 INSEKGINEERING.COM SPER, WY - CEDAR RAPIDS, IA + BISMARCK, ND
	CO-OP PROJEC	ST NO: 1936
	NOT	MINARY FOR RUCTION
	ISSUE: Issue Date Project St	tatus
	REVISION SCHE REV. # REV. E	
	PROJECT: SDSMT DEVER PHASE 1 SOUTH DAKOTA MINES AND TEC RAPID CITY, SC	A SCHOOL OF CHNOLOGY
	<u>SHEET TITLE:</u> LOWER LEVEL DEMOLITION PL	
	M	3-0

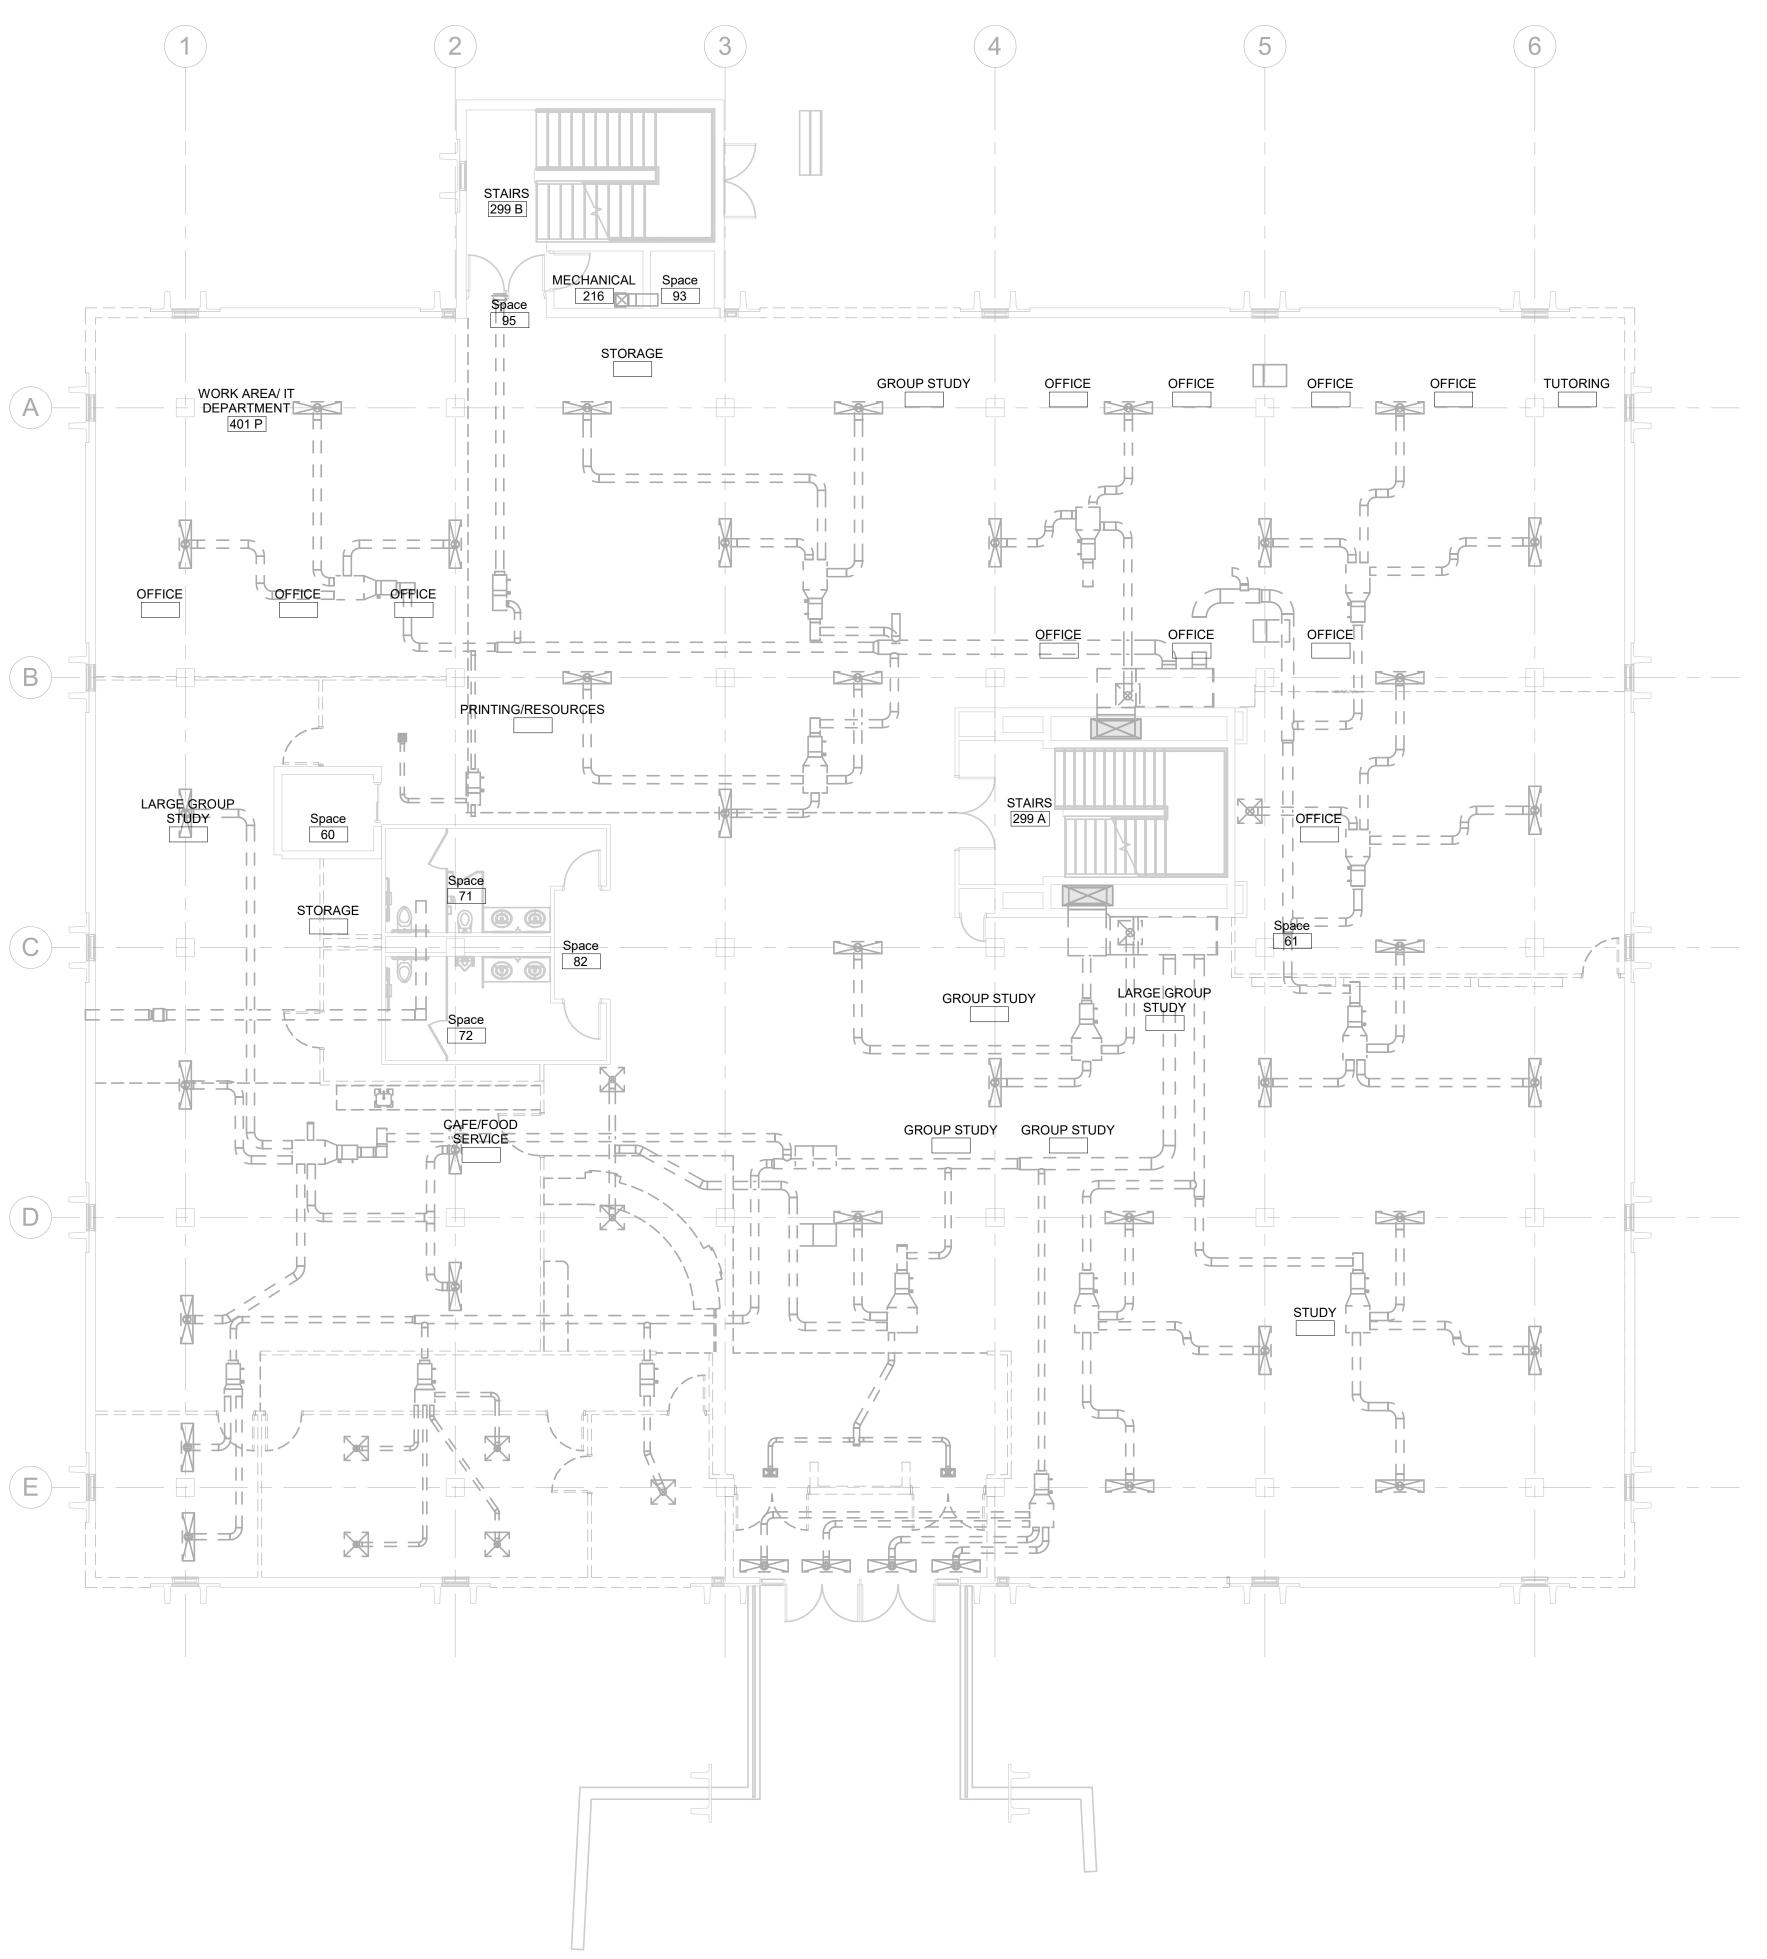




	CO	
	Arch	OP
	Aberdeen	1ain St. 102 , SD 57401 95-725-4852
GENERAL MECHANICAL NOTES  A COORDINATE PHASING AND REMOVAL OF EXISTING DUCTWORK AND EQUIPMENT WITH OWNER.  D DEMOVE EXISTING OPHILES DECOVERED DUCTWORK	Rapid City	as City St. 7 ⁄, SD 57701 /5-716-3652
B REMOVE EXISTING GRILLES, REGISTERS, DUCTWORK, ETC. WHERE INDICATED DASHED. CAP DUCTWORK DURING CONSTRUCTION. THIS CONTRACTOR TO ASSIST IN REMOVAL AND REINSTALLATION OF DUCTWORK THAT RESTRICTS THE WORK OF OTHER TRADES.	Sioux Falls	lips Ave. 120 s, SD 57104 )5-334-9999
C CONTRACTOR TO CONFIRM LOCATIONS OF EXISTING DUCTWORK.		irch.com
	DESIGN	RANG
	Madison Phone: 60 W238N1610 Waukesha	nington Ave. 200 WI 53703 8-276-9200 Busse Rd. 102 a, WI 53188
		2-875-6760 -inc.com
	PHONE: (605) 348-7	WPE# BR19035 WEST PLAINS ENGINEERING. INC. • RAPID CITY SD, 57702 455 - FAX: (605) 348-9445 INSERGIMERING.COM SPER, WY - CEDAR RAPIDS, IA - BISMARCK, ND
	CO-OP PROJEC	ST NO: 1936
	NOT	MINARY FOR RUCTION
	ISSUE:	
	Issue Date Project S REVISION SCHE REV. # REV. E	EDULE:
	PROJECT: SDSMT DEVER PHASE 1 SOUTH DAKOTA MINES AND TEC RAPID CITY, SC	A SCHOOL OF CHNOLOGY
	<u>SHEET TITLE:</u> FIRST FLOOR H DEMOLITION PL	
	M	3-1

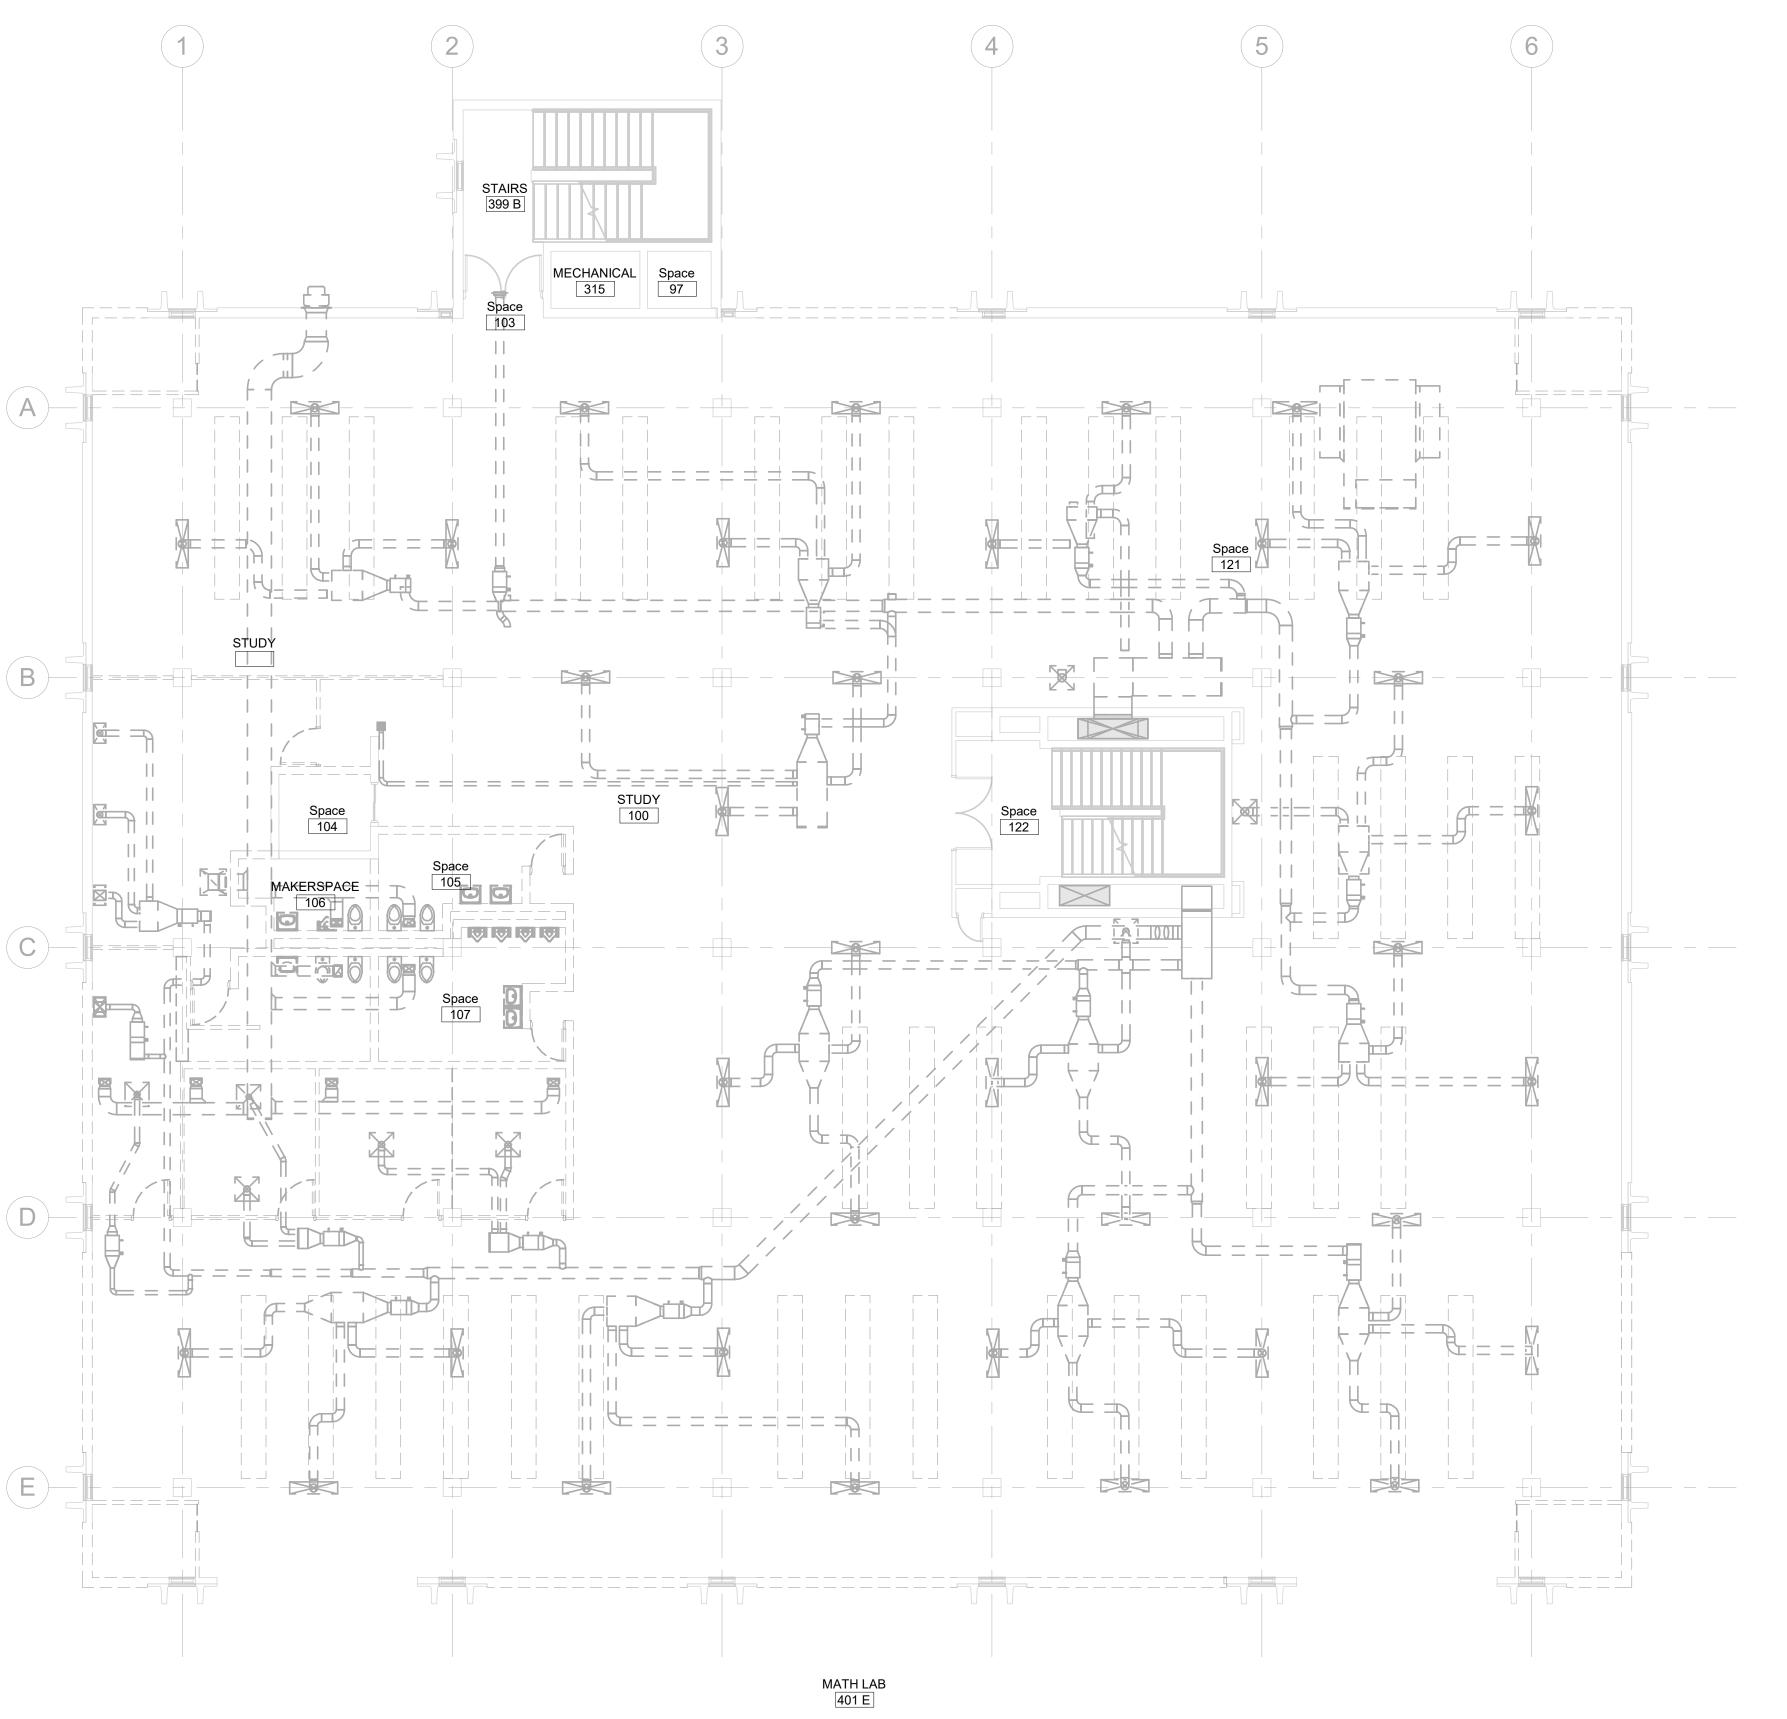




		:0
		Arch <b>OP</b>
GENERAL MECHANICAL NOTES		1108 S. Main St. 102 Aberdeen, SD 57401 Phone: 605-725-4852 601 Kansas City St. 7 Rapid City, SD 57701 Phone: 605-716-3652 300 N. Phillips Ave. 120 Sioux Falls, SD 57104 Phone: 605-334-9999
<ul><li>A COORDINATE PHASING AND REMOVAL OF EXISTING DUCTWORK AND EQUIPMENT WITH OWNER.</li><li>B REMOVE EXISTING GRILLES, REGISTERS, DUCTWORK,</li></ul>		co-oparch.com
ETC. WHERE INDICATED DASHED. CAP DUCTWORK DURING CONSTRUCTION. THIS CONTRACTOR TO ASSIST IN REMOVAL AND REINSTALLATION OF DUCTWORK THAT RESTRICTS THE WORK OF OTHER TRADES. C CONTRACTOR TO CONFIRM LOCATIONS OF EXISTING DUCTWORK.		STRANG
(#)         MECHANICAL SPECIFIC NOTES		DESIGN SYNCHRONICITY
	811	East Washington Ave. 200 Madison, WI 53703 Phone: 608-276-9200
	W	238N1610 Busse Rd. 102 Waukesha, WI 53188 Phone: 262-875-6760
		strang-inc.com
		WPE# BR19035 WEST PLAINS ENGINEERING. INC. 1750 RAND ROAD • RAPID CITY SD, 57702 PHONE: (605) 348-7455 • FAX: (605) 348-9445 WWW WETPLINESKURTERING COM APID CITY, SD • SIOUX FALLS, SD • CASPER, WY • CEDAR RAPIDS, IA • BISMARCK, ND
	<u>CO-O</u>	P PROJECT NO: 1936
		PRELIMINARY NOT FOR CONSTRUCTION
	ISSU Issue D	E: ate Project Status
	REVI REV. #	SION SCHEDULE: REV. DSC. REV. DATE
	PHAS SOUT MINE	IT DEVEREAUX LIBRARY
	SECO	<u>ET TITLE:</u> OND FLOOR HVAC DLITION PLAN
		M3-2
	I	

A

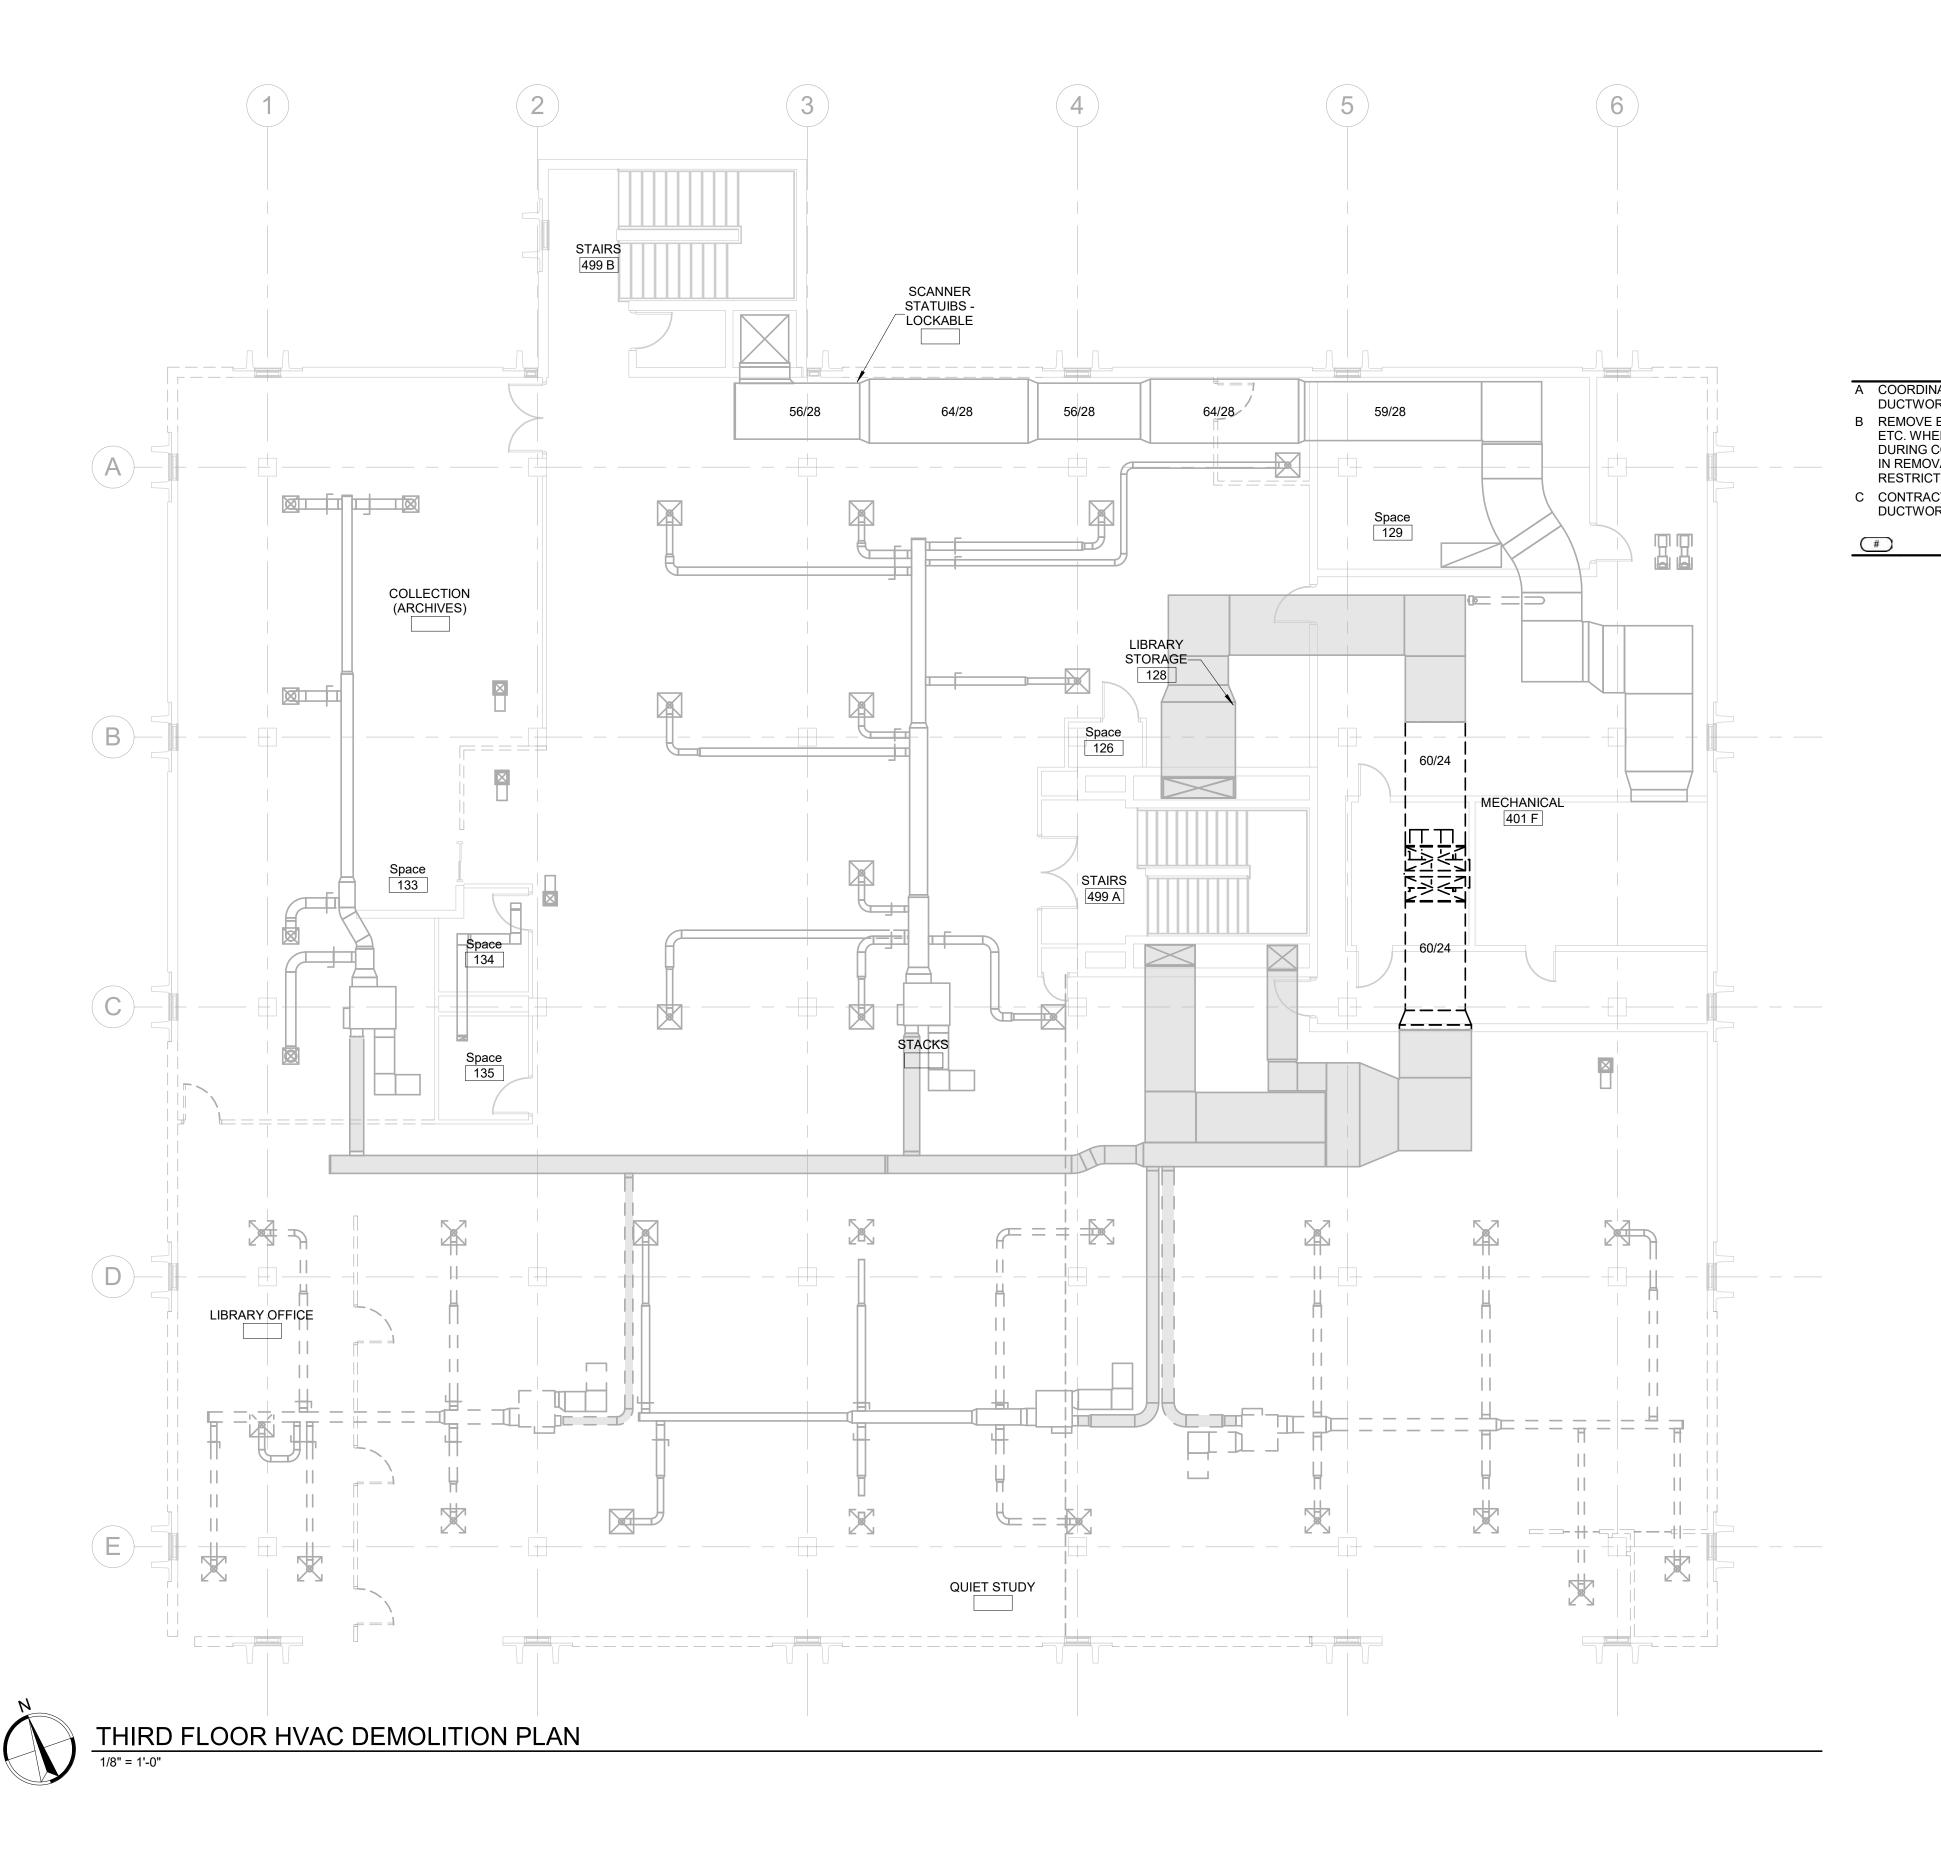

	CO Arch OP
	1108 S. Main St. 102 Aberdeen, SD 57401 Phone: 605-725-4852 601 Kansas City St. 7 Rapid City, SD 57701 Phone: 605-716-3652
GENERAL MECHANICAL NOTES NATE PHASING AND REMOVAL OF EXISTING ORK AND EQUIPMENT WITH OWNER. EXISTING GRILLES, REGISTERS, DUCTWORK, IERE INDICATED DASHED. CAP DUCTWORK CONSTRUCTION. THIS CONTRACTOR TO ASSIST	300 N. Phillips Ave. 120 Sioux Falls, SD 57104 Phone: 605-334-9999 co-oparch.com
IVAL AND REINSTALLATION OF DUCTWORK THAT CTS THE WORK OF OTHER TRADES. ICTOR TO CONFIRM LOCATIONS OF EXISTING DRK. MECHANICAL SPECIFIC NOTES	STRANG DESIGN SYNCHRONICITY
	811 East Washington Ave. 200 Madison, WI 53703 Phone: 608-276-9200 W238N1610 Busse Rd. 102 Waukesha, WI 53188 Phone: 262-875-6760 strang-inc.com
	WPE# BR19035 WEST PLAINS ENGINEERING. INC. 1750 RAND ROAD • RAPID CITY SD, 57702 PHONE: (605) 348-7455 FAX: (605) 348-9445 WWW.WESTPLAINGENGINEERING.COM RAPID CITY, SD • STOUX FALLS, SD • OSPFR, W1 • CEDAR RAPIDS, IA • BISMARCK, ND
	CO-OP PROJECT NO: 1936
	PRELIMINARY NOT FOR CONSTRUCTION
	ISSUE: Issue Date Project Status REVISION SCHEDULE: REV. # REV. DSC. REV. DATE
	PROJECT: SDSMT DEVEREAUX LIBRARY PHASE 1 SOUTH DAKOTA SCHOOL OF MINES AND TECHNOLOGY RAPID CITY, SOUTH DAKOTA
	<u>SHEET TITLE:</u> THIRD FLOOR HVAC DEMOLITION PLAN
	M3-3

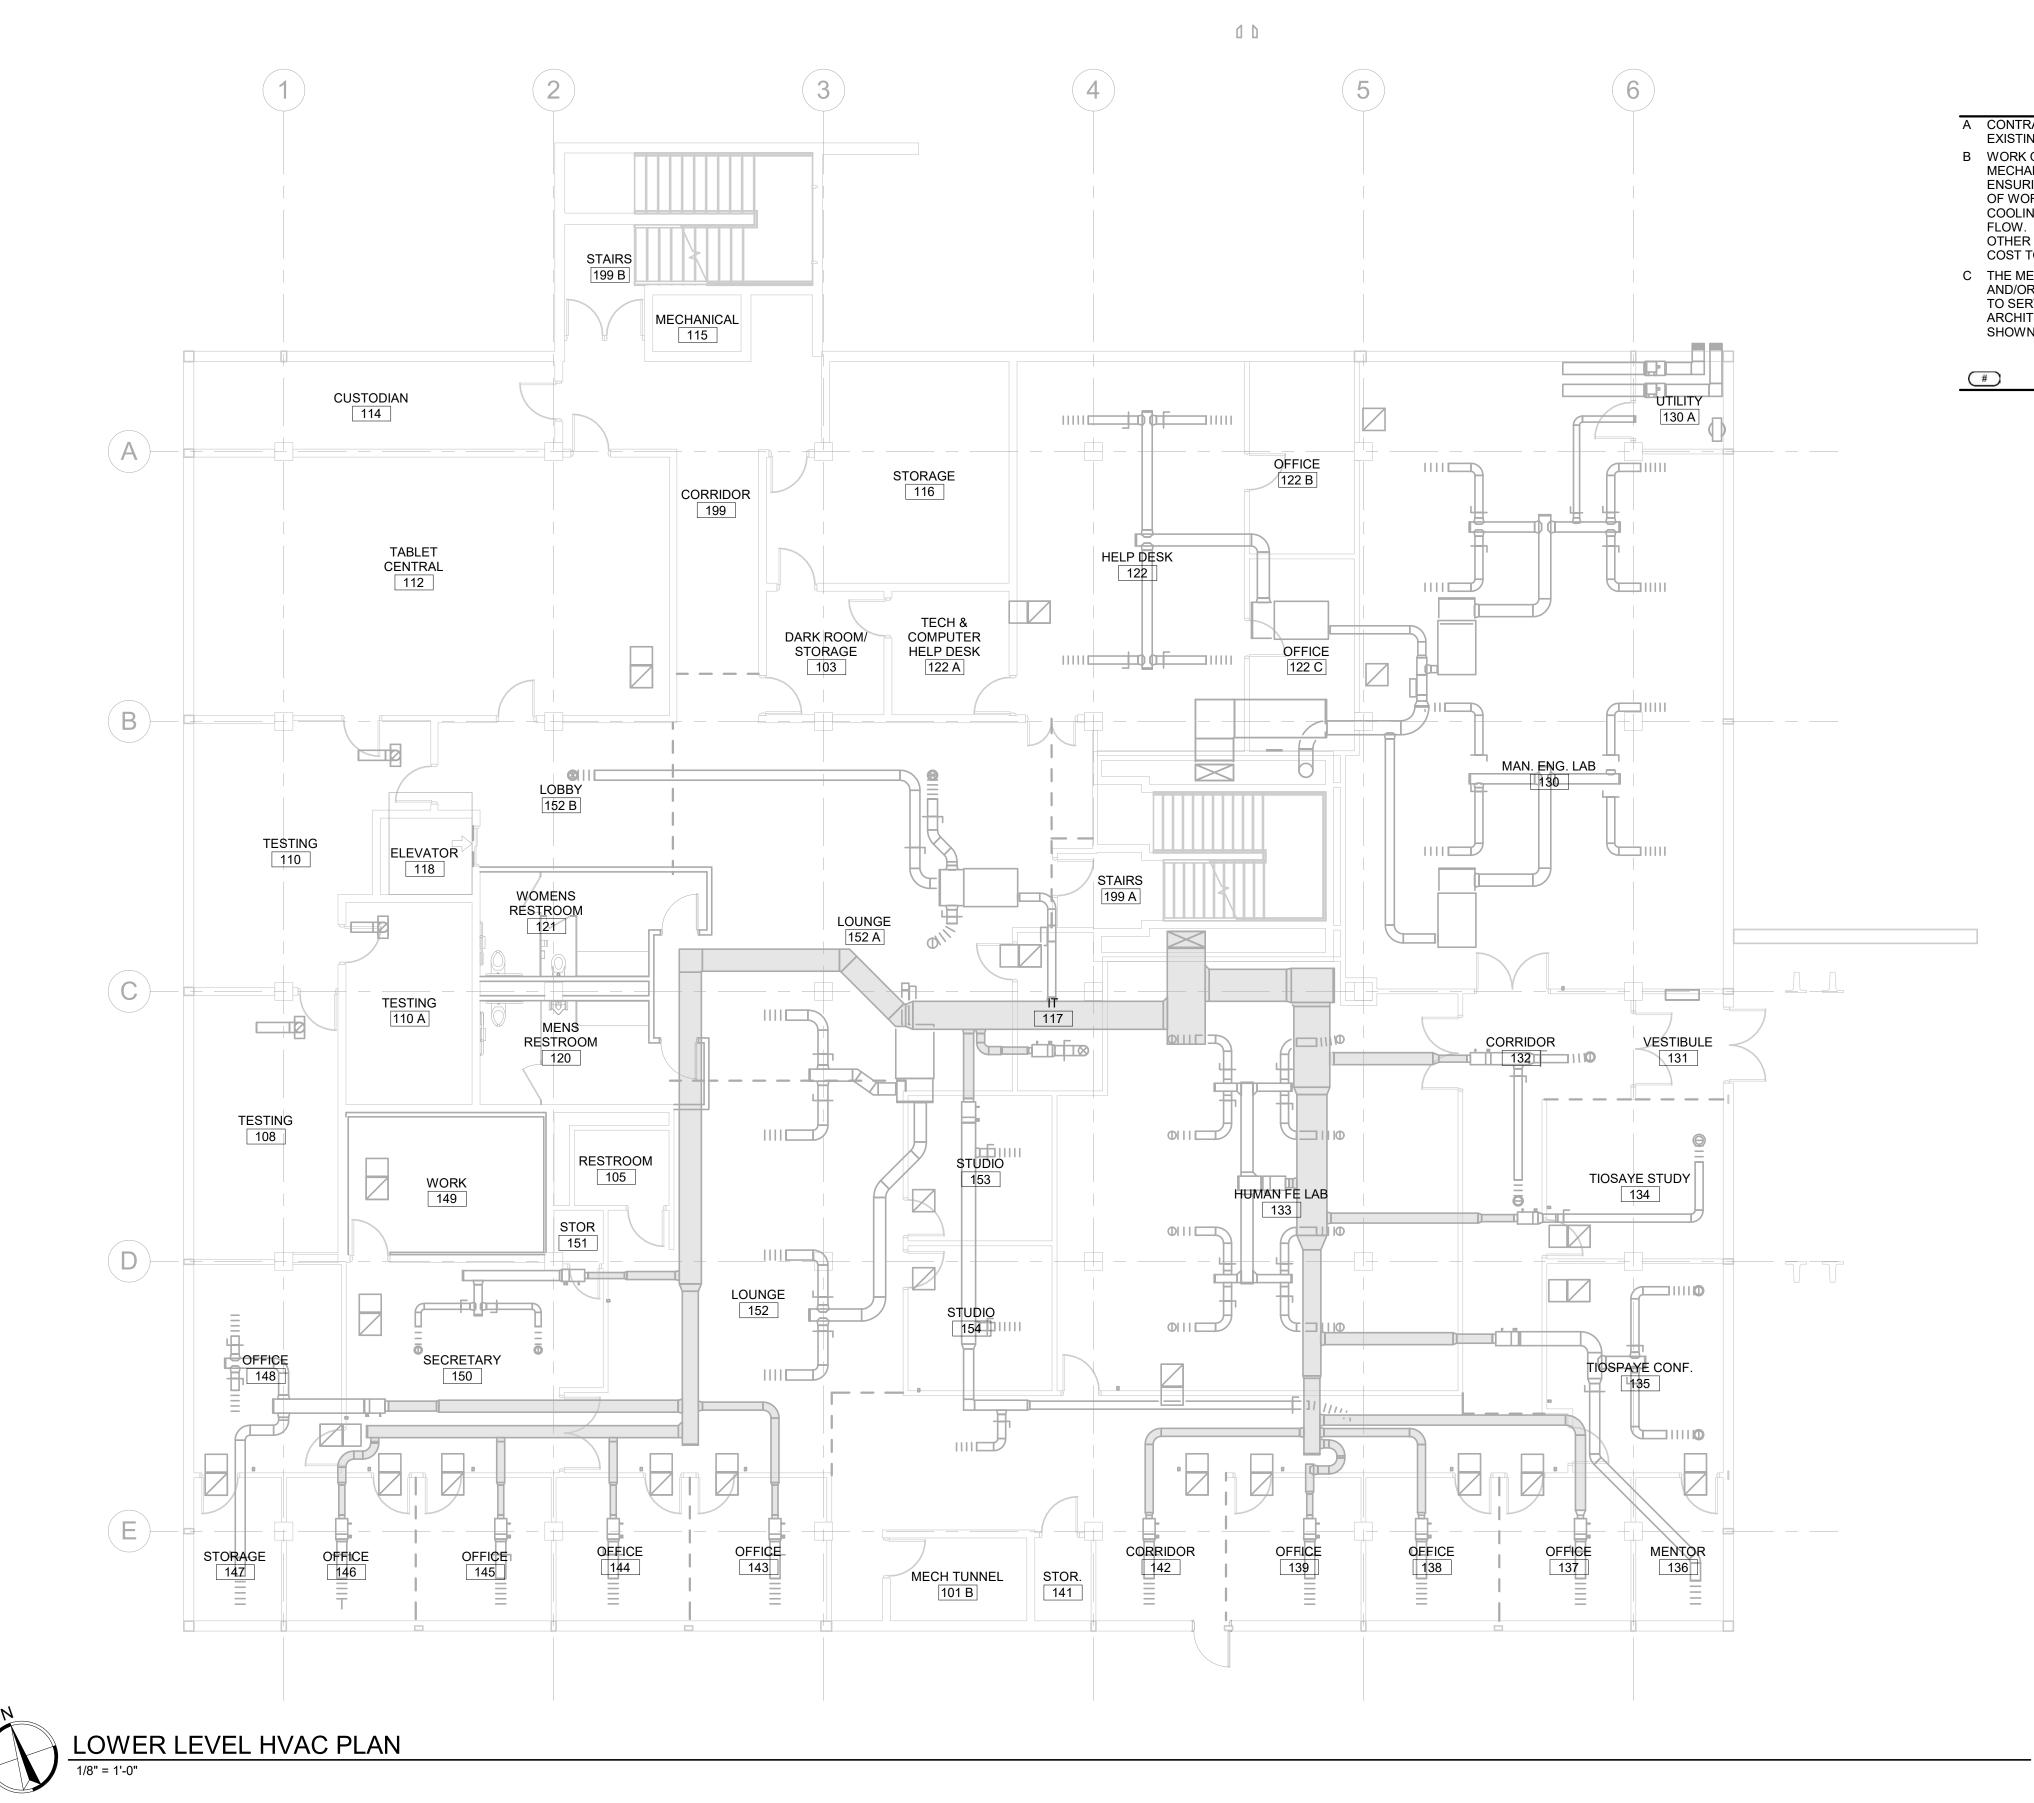

GENERAL MECHANICAL NOTES


A CONTRACTOR TO CONFIRM SIZE AND LOCATION OF EXISTING DUCTWORK.


B WORK ON THIS PROJECT WILL BE PHASED. THE MECHANICAL CONTRACTOR WILL BE RESPONSIBLE FOR ENSURING THAT AREAS OUTSIDE THE CURRENT PHASE OF WORK CONTINUE TO BE SERVED BY HEATING, COOLING, ETC. SO AS NOT TO INTERRUPT OWNER WORK FLOW. THIS WILL REQUIRE THE CONTRACTOR TO WORK OTHER THAN NORMAL WORK HOURS AT NO ADDITIONAL COST TO THE OWNER.

C THE MECHANICAL CONTRACTOR IS TO EXTEND, MODIFY AND/OR RELOCATE ANY DUCTWORK, THAT CONTINUES TO SERVE THE SPACE, AS NEEDED SO THAT ALL NEW ARCHITECTURAL, MECHANICAL AND ELECTRICAL WORK SHOWN IN THE REMODEL PLANS CAN BE INSTALLED.

MECHANICAL SPECIFIC NOTES

CO	
Arch	OP
Aberdeen Phone: 60 601 Kansa Rapid City Phone: 60 300 N. Phil Sioux Falls Phone: 60	lain St. 102 , SD 57401 5-725-4852 as City St. 7 7, SD 57701 5-716-3652 lips Ave. 120 s, SD 57104 5-334-9999 rch.com
ST DESIGN	RANG
Madison, Phone: 60 W238N1610 Waukesha Phone: 26	hington Ave. 200 WI 53703 8-276-9200 Busse Rd. 102 a, WI 53188 2-875-6760 -inc.com
PHONE: (605) 348-74	RAPID CITY SD, 57702 155 - FAX: (605) 348-9445 INSENGINEERING.COM SPER. WI - CEDAR RAPIDS, IA - BISMARCK, ND TNO: 1936
NOT	MINARY FOR RUCTION
ISSUE: Issue Date Project St REVISION SCHE REV. # REV. D	EDULE:
PROJECT: SDSMT DEVERE PHASE 1 SOUTH DAKOTA MINES AND TEC RAPID CITY, SO	A SCHOOL OF CHNOLOGY
<u>SHEET TITLE:</u> LOWER LEVEL	HVAC PLAN
M∠	1-0

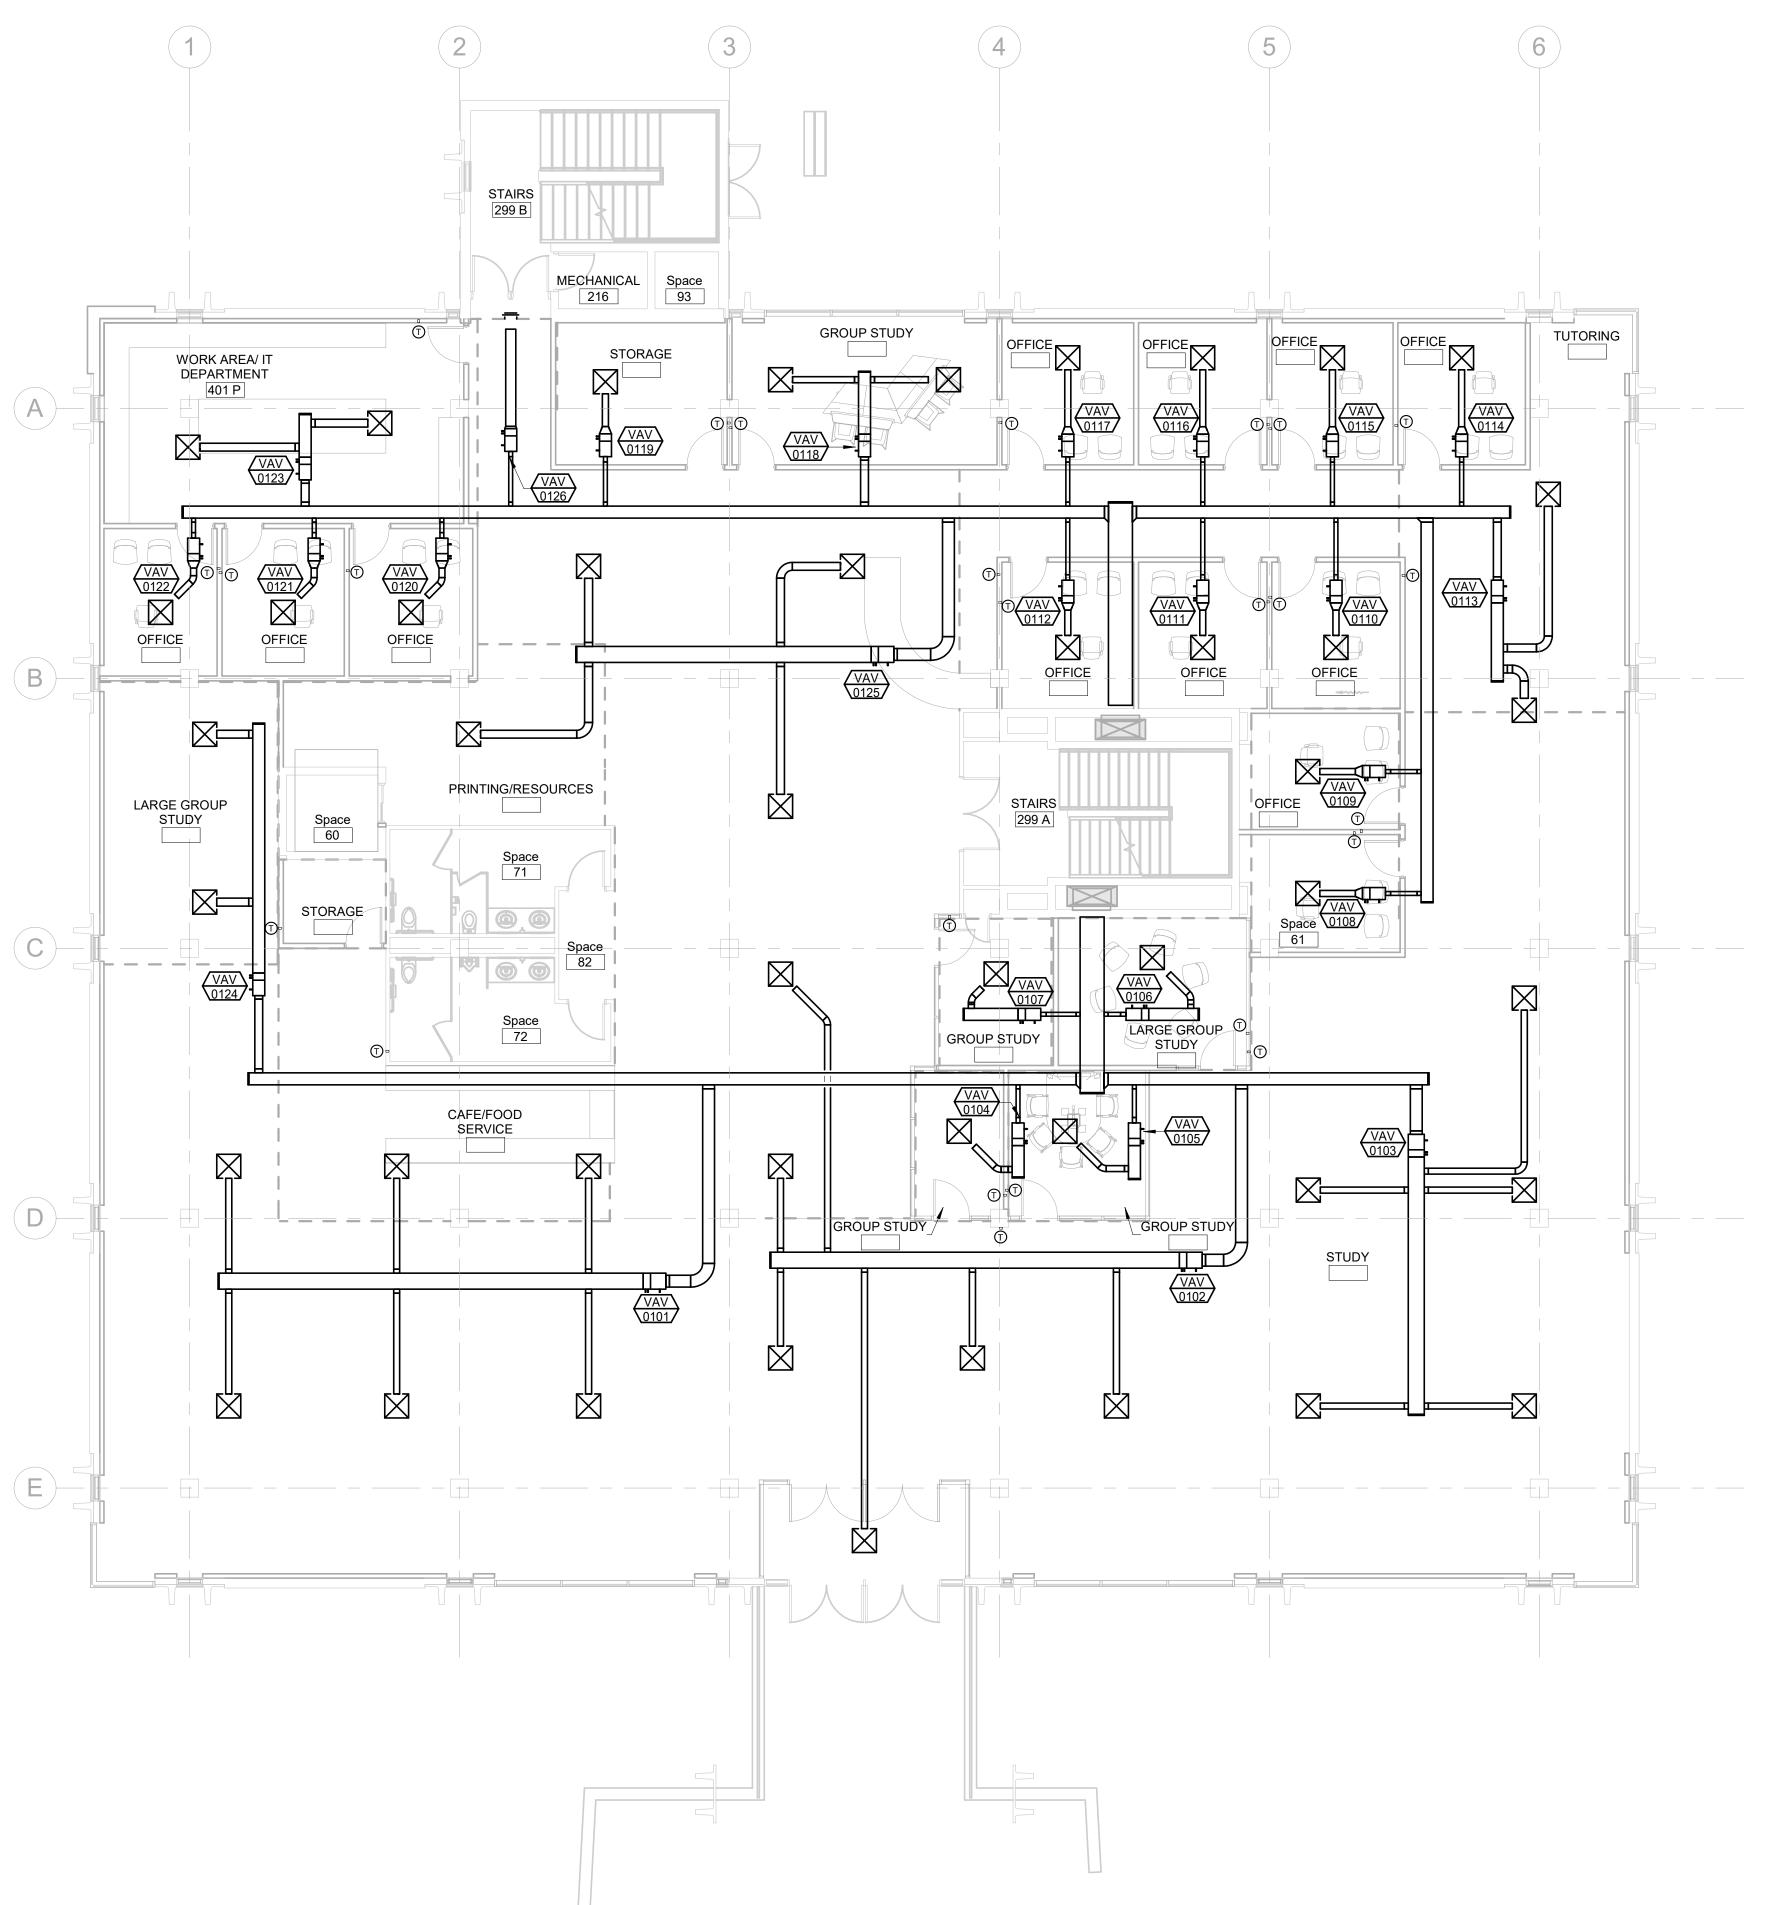

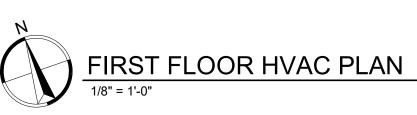


GENERAL MECHANICAL NOTES

- A CONTRACTOR TO CONFIRM SIZE AND LOCATION OF EXISTING DUCTWORK.
- B WORK ON THIS PROJECT WILL BE PHASED. THE MECHANICAL CONTRACTOR WILL BE RESPONSIBLE FOR ENSURING THAT AREAS OUTSIDE THE CURRENT PHASE OF WORK CONTINUE TO BE SERVED BY HEATING, COOLING, ETC. SO AS NOT TO INTERRUPT OWNER WORK FLOW. THIS WILL REQUIRE THE CONTRACTOR TO WORK OTHER THAN NORMAL WORK HOURS AT NO ADDITIONAL COST TO THE OWNER.
- C THE MECHANICAL CONTRACTOR IS TO EXTEND, MODIFY AND/OR RELOCATE ANY DUCTWORK, THAT CONTINUES TO SERVE THE SPACE, AS NEEDED SO THAT ALL NEW ARCHITECTURAL, MECHANICAL AND ELECTRICAL WORK SHOWN IN THE REMODEL PLANS CAN BE INSTALLED.


**MECHANICAL SPECIFIC NOTES** 

	CO		
	Arch	OP	
	1108 S. Main St. 102 Aberdeen, SD 57401 Phone: 605-725-4852 601 Kansas City St. 7		
	Rapid City, SD 57701 Phone: 605-716-3652 300 N. Phillips Ave. 120 Sioux Falls, SD 57104 Phone: 605-334-9999 co-oparch.com		
		RANG	
	Madison, Phone: 60 W238N1610 Waukesha	nington Ave. 200 WI 53703 8-276-9200 Busse Rd. 102 a, WI 53188 2-875-6760	
	strang- strang- 1750 RAND ROAD- PHONE: (605) 348-74 WWWSTA	WPE# BR19035 WEST PLAINS ENGINEERING. INC. RAPID CITY SD, 57702 ISS - FAX: (605) 348-9445 INSENCIMEERING.COM SPER. WY - CEDAR RAPIDS, IA - BISMARCK, ND	
[	CO-OP PROJEC	T NO: 1936	
	NOT	MINARY FOR RUCTION	
	ISSUE: Issue Date Project St REVISION SCHE REV. # REV. D		
	PROJECT: SDSMT DEVERE PHASE 1 SOUTH DAKOTA MINES AND TEC RAPID CITY, SO	A SCHOOL OF CHNOLOGY	
	<u>SHEET TITLE:</u> FIRST FLOOR H	VAC PLAN	
	M	1-1	

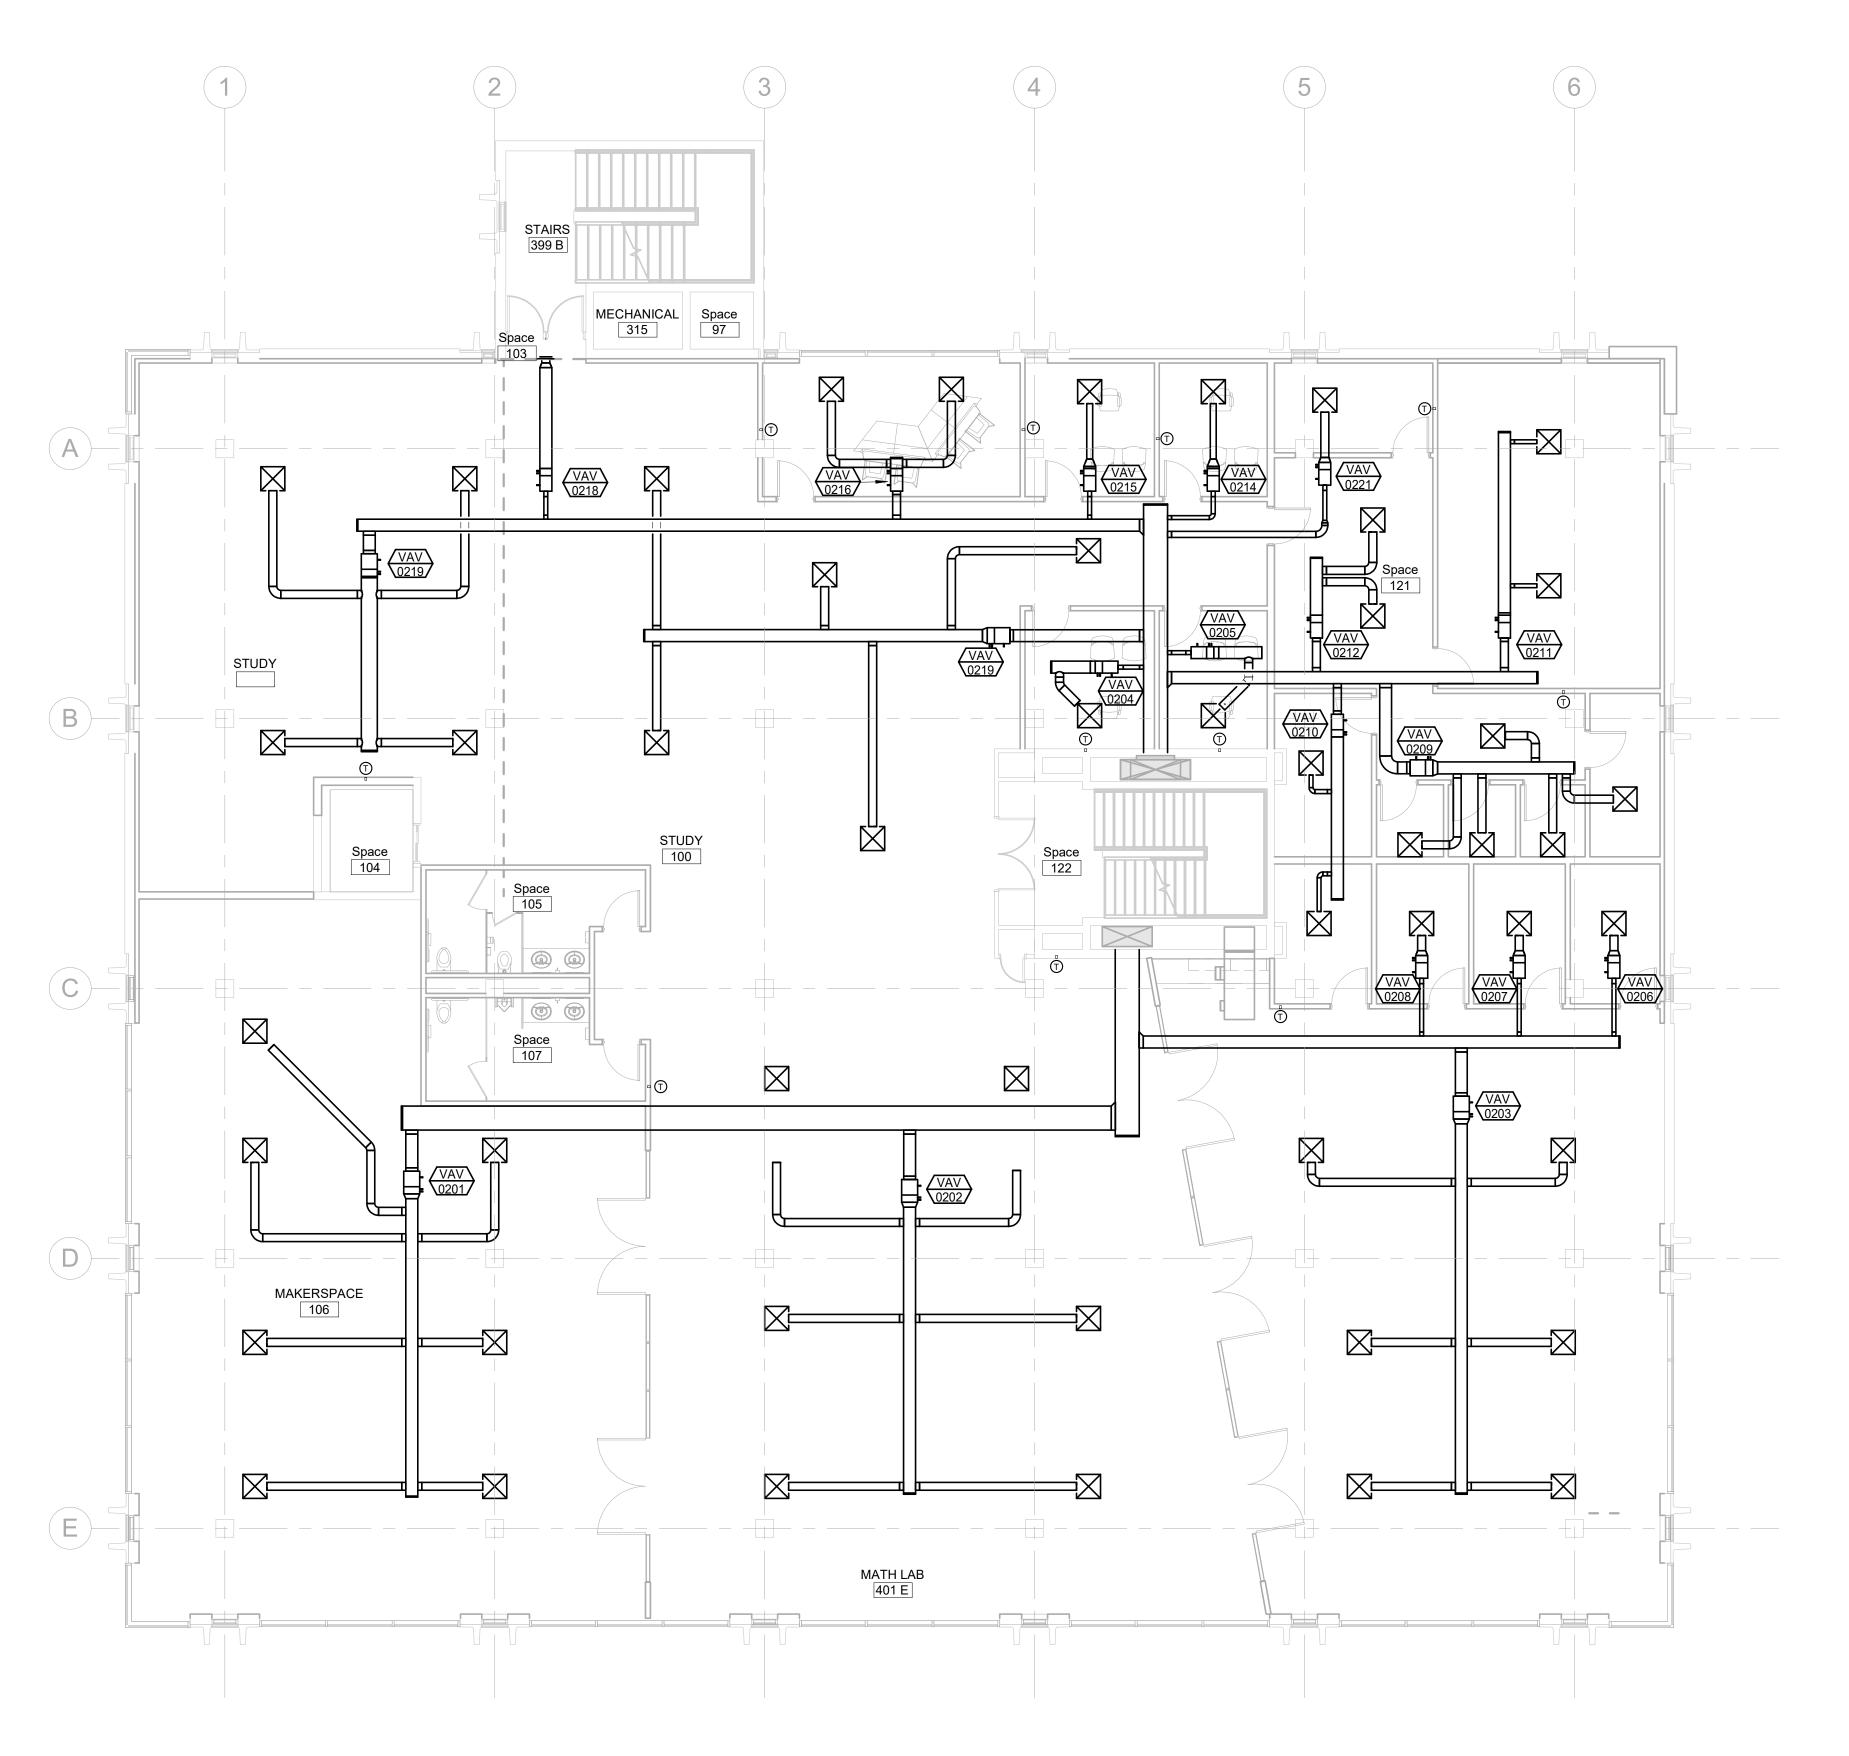



GENERAL MECHANICAL NOTES         A. CONTRACTOR TO CONFIRM SIZE AND LOCATION OF EXISTING DUCTWORK.         B. WORK ON THIS PROJECT WILL BE PHASED. THE MECHANICAL CONTRACTOR WILL BE RESPONSIBLE FOR ENSURING THAT AREAS OUTSIDE THE CURRENT PHASE OF WORK CONTINUE TO BE SERVED BY HEATING, COOLING, ETC. SO AS NOT TO INTERRUPT OWNER WORK FLOW. THIS WILL REQUIRE THE CONTRACTOR TO WORK OTHER THAN NORMAL WORK HOURS AT NO ADDITIONAL COST TO THE OWNER.         Contractor will be contractor to work other than sequence that the contractor of the test of test of test of the test of test of the test of test of the test of the test of	COOArchOP1108 S. Main St. 102 Aberdeen, SD 57401 Phone: 605-725-4852601 Kansas City St. 7 Rapid City, SD 57701 Phone: 605-716-3652300 N. Phillips Ave. 120 Sioux Falls, SD 57104 Phone: 605-334-9999Joner Cooparch.comESIGN SYNCHRONICITYB11 East Washington Ave. 200 Madison, WI 53703
	<text><text><text><text><text><text><text><text><text></text></text></text></text></text></text></text></text></text>
	ISSUE: Issue Date Project Status REVISION SCHEDULE: REV. # REV. DSC. REV. DATE PROJECT: SDSMT DEVEREAUX LIBRARY PHASE 1 SOUTH DAKOTA SCHOOL OF MINES AND TECHNOLOGY RAPID CITY, SOUTH DAKOTA SHEET TITLE: SECOND FLOOR HVAC PLAN MA4-2

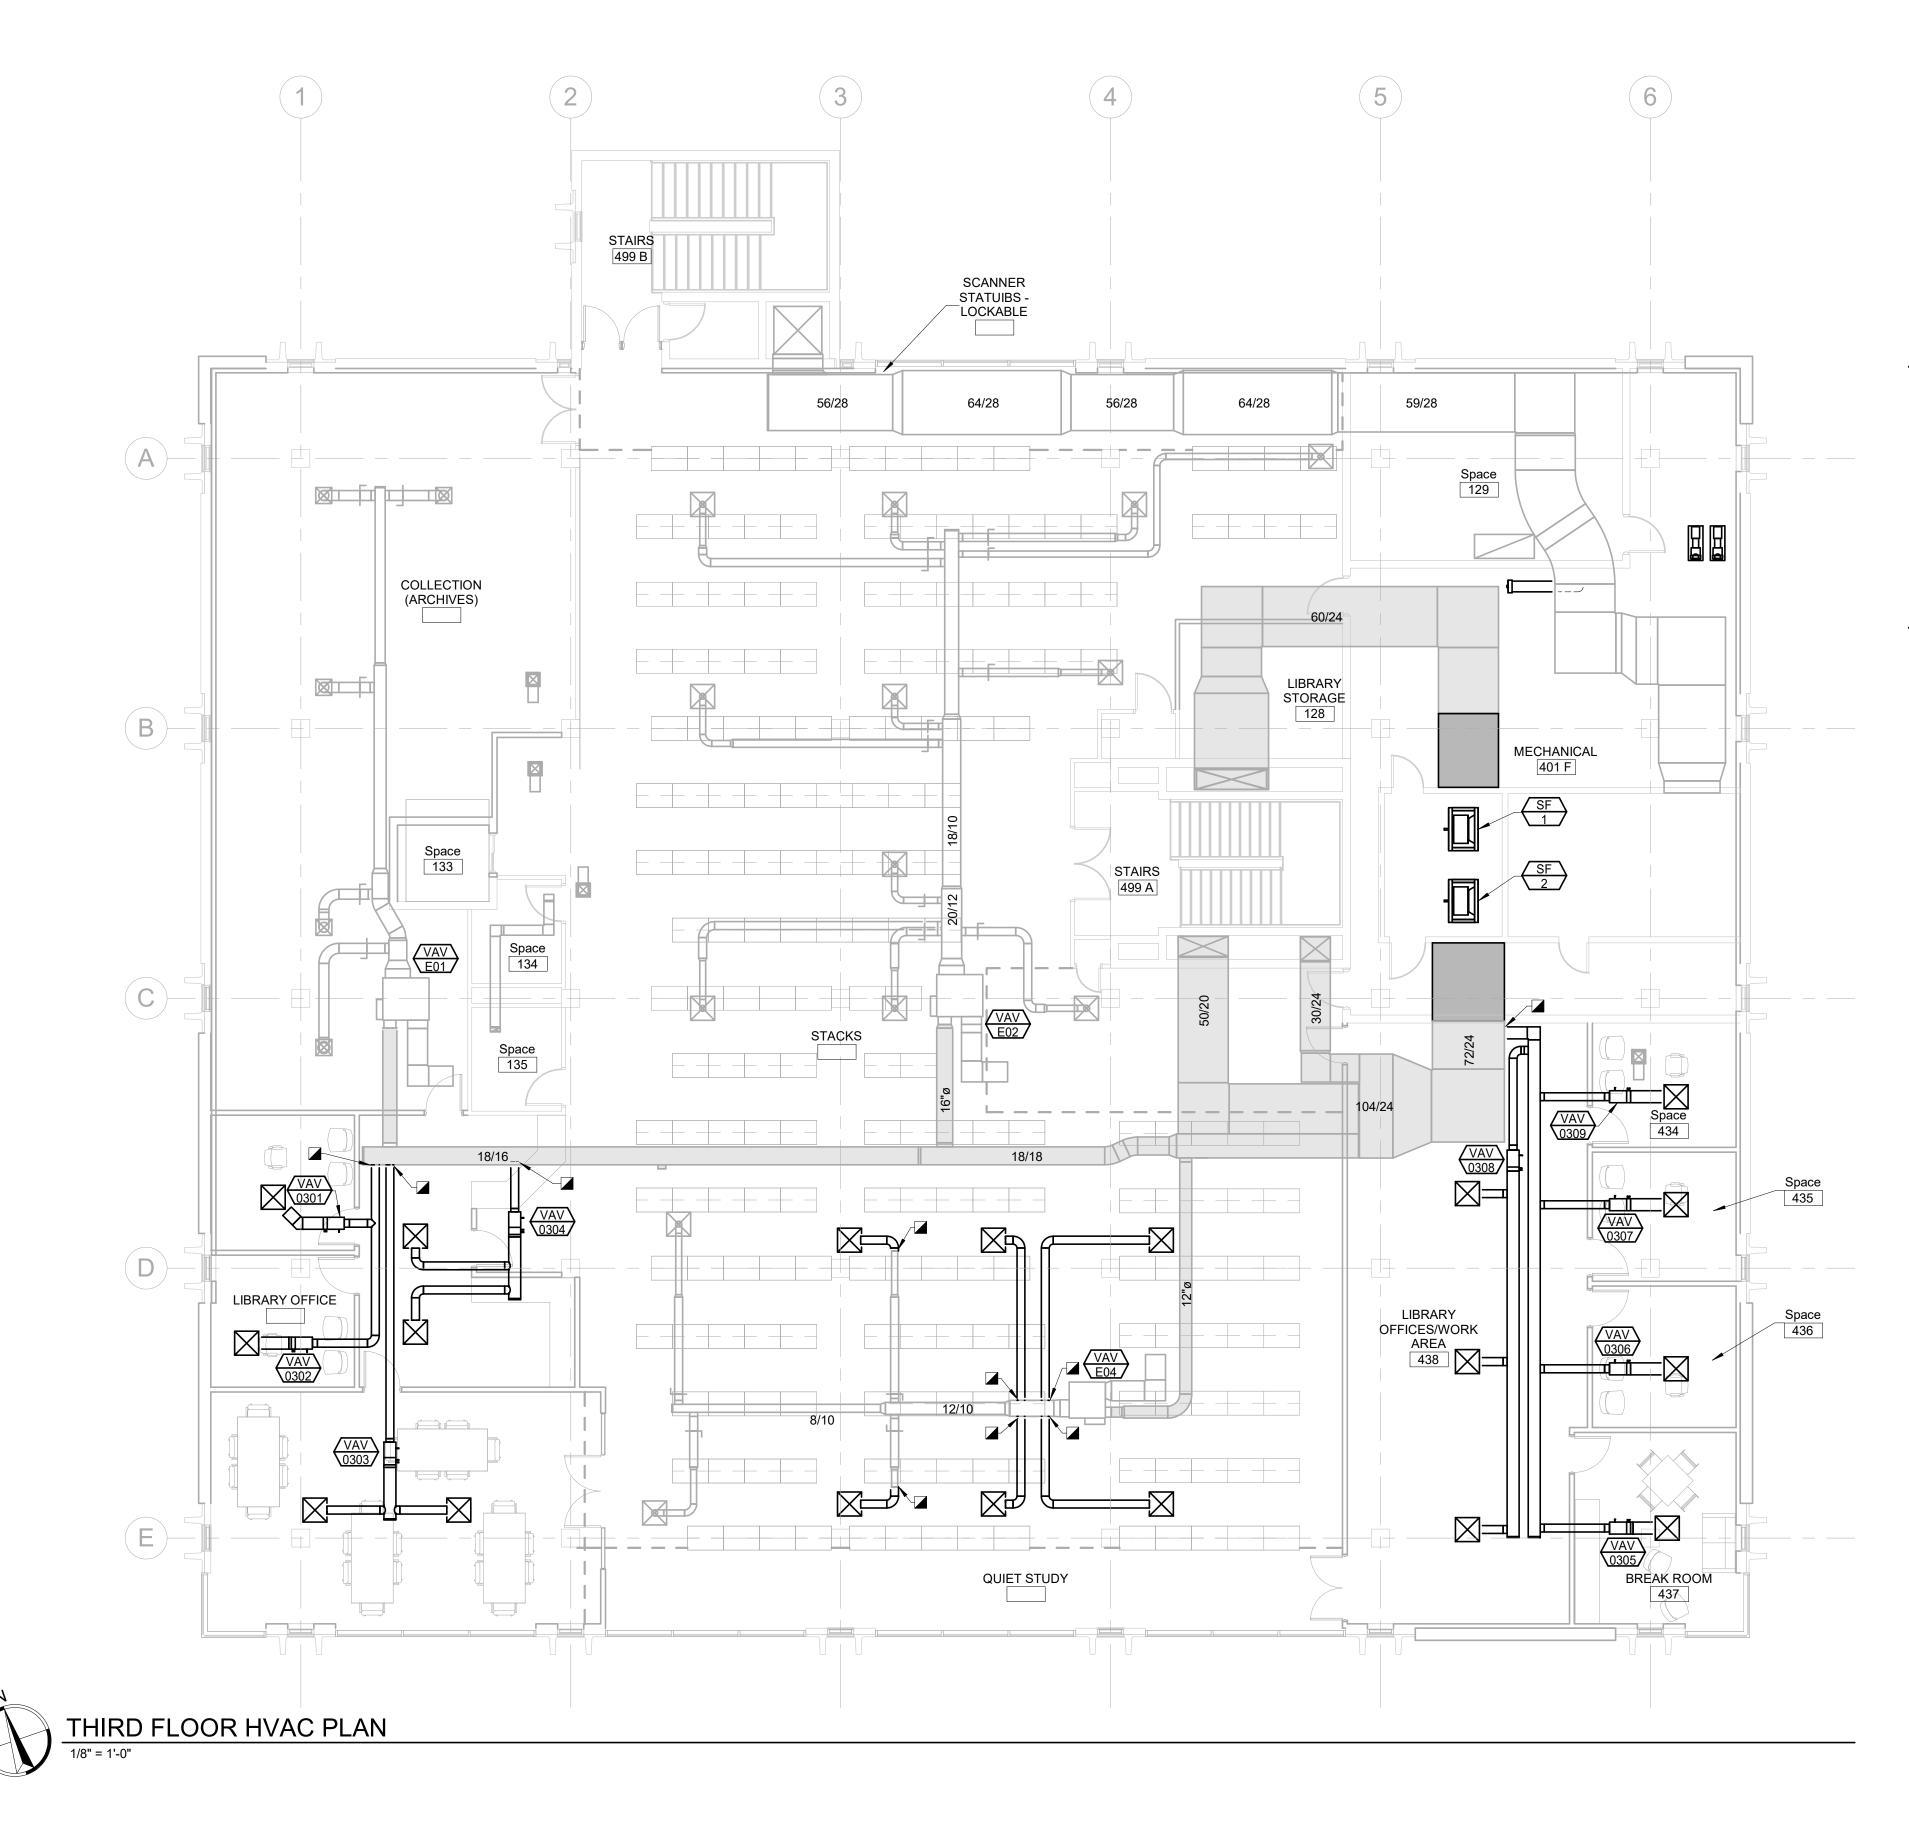

1/3/2020 3:31:19 PM


GENERAL	MECHANICAL	NOTES


A CONTRACTOR TO CONFIRM SIZE AND LOCATION OF EXISTING DUCTWORK.


- B WORK ON THIS PROJECT WILL BE PHASED. THE MECHANICAL CONTRACTOR WILL BE RESPONSIBLE FOR ENSURING THAT AREAS OUTSIDE THE CURRENT PHASE OF WORK CONTINUE TO BE SERVED BY HEATING, COOLING, ETC. SO AS NOT TO INTERRUPT OWNER WORK FLOW. THIS WILL REQUIRE THE CONTRACTOR TO WORK OTHER THAN NORMAL WORK HOURS AT NO ADDITIONAL COST TO THE OWNER.
- C THE MECHANICAL CONTRACTOR IS TO EXTEND, MODIFY AND/OR RELOCATE ANY DUCTWORK, THAT CONTINUES TO SERVE THE SPACE, AS NEEDED SO THAT ALL NEW ARCHITECTURAL, MECHANICAL AND ELECTRICAL WORK SHOWN IN THE REMODEL PLANS CAN BE INSTALLED.


# MECHANICAL SPECIFIC NOTES

CO
Arch <b>OP</b>
1108 S. Main St. 102 Aberdeen, SD 57401 Phone: 605-725-4852 601 Kansas City St. 7 Rapid City, SD 57701 Phone: 605-716-3652 300 N. Phillips Ave. 120 Sioux Falls, SD 57104 Phone: 605-334-9999 co-oparch.com
STRANG DESIGN SYNCHRONICITY
<text><text><text><text><text><text></text></text></text></text></text></text>
CO-OP PROJECT NO: 1936
PRELIMINARY NOT FOR CONSTRUCTION
ISSUE: Issue Date Project Status REVISION SCHEDULE: REV. # REV. DSC. REV. DATE
PROJECT: SDSMT DEVEREAUX LIBRARY PHASE 1 SOUTH DAKOTA SCHOOL OF MINES AND TECHNOLOGY RAPID CITY, SOUTH DAKOTA
<u>SHEET TITLE:</u> THIRD FLOOR HVAC PLAN
M4-3

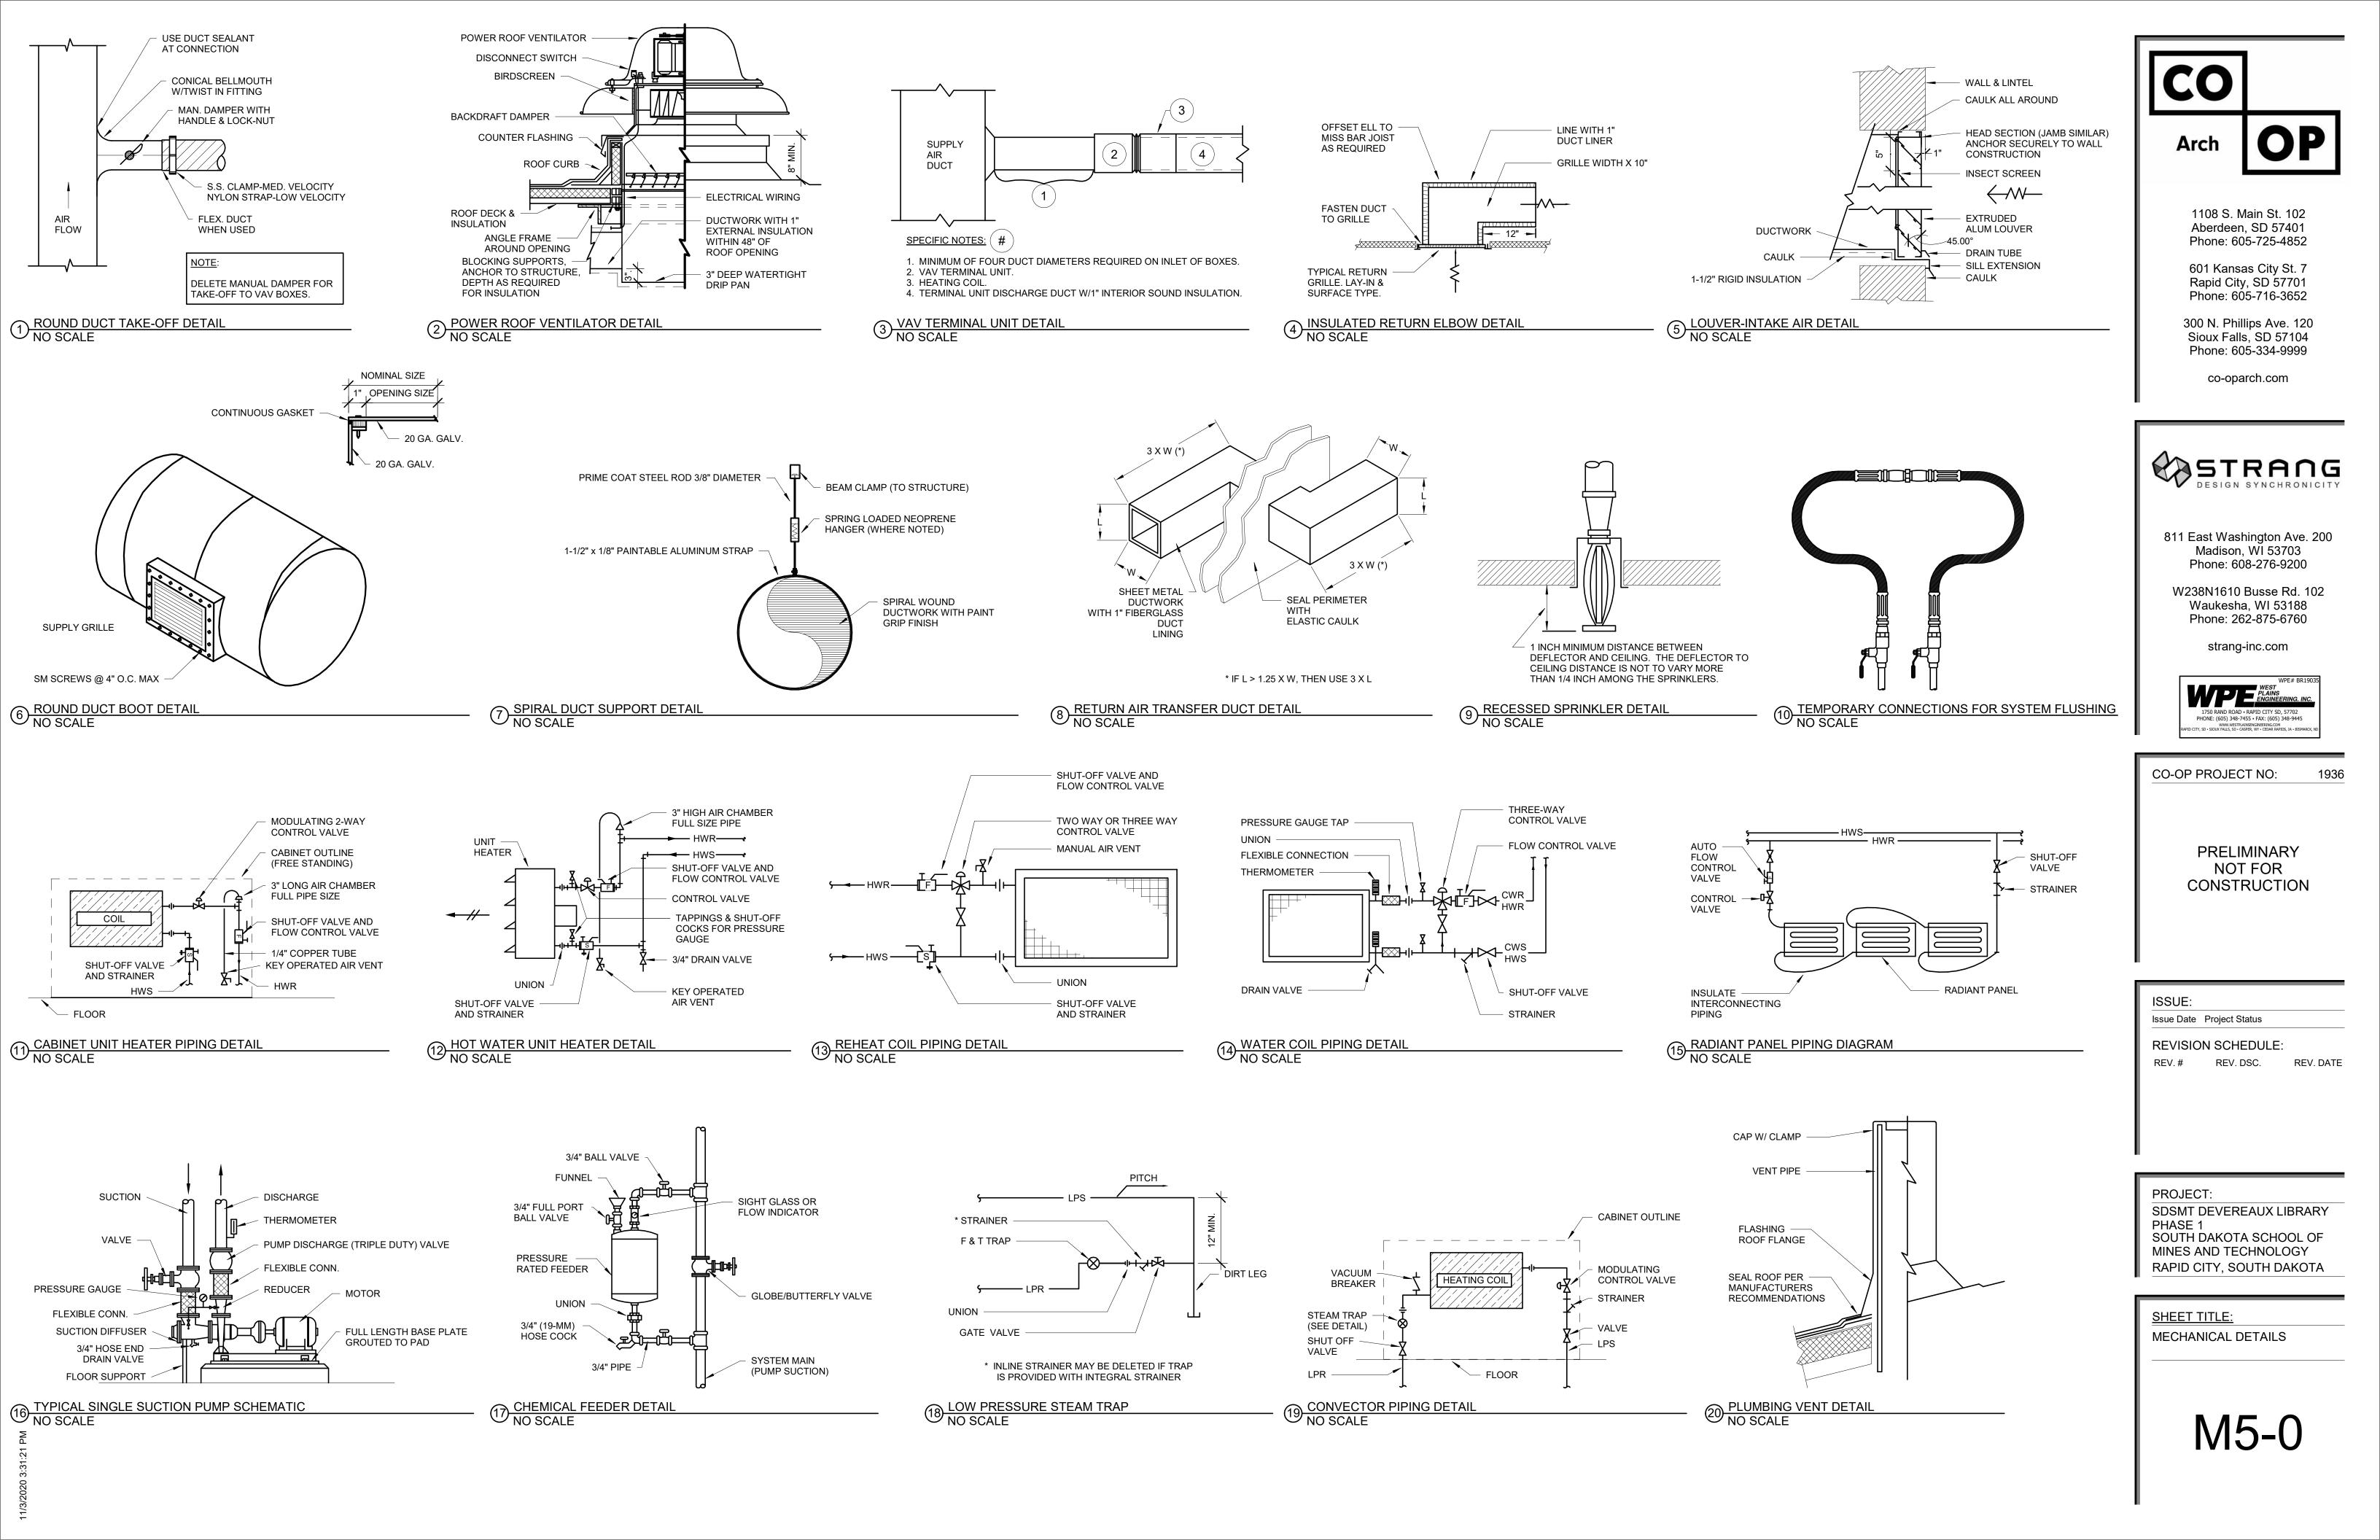


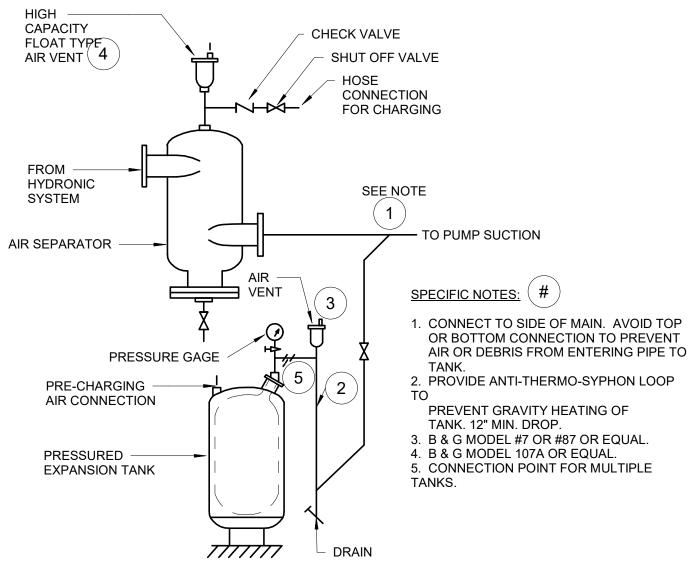

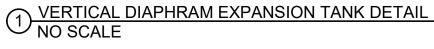

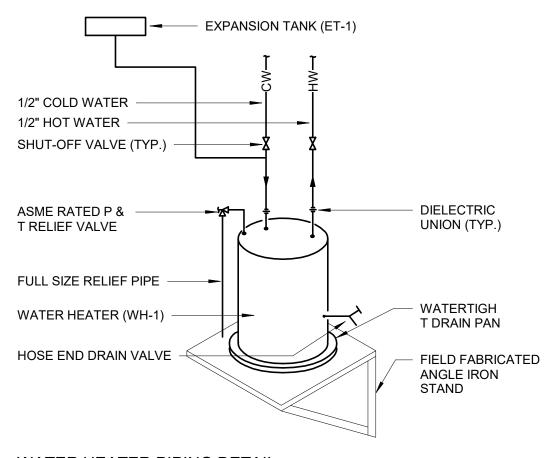



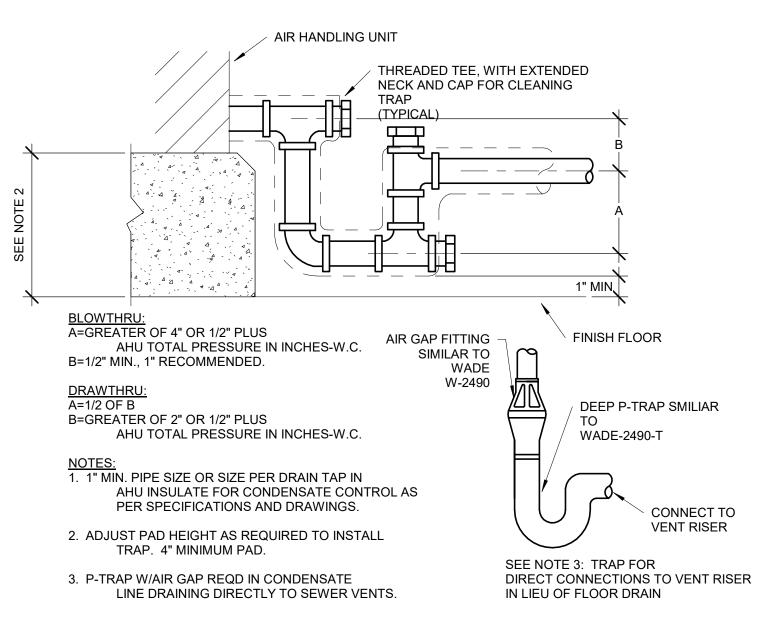

IVIE	CHANICAL SYMBO	JLS
-CW       COLD WATER PIPE         -CW-       UNDERGROUND COLD WATER         PIPE       -PD         PD       PUMP DISCHARGE         -HPS       HIGH PRESSURE STEAM         -HPR       HIGH PRESSURE RETURN         -PC       PUMPED CONDENSATE PIPE         -G       NATURAL GAS         -HWS       HOT WATER HEATING SUPPLY         -CWS       CHILLED WATER SUPPLY PIPE         -HPWS       HEAT PUMP WATER SUPPLY         -GLWS       GROUND LOOP WATER SUPPLY         -FOS       FUEL OIL SUPPLY         -FOV       FUEL OIL VENT         -RL       REFRIGERANT LIQUID PIPE         -DD       EQUIPMENT DRAIN         -F       FIRE SPRINKLER PIPE         -O       PENDANT TYPE SPRINKLER HEAD         -F       FIRE SOW DOWN         O       ELBOW DOWN         O       ELBOW UP         -C       TEE DOWN         -F       PIPE ANCHOR         -PIPE ANCHOR       PIPE ANCHOR         -PIPE ANCHOR       FLEXIBLE PIPE CONNECTION         -F       FLEXIBLE PIPE CONNECTION         -F       FLEXIBLE PIPE CONNECTION         -F       FLEXIBLE PIPE CONNECTION	HW       HOT WATER PIPE UNDERGROUND HOT WATER         -HW-       PIPE         SAN       ABOVE FLOOR WASTE PIPE         SST       ABOVE FLOOR STORM PIPE         -OST       ABOVE FLOOR OVERFLOW STORM PIPE         -PD       PUMP DISCHARGE         -MPS       MEDIUM PRESSURE STEAM         -MPR       MEDIUM PRESSURE RETURN         -HWR       HOT WATER HEATING RETURN         -GUWR       GROUND LOOP WATER RETURN         -GLWR       GROUND LOOP WATER RETURN         -FOR       FUEL OIL RETURN         -FOG       FUEL OIL GAUGE         -RS       REFRIGERANT SUCTION PIPE         SPo       STAND PIPE         -O       UPRIGHT SPRINKLER HEAD         ••       POST INDICATOR VALVE         ••       FLOW MEASURING DEVICE         ••       FLOW MEASURING DEVICE         ••       FLOW MEASURING DEVICE         ••       SHUT OFF VALVE         ••       SHUT OFF VALVE         ••       SHUT OFF VALVE         ••       BALANCING VALVE         ••       SHUT OFF VALVE         ••       SHUT OFF VALVE         ••       SHUT OFF VALVE         ••       DOMESTIC WATER TEMPERING <td>-RHW       CIRCULATING HOT WATER PIPE         -RHW       UNDERGOUND CIRCULATING HOT         -RHW       VENT PIPE         -LPS       LOW PRESSURE STEAM         -LPR       LOW PRESSURE RETURN         -HG       HOT GAS         +ro       FIRE DEPT. HOSE VALVE         -O       RECESSED SPRINKLER HEAD         -       -         -       FLOW ALARM         Y       PRESSURE GAUGE         -       STATIC PRESSURE SENSOR         -       FLOW CONTROL VALVE         -       STEAM TRAP         -       STEAM TRAP         -       FLOW CONTROL VALVE         -       FLOW CONTROL VALVE         -       -         -       FLOW CONTROL VALVE         -       -         -</td>	-RHW       CIRCULATING HOT WATER PIPE         -RHW       UNDERGOUND CIRCULATING HOT         -RHW       VENT PIPE         -LPS       LOW PRESSURE STEAM         -LPR       LOW PRESSURE RETURN         -HG       HOT GAS         +ro       FIRE DEPT. HOSE VALVE         -O       RECESSED SPRINKLER HEAD         -       -         -       FLOW ALARM         Y       PRESSURE GAUGE         -       STATIC PRESSURE SENSOR         -       FLOW CONTROL VALVE         -       STEAM TRAP         -       STEAM TRAP         -       FLOW CONTROL VALVE         -       FLOW CONTROL VALVE         -       -         -       FLOW CONTROL VALVE         -       -         RADIATION ELEMENT	CONNECT TO EXIST. SERVICE	
5'-0" T LENGTH		DLS MANUAL VOLUME DAMPER BRANCH DUCT INTO SIDE OF MAIN DUCT


	SUPPLY DUCT (UP & DOWN)
	RETURN DUCT (UP & DOWN)
	EXHAUST DUCT (UP & DOWN)
W R R	STANDARD RADIUS ELBOW R EQUAL W (MINIMUM)
	DUCT TURN WITH TURN VANES
	FLEXIBLE DUCT CONNECTION
Z////Z	SPIRAL DUCTWORK
	LOW PRESURE DUCTWORK MAX 2" W.G. PRESSURE
	MEDIUM PRESSURE DUCTWORK 2"-6" W.G. PRESSURE
FSCMB	F - FIRE DAMPER M - MOTORIZED DAMPER S - SMOKE DAMPER B - BACKDRAFT DAMPER C - COMBINATION FIRE SMOKE DAMPER

# 3 AHU DRAIN TRAP DETAIL NO SCALE

# MECHANICAL SYMBOLS

	MANUAL VOLUME DAMPER
1/2 A	BRANCH DUCT INTO SIDE OF MAIN DUCT
	DUCT RISE OR DROP IN DIRECTION OF AIR FLOW
لمحتلي 12/8 م	DUCT DIMENSION- WIDTH x DEPTH
22	DUCT INSULATION (SEE SPECIFICATION)
	DUCT TURN AND AIR SPLIT TYPE TAKEOFF (NON-ADJUSTABLE)
S-1 200 CFM	GRILLE, REGISTER & DIFFUSER DESIGNATION SUPPLY, RETURN, EXHAUST, & TRANSFER
EF TYPE OF EQUIP EQUIP. NO.	EQUIPMENT DESIGNATION
++++++	FLEX DUCT (5' MAXIMUM)

CO
Arch <b>OP</b>
1108 S. Main St. 102 Aberdeen, SD 57401 Phone: 605-725-4852 601 Kansas City St. 7 Rapid City, SD 57701 Phone: 605-716-3652 300 N. Phillips Ave. 120 Sioux Falls, SD 57104 Phone: 605-334-9999 co-oparch.com
STRANG DESIGN SYNCHRONICITY
811 East Washington Ave. 200 Madison, WI 53703 Phone: 608-276-9200
W238N1610 Busse Rd. 102 Waukesha, WI 53188 Phone: 262-875-6760
strang-inc.com
WEST PLAINS ENGINEERING. INC. 1750 RAND ROAD • RAPID CITY SD, 57702 PHONE: (605) 348-7455 • FAX: (605) 348-9445 www.westPLAINSONIEREING.COM RAPID CITY, SD • SIOUX FALLS, SD • CASPER. WY • CEDAR RAPIDS, IA • BISMARCK, ND
CO-OP PROJECT NO: 1936
PRELIMINARY NOT FOR CONSTRUCTION
ISSUE: Issue Date Project Status REVISION SCHEDULE: REV. # REV. DSC. REV. DATE
PROJECT: SDSMT DEVEREAUX LIBRARY PHASE 1 SOUTH DAKOTA SCHOOL OF MINES AND TECHNOLOGY RAPID CITY, SOUTH DAKOTA
<u>SHEET TITLE:</u> MECHANICAL DETAILS & SYMBOLS
M5-1

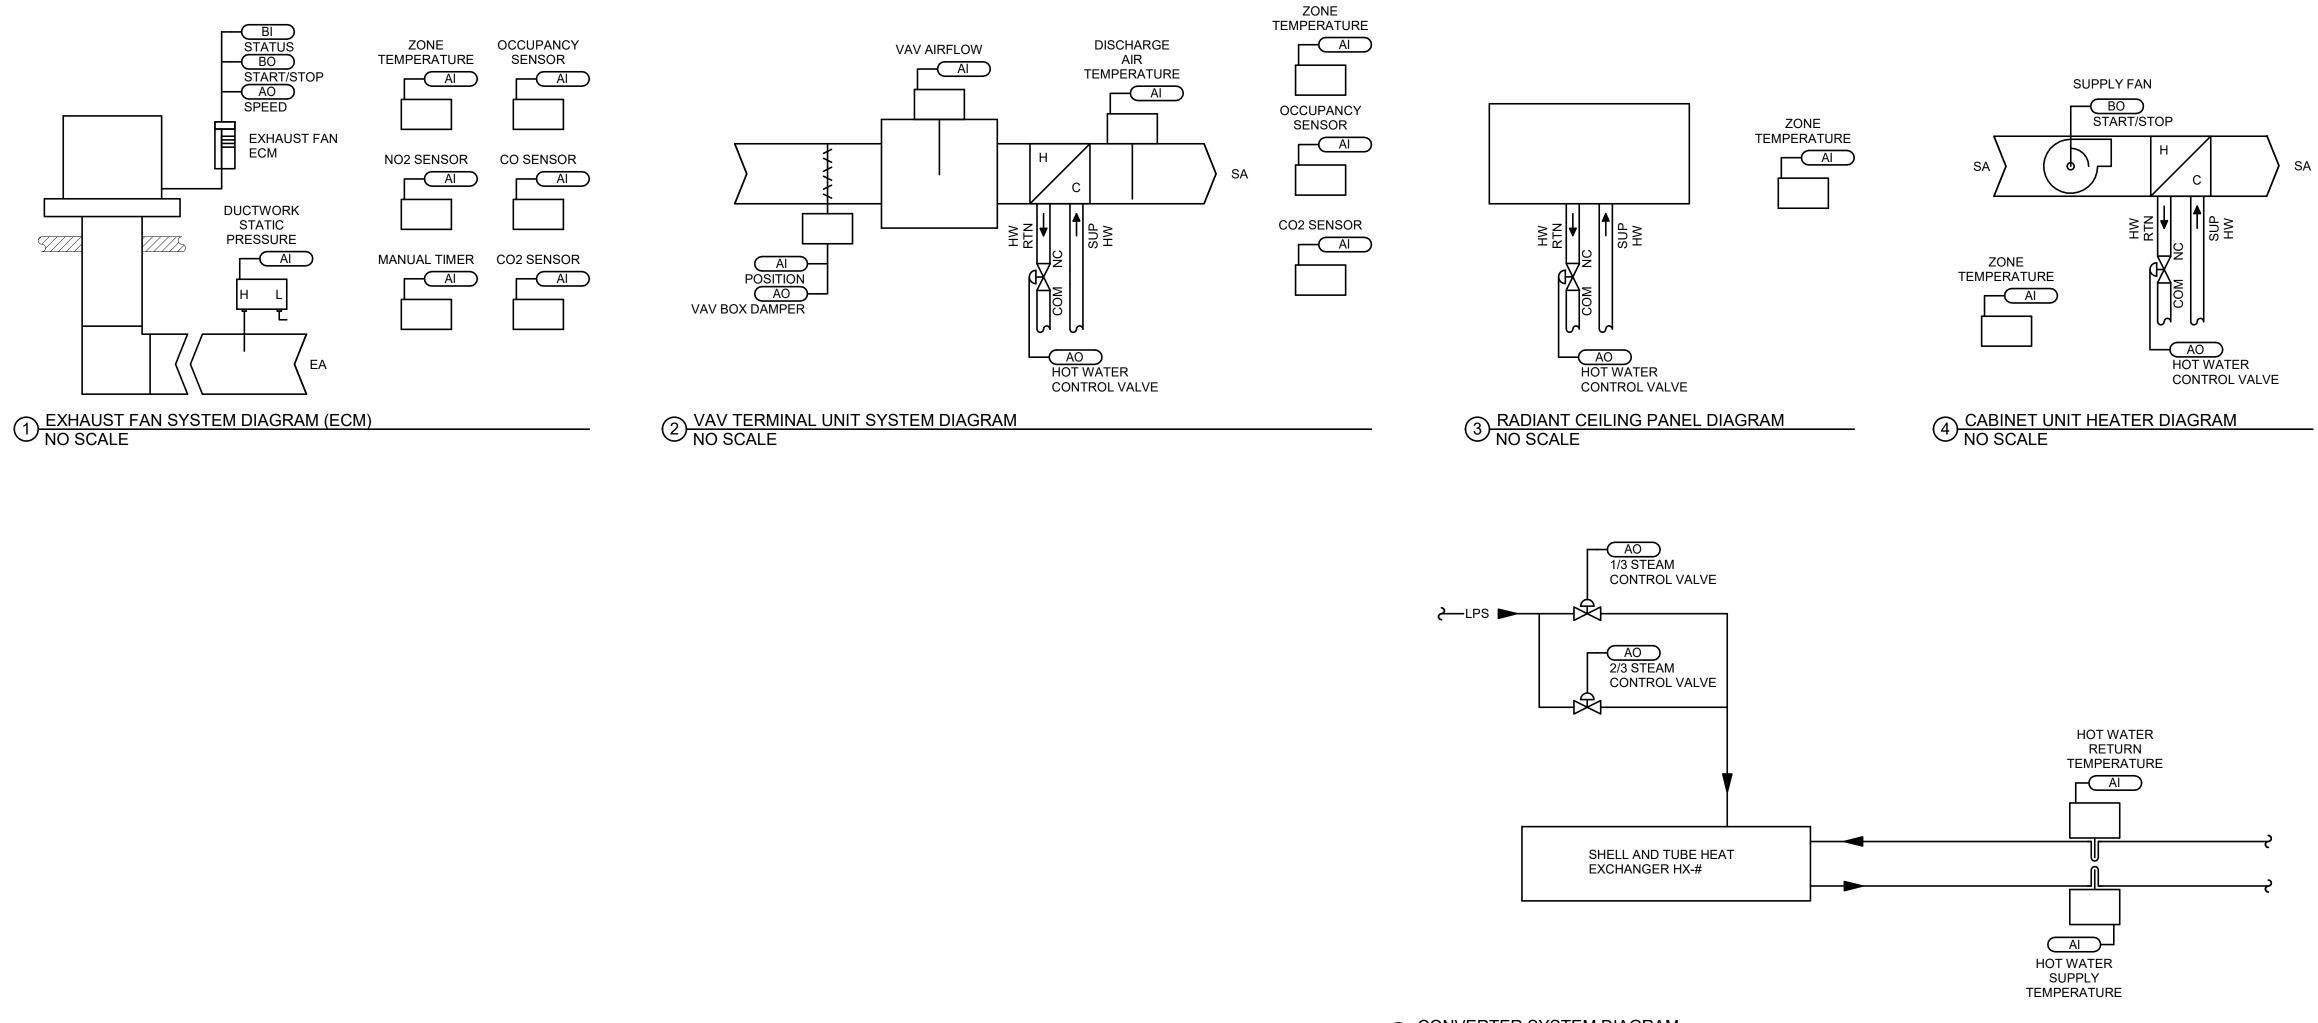

6 CONVERTER SYSTEM DIAGRAM NO SCALE

<complex-block></complex-block>	
SUMP PUMP         SP-1 CONTROL         ALARM         Bi         HGH LEVEL         ALARM         Bi         HGH LEVEL         ALARM         Bi         SUMP PUMP SYSTEM DIAGRAM         NO SCALE	<image/> <text><text><text><text><text><text><text><text><text></text></text></text></text></text></text></text></text></text>
	ISSUE: Issue Date Project Status REVISION SCHEDULE: REV. # REV. DSC. REV. DATE PROJECT: SDSMT DEVEREAUX LIBRARY PHASE 1 SOUTH DAKOTA SCHOOL OF MINES AND TECHNOLOGY RAPID CITY, SOUTH DAKOTA SHEET TITLE: MECHANICAL DIAGRAMS MD5-2

	PLUMBING FIXTURE SCHEDULE																
UNIT TYPE	UNIT NUMBER	MANUFACTURER	MODEL	FIXTURE TYPE	WASTE	VENT					SUPPLY CW HW						TRIM/REMARKS
P	1A	AMERICAN STANDARD	AFWALL 3351.101	WATER CLOSET (WALLHUNG FV HET) 1.2 GPF	4"	2"	1 1/4"		OLSONITE #95, WHITE OPEN FRONT SS CHECK HINGE, A ELONGATED BOWL SIPHON JET, SLOAN CROWN OPTIM SMOOTH 1.2, BATTERY OPERATED, 1.2 GPF, ADA COMPLIA MINIMUM 800 MAP FLUSH PERFORMANCE **								
P	1B	AMERICAN STANDARD	AFWALL 3351.101	WATER CLOSET (WALLHUNG FV HET) 1.2 GPF MOUNT AT ADA HEIGHT	4"	2"	1 1/4"		OLSONITE #95, WHITE OPEN FRONT SS CHECK HINGE, AI ELONGATED BOWL SIPHON JET, SLOAN CROWN OPTIM SMOOTH 1.2, BATTERY OPERATED, 1.2 GPF, ADA COMPLIA MINIMUM 800 MAP FLUSH PERFORMANCE **								
Р	2B	AMERICAN STANDARD	WASHBRO OK FLOWISE 6590.001E C	URINAL (FV) 0.125 GPF MOUNT AT ADA HEIGHT	2"	1 1/2"	3/4"		WHITE SIPHON JET, SLOAN ROYAL 186-0.125 SMOOTH, BAT OPERATED AUTOMATIC FLUSH VALVE, 0.125 GPF, ADA COMPLIANT								
Р	3A	AMERICAN STANDARD	AQUALYN 0476.028	LAVATORY (COUNTER TYPE) 0.5 GPM	2"	1 1/2"	1/2"	1/2"	SLOAN EBF85 BATTERY OPERATED SENSOR OPERATED FAI 0.5 GPM AERATOR, GRID DRAIN, HANDI-TRAP SUPPLY/DR PROTECTION, ADA, POWERS LFG480 THERMOSTATIC MIX VALVE WITH INTEGRAL CHECK VALVES								

IINGE, ADA N OPTIMA COMPLIANT, E \*\*

IINGE, ADA N OPTIMA COMPLIANT, E \*\*

TH, BATTERY SPF, ADA

ATED FAUCET, PPLY/DRAIN ATIC MIXING

	STEAM CONVERTER SCHEDULE											
UNIT TYPE	UNIT NUMBER	MANUFACTURER	MODEL	LOCATION	SERVICE	GPM	WATER PRES. DROP	EWT	LWT	втин	#/HR STEAM	STEAM PRES.
НХ	1	ARMSTRONG	WS-1003-200-1-CSSSS NN-20		HEATING WATER	0	0.00 ftH2O	110 °F	140 °F	0	0	0 ftH2O

COMMENTS: HOT WATER SOLUTION BASED ON 30% PROPYLENE GLYCOL. 1

PROVIDE VACUUM BREAKER. 2 PROVIDE MOUNTING RACK(S) FOR CONVERTORS.

3 4

MAX WATER VELOCITY OF 4.5 FT/SEC. MINIMUM HEAT TRANSFER AREA OF 40.9 SQ. FT. 5

UNIT         UNIT         MANUFACTURER         MODEL         COO           VAV         0101         KRUEGER         LMHS 12         230           VAV         0102         KRUEGER         LMHS 12         230           VAV         0103         KRUEGER         LMHS 12         230           VAV         0104         KRUEGER         LMHS 4         0           VAV         0105         KRUEGER         LMHS 4         0           VAV         0106         KRUEGER         LMHS 4         0           VAV         0107         KRUEGER         LMHS 4         0           VAV         0108         KRUEGER         LMHS 4         0           VAV         0109         KRUEGER         LMHS 4         0           VAV         0111         KRUEGER         LMHS 4         0           VAV         0113         KRUEGER         LMHS 4         0           VAV         0116         KRUEGER         LMHS 4         0           VAV         0117         KRUEGER         LMHS 4         0           VAV         0118         KRUEGER         LMHS 4         0           VAV         0118         KRUEGER	PRIMARY (						IEDU
TYPE         NUMBER         MANUFACTURER         MODEL         MAX           VAV         0101         KRUEGER         LMHS 12         230           VAV         0102         KRUEGER         LMHS 12         230           VAV         0103         KRUEGER         LMHS 12         230           VAV         0103         KRUEGER         LMHS 4         0           VAV         0105         KRUEGER         LMHS 4         0           VAV         0106         KRUEGER         LMHS 4         0           VAV         0108         KRUEGER         LMHS 4         0           VAV         0109         KRUEGER         LMHS 4         0           VAV         0110         KRUEGER         LMHS 4         0           VAV         0111         KRUEGER         LMHS 4         0           VAV         0113         KRUEGER         LMHS 4         0           VAV         0116         KRUEGER         LMHS 4         0           VAV         0116         KRUEGER         LMHS 4         0           VAV         0117         KRUEGER         LMHS 4         0           VAV         0118         KRUEGER		CFM					REHEA
VAV         0101         KRUEGER         LMHS 12         230           VAV         0102         KRUEGER         LMHS 12         230           VAV         0103         KRUEGER         LMHS 12         230           VAV         0104         KRUEGER         LMHS 4         0           VAV         0105         KRUEGER         LMHS 4         0           VAV         0106         KRUEGER         LMHS 4         0           VAV         0107         KRUEGER         LMHS 4         0           VAV         0108         KRUEGER         LMHS 4         0           VAV         0110         KRUEGER         LMHS 4         0           VAV         0111         KRUEGER         LMHS 4         0           VAV         0111         KRUEGER         LMHS 4         0           VAV         0113         KRUEGER         LMHS 4         0           VAV         0113         KRUEGER         LMHS 4         0           VAV         0116         KRUEGER         LMHS 4         0           VAV         0117         KRUEGER         LMHS 4         0           VAV         0118         KRUEGER		HEATING		INLET	0.014		
VAV         0102         KRUEGER         LMHS 12         230           VAV         0103         KRUEGER         LMHS 12         230           VAV         0104         KRUEGER         LMHS 1         0           VAV         0105         KRUEGER         LMHS 4         0           VAV         0106         KRUEGER         LMHS 4         0           VAV         0107         KRUEGER         LMHS 4         0           VAV         0108         KRUEGER         LMHS 4         0           VAV         0110         KRUEGER         LMHS 4         0           VAV         0111         KRUEGER         LMHS 4         0           VAV         0113         KRUEGER         LMHS 4         0           VAV         0114         KRUEGER         LMHS 4         0           VAV         0115         KRUEGER         LMHS 4         0           VAV         0118         KRUEGER         LMHS 4         0           VAV         0118         KRUEGER         LMHS 4         0           VAV         0120         KRUEGER         LMHS 4         0           VAV         0121         KRUEGER <td< td=""><td>MIN 10</td><td>125</td><td>I STATIC</td><td>CONNECTION 12"</td><td><b>GPM</b></td><td>BTUH</td><td></td></td<>	MIN 10	125	I STATIC	CONNECTION 12"	<b>GPM</b>	BTUH	
VAV         0103         KRUEGER         LMHS 12         230           VAV         0104         KRUEGER         LMHS 4         0           VAV         0105         KRUEGER         LMHS 4         0           VAV         0106         KRUEGER         LMHS 4         0           VAV         0108         KRUEGER         LMHS 4         0           VAV         0109         KRUEGER         LMHS 4         0           VAV         0109         KRUEGER         LMHS 4         0           VAV         0110         KRUEGER         LMHS 4         0           VAV         0111         KRUEGER         LMHS 4         0           VAV         01113         KRUEGER         LMHS 4         0           VAV         0113         KRUEGER         LMHS 4         0           VAV         0116         KRUEGER         LMHS 4         0           VAV         0117         KRUEGER         LMHS 4         0           VAV         0118         KRUEGER         LMHS 4         0           VAV         01120         KRUEGER         LMHS 4         0           VAV         0121         KRUEGER	10	125	1.00 in-wg	12	1	1	1
VAV         0104         KRUEGER         LMHS 4         0           VAV         0105         KRUEGER         LMHS 4         0           VAV         0106         KRUEGER         LMHS 4         0           VAV         0107         KRUEGER         LMHS 4         0           VAV         0109         KRUEGER         LMHS 4         0           VAV         0109         KRUEGER         LMHS 4         0           VAV         0110         KRUEGER         LMHS 4         0           VAV         0111         KRUEGER         LMHS 4         0           VAV         0111         KRUEGER         LMHS 4         0           VAV         0113         KRUEGER         LMHS 4         0           VAV         0114         KRUEGER         LMHS 4         0           VAV         0116         KRUEGER         LMHS 4         0           VAV         0117         KRUEGER         LMHS 4         0           VAV         0118         KRUEGER         LMHS 4         0           VAV         0120         KRUEGER         LMHS 4         0           VAV         0121         KRUEGER         LMHS	10	125	1.00 in-wg	12"	1	1	1
VAV         0106         KRUEGER         LMHS 4         0           VAV         0107         KRUEGER         LMHS 4         0           VAV         0108         KRUEGER         LMHS 4         0           VAV         0109         KRUEGER         LMHS 4         0           VAV         0110         KRUEGER         LMHS 4         0           VAV         0111         KRUEGER         LMHS 4         0           VAV         0112         KRUEGER         LMHS 4         0           VAV         0113         KRUEGER         LMHS 4         0           VAV         0114         KRUEGER         LMHS 4         0           VAV         0116         KRUEGER         LMHS 4         0           VAV         0117         KRUEGER         LMHS 4         0           VAV         0118         KRUEGER         LMHS 4         0           VAV         0120         KRUEGER         LMHS 4         0           VAV         0121         KRUEGER         LMHS 4         0           VAV         0123         KRUEGER         LMHS 4         230           VAV         0124         KRUEGER         LMH	175	125	0.75 in-wg	4"	0	0	180/140
VAV         0107         KRUEGER         LMHS 4         0           VAV         0108         KRUEGER         LMHS 4         0           VAV         0109         KRUEGER         LMHS 4         0           VAV         0110         KRUEGER         LMHS 4         0           VAV         0111         KRUEGER         LMHS 4         0           VAV         0112         KRUEGER         LMHS 4         0           VAV         0113         KRUEGER         LMHS 4         0           VAV         0114         KRUEGER         LMHS 4         0           VAV         0116         KRUEGER         LMHS 4         0           VAV         0117         KRUEGER         LMHS 4         0           VAV         0118         KRUEGER         LMHS 4         0           VAV         0120         KRUEGER         LMHS 4         0           VAV         0121         KRUEGER         LMHS 4         0           VAV         0123         KRUEGER         LMHS 8         230           VAV         0124         KRUEGER         LMHS 8         230           VAV         0125         KRUEGER         L	175	125	0.75 in-wg	4"	0	0	180/140
VAV         0108         KRUEGER         LMHS 4         0           VAV         0109         KRUEGER         LMHS 4         0           VAV         0110         KRUEGER         LMHS 4         0           VAV         0111         KRUEGER         LMHS 4         0           VAV         0112         KRUEGER         LMHS 4         0           VAV         0113         KRUEGER         LMHS 4         0           VAV         0116         KRUEGER         LMHS 4         0           VAV         0116         KRUEGER         LMHS 4         0           VAV         0116         KRUEGER         LMHS 4         0           VAV         0118         KRUEGER         LMHS 4         0           VAV         0112         KRUEGER         LMHS 4         0           VAV         0120         KRUEGER         LMHS 4         0           VAV         0121         KRUEGER         LMHS 4         0           VAV         0122         KRUEGER         LMHS 4         0           VAV         0123         KRUEGER         LMHS 4         230           VAV         0124         KRUEGER         LMH	175	125	0.75 in-wg	4"	0	0	180/140
VAV         0109         KRUEGER         LMHS 4         0           VAV         0110         KRUEGER         LMHS 4         0           VAV         0111         KRUEGER         LMHS 4         0           VAV         0112         KRUEGER         LMHS 4         0           VAV         0113         KRUEGER         LMHS 4         0           VAV         0114         KRUEGER         LMHS 4         0           VAV         0115         KRUEGER         LMHS 4         0           VAV         0116         KRUEGER         LMHS 4         0           VAV         0117         KRUEGER         LMHS 4         0           VAV         0118         KRUEGER         LMHS 4         0           VAV         0120         KRUEGER         LMHS 4         0           VAV         0121         KRUEGER         LMHS 4         0           VAV         0123         KRUEGER         LMHS 8         230           VAV         0124         KRUEGER         LMHS 12         230           VAV         0126         KRUEGER         LMHS 12         230           VAV         0201         KRUEGER         <	175	125	0.75 in-wg	4"	0	0	180/140
VAV         0110         KRUEGER         LMHS 4         0           VAV         0111         KRUEGER         LMHS 4         0           VAV         0112         KRUEGER         LMHS 4         0           VAV         0113         KRUEGER         LMHS 4         0           VAV         0114         KRUEGER         LMHS 4         0           VAV         0115         KRUEGER         LMHS 4         0           VAV         0116         KRUEGER         LMHS 4         0           VAV         0117         KRUEGER         LMHS 4         0           VAV         0118         KRUEGER         LMHS 4         0           VAV         0120         KRUEGER         LMHS 4         0           VAV         0121         KRUEGER         LMHS 4         0           VAV         0123         KRUEGER         LMHS 4         0           VAV         0124         KRUEGER         LMHS 4         230           VAV         0125         KRUEGER         LMHS 4         275           VAV         0126         KRUEGER         LMHS 4         275           VAV         0201         KRUEGER <td< td=""><td>175</td><td>125</td><td>0.75 in-wg</td><td>4"</td><td>0</td><td>0</td><td>180/140</td></td<>	175	125	0.75 in-wg	4"	0	0	180/140
VAV         0111         KRUEGER         LMHS 4         0           VAV         0112         KRUEGER         LMHS 4         0           VAV         0113         KRUEGER         LMHS 4         0           VAV         0114         KRUEGER         LMHS 4         0           VAV         0115         KRUEGER         LMHS 4         0           VAV         0116         KRUEGER         LMHS 4         0           VAV         0117         KRUEGER         LMHS 4         0           VAV         0118         KRUEGER         LMHS 4         0           VAV         01120         KRUEGER         LMHS 4         0           VAV         0121         KRUEGER         LMHS 4         0           VAV         0122         KRUEGER         LMHS 4         0           VAV         0123         KRUEGER         LMHS 8         230           VAV         0124         KRUEGER         LMHS 4         275           VAV         0125         KRUEGER         LMHS 4         275           VAV         0201         KRUEGER         LMHS 4         0           VAV         0203         KRUEGER <t< td=""><td>175</td><td>125</td><td>0.75 in-wg</td><td>4"</td><td>0</td><td>0</td><td>180/140</td></t<>	175	125	0.75 in-wg	4"	0	0	180/140
VAV         0112         KRUEGER         LMHS 4         0           VAV         0113         KRUEGER         LMHS 4         0           VAV         0114         KRUEGER         LMHS 4         0           VAV         0115         KRUEGER         LMHS 4         0           VAV         0116         KRUEGER         LMHS 4         0           VAV         0117         KRUEGER         LMHS 4         0           VAV         0118         KRUEGER         LMHS 4         0           VAV         0119         KRUEGER         LMHS 4         0           VAV         0120         KRUEGER         LMHS 4         0           VAV         0121         KRUEGER         LMHS 4         0           VAV         0123         KRUEGER         LMHS 8         230           VAV         0125         KRUEGER         LMHS 12         230           VAV         0126         KRUEGER         LMHS 4         0           VAV         0201         KRUEGER         LMHS 4         0           VAV         0202         KRUEGER         LMHS 4         0           VAV         0203         KRUEGER	175	125	0.75 in-wg	4"	0	0	180/140
VAV         0113         KRUEGER         LMHS 8         230           VAV         0114         KRUEGER         LMHS 4         0           VAV         0115         KRUEGER         LMHS 4         0           VAV         0116         KRUEGER         LMHS 4         0           VAV         0117         KRUEGER         LMHS 4         0           VAV         0118         KRUEGER         LMHS 4         0           VAV         0119         KRUEGER         LMHS 4         0           VAV         0120         KRUEGER         LMHS 4         0           VAV         0121         KRUEGER         LMHS 4         0           VAV         0123         KRUEGER         LMHS 8         230           VAV         0124         KRUEGER         LMHS 12         230           VAV         0125         KRUEGER         LMHS 12         230           VAV         0126         KRUEGER         LMHS 4         0           VAV         0201         KRUEGER         LMHS 4         0           VAV         0203         KRUEGER         LMHS 4         0           VAV         0204         KRUEGER	175	125	0.75 in-wg	4"	0	0	180/140
VAV         0114         KRUEGER         LMHS 4         0           VAV         0115         KRUEGER         LMHS 4         0           VAV         0116         KRUEGER         LMHS 4         0           VAV         0117         KRUEGER         LMHS 4         0           VAV         0117         KRUEGER         LMHS 4         0           VAV         0119         KRUEGER         LMHS 4         0           VAV         0120         KRUEGER         LMHS 4         0           VAV         0121         KRUEGER         LMHS 4         0           VAV         0122         KRUEGER         LMHS 8         230           VAV         0123         KRUEGER         LMHS 8         230           VAV         0126         KRUEGER         LMHS 12         230           VAV         0126         KRUEGER         LMHS 12         230           VAV         0201         KRUEGER         LMHS 12         230           VAV         0203         KRUEGER         LMHS 4         0           VAV         0205         KRUEGER         LMHS 4         0           VAV         0206         KRUEGER	175	125	0.75 in-wg	4"	0	0	180/140
VAV         0115         KRUEGER         LMHS 4         0           VAV         0116         KRUEGER         LMHS 4         0           VAV         0117         KRUEGER         LMHS 4         0           VAV         0118         KRUEGER         LMHS 4         0           VAV         0119         KRUEGER         LMHS 4         0           VAV         0120         KRUEGER         LMHS 4         0           VAV         0121         KRUEGER         LMHS 4         0           VAV         0122         KRUEGER         LMHS 8         230           VAV         0123         KRUEGER         LMHS 8         230           VAV         0125         KRUEGER         LMHS 8         230           VAV         0126         KRUEGER         LMHS 4         275           VAV         0201         KRUEGER         LMHS 12         230           VAV         0202         KRUEGER         LMHS 4         0           VAV         0203         KRUEGER         LMHS 4         0           VAV         0204         KRUEGER         LMHS 4         0           VAV         0206         KRUEGER	10 175	125 125	1.00 in-wg 0.75 in-wg	8" 4"	1 0	1	180/140
VAV         0116         KRUEGER         LMHS 4         0           VAV         0117         KRUEGER         LMHS 4         0           VAV         0118         KRUEGER         LMHS 4         0           VAV         0119         KRUEGER         LMHS 4         0           VAV         0120         KRUEGER         LMHS 4         0           VAV         0121         KRUEGER         LMHS 4         0           VAV         0122         KRUEGER         LMHS 4         0           VAV         0123         KRUEGER         LMHS 4         0           VAV         0124         KRUEGER         LMHS 4         230           VAV         0125         KRUEGER         LMHS 4         275           VAV         0126         KRUEGER         LMHS 12         230           VAV         0201         KRUEGER         LMHS 4         0           VAV         0202         KRUEGER         LMHS 4         0           VAV         0203         KRUEGER         LMHS 4         0           VAV         0205         KRUEGER         LMHS 4         0           VAV         0206         KRUEGER <t< td=""><td>175</td><td>125</td><td>0.75 in-wg</td><td>4"</td><td>0</td><td>0</td><td>180/140</td></t<>	175	125	0.75 in-wg	4"	0	0	180/140
VAV         0117         KRUEGER         LMHS 4         0           VAV         0118         KRUEGER         LMHS 8         230           VAV         0119         KRUEGER         LMHS 4         0           VAV         0120         KRUEGER         LMHS 4         0           VAV         0121         KRUEGER         LMHS 4         0           VAV         0122         KRUEGER         LMHS 4         0           VAV         0123         KRUEGER         LMHS 8         230           VAV         0124         KRUEGER         LMHS 8         230           VAV         0125         KRUEGER         LMHS 12         230           VAV         0126         KRUEGER         LMHS 12         230           VAV         0201         KRUEGER         LMHS 12         230           VAV         0203         KRUEGER         LMHS 12         230           VAV         0204         KRUEGER         LMHS 4         0           VAV         0205         KRUEGER         LMHS 4         0           VAV         0206         KRUEGER         LMHS 4         0           VAV         0208         KRUEGER	175	125	0.75 in-wg	4"	0	0	180/140
VAV         0118         KRUEGER         LMHS 8         230           VAV         0119         KRUEGER         LMHS 4         0           VAV         0120         KRUEGER         LMHS 4         0           VAV         0121         KRUEGER         LMHS 4         0           VAV         0122         KRUEGER         LMHS 4         0           VAV         0123         KRUEGER         LMHS 8         230           VAV         0124         KRUEGER         LMHS 8         230           VAV         0125         KRUEGER         LMHS 4         0           VAV         0126         KRUEGER         LMHS 4         275           VAV         0201         KRUEGER         LMHS 12         230           VAV         0202         KRUEGER         LMHS 12         230           VAV         0203         KRUEGER         LMHS 4         0           VAV         0204         KRUEGER         LMHS 4         0           VAV         0205         KRUEGER         LMHS 4         0           VAV         0206         KRUEGER         LMHS 4         0           VAV         0209         KRUEGER	175	125	0.75 in-wg	4"	0	0	180/140
VAV         0119         KRUEGER         LMHS 4         0           VAV         0120         KRUEGER         LMHS 4         0           VAV         0121         KRUEGER         LMHS 4         0           VAV         0122         KRUEGER         LMHS 4         0           VAV         0123         KRUEGER         LMHS 8         230           VAV         0124         KRUEGER         LMHS 8         230           VAV         0125         KRUEGER         LMHS 12         2330           VAV         0126         KRUEGER         LMHS 12         230           VAV         0126         KRUEGER         LMHS 12         230           VAV         0201         KRUEGER         LMHS 12         230           VAV         0202         KRUEGER         LMHS 12         230           VAV         0203         KRUEGER         LMHS 4         0           VAV         0204         KRUEGER         LMHS 4         0           VAV         0206         KRUEGER         LMHS 4         0           VAV         0208         KRUEGER         LMHS 4         0           VAV         0210         KRUEGER <td>10</td> <td>125</td> <td>1.00 in-wg</td> <td>8"</td> <td>1</td> <td>1</td> <td>1</td>	10	125	1.00 in-wg	8"	1	1	1
VAV         0120         KRUEGER         LMHS 4         0           VAV         0121         KRUEGER         LMHS 4         0           VAV         0122         KRUEGER         LMHS 4         0           VAV         0123         KRUEGER         LMHS 8         230           VAV         0123         KRUEGER         LMHS 8         230           VAV         0125         KRUEGER         LMHS 12         230           VAV         0126         KRUEGER         LMHS 12         230           VAV         0126         KRUEGER         LMHS 4         275           VAV         0201         KRUEGER         LMHS 12         230           VAV         0202         KRUEGER         LMHS 12         230           VAV         0203         KRUEGER         LMHS 4         0           VAV         0204         KRUEGER         LMHS 4         0           VAV         0205         KRUEGER         LMHS 4         0           VAV         0206         KRUEGER         LMHS 4         0           VAV         0209         KRUEGER         LMHS 4         0           VAV         0210         KRUEGER	175	125	0.75 in-wg	4"	0	0	180/140
VAV         0122         KRUEGER         LMHS 4         0           VAV         0123         KRUEGER         LMHS 8         230           VAV         0124         KRUEGER         LMHS 8         230           VAV         0125         KRUEGER         LMHS 8         230           VAV         0126         KRUEGER         LMHS 12         230           VAV         0126         KRUEGER         LMHS 12         230           VAV         0201         KRUEGER         LMHS 12         230           VAV         0202         KRUEGER         LMHS 12         230           VAV         0203         KRUEGER         LMHS 4         0           VAV         0204         KRUEGER         LMHS 4         0           VAV         0205         KRUEGER         LMHS 4         0           VAV         0206         KRUEGER         LMHS 4         0           VAV         0208         KRUEGER         LMHS 4         0           VAV         0209         KRUEGER         LMHS 8         230           VAV         0210         KRUEGER         LMHS 8         230           VAV         0211         KRUEGER<	175	125	0.75 in-wg	4"	0	0	180/140
VAV         0123         KRUEGER         LMHS 8         230           VAV         0124         KRUEGER         LMHS 8         230           VAV         0125         KRUEGER         LMHS 12         230           VAV         0126         KRUEGER         LMHS 12         230           VAV         0126         KRUEGER         LMHS 12         230           VAV         0201         KRUEGER         LMHS 12         230           VAV         0202         KRUEGER         LMHS 12         230           VAV         0203         KRUEGER         LMHS 12         230           VAV         0204         KRUEGER         LMHS 4         0           VAV         0205         KRUEGER         LMHS 4         0           VAV         0206         KRUEGER         LMHS 4         0           VAV         0207         KRUEGER         LMHS 4         0           VAV         0208         KRUEGER         LMHS 4         0           VAV         0210         KRUEGER         LMHS 8         230           VAV         0210         KRUEGER         LMHS 8         230           VAV         0211         KRUE	175	125	0.75 in-wg	4"	0	0	180/140
VAV         0124         KRUEGER         LMHS 8         230           VAV         0125         KRUEGER         LMHS 12         230           VAV         0126         KRUEGER         LMHS 12         230           VAV         0201         KRUEGER         LMHS 12         230           VAV         0202         KRUEGER         LMHS 12         230           VAV         0203         KRUEGER         LMHS 12         230           VAV         0204         KRUEGER         LMHS 4         0           VAV         0205         KRUEGER         LMHS 4         0           VAV         0206         KRUEGER         LMHS 4         0           VAV         0207         KRUEGER         LMHS 4         0           VAV         0208         KRUEGER         LMHS 4         0           VAV         0209         KRUEGER         LMHS 8         230           VAV         0210         KRUEGER         LMHS 8         230           VAV         0211         KRUEGER         LMHS 8         230           VAV         0212         KRUEGER         LMHS 4         0           VAV         0215         KRUEGER	175	125	0.75 in-wg	4"	0	0	180/140
VAV         0125         KRUEGER         LMHS 12         230           VAV         0126         KRUEGER         LMHS 4         275           VAV         0201         KRUEGER         LMHS 12         230           VAV         0202         KRUEGER         LMHS 12         230           VAV         0203         KRUEGER         LMHS 12         230           VAV         0204         KRUEGER         LMHS 12         230           VAV         0205         KRUEGER         LMHS 4         0           VAV         0206         KRUEGER         LMHS 4         0           VAV         0207         KRUEGER         LMHS 4         0           VAV         0208         KRUEGER         LMHS 4         0           VAV         0209         KRUEGER         LMHS 4         0           VAV         0210         KRUEGER         LMHS 8         230           VAV         0211         KRUEGER         LMHS 8         230           VAV         0214         KRUEGER         LMHS 4         0           VAV         0215         KRUEGER         LMHS 4         0           VAV         0218         KRUEGER </td <td>10</td> <td>125</td> <td>1.00 in-wg</td> <td>8"</td> <td>1</td> <td>1</td> <td>1</td>	10	125	1.00 in-wg	8"	1	1	1
VAV         0126         KRUEGER         LMHS 4         275           VAV         0201         KRUEGER         LMHS 12         230           VAV         0202         KRUEGER         LMHS 12         230           VAV         0203         KRUEGER         LMHS 12         230           VAV         0204         KRUEGER         LMHS 12         230           VAV         0204         KRUEGER         LMHS 4         0           VAV         0205         KRUEGER         LMHS 4         0           VAV         0206         KRUEGER         LMHS 4         0           VAV         0207         KRUEGER         LMHS 4         0           VAV         0208         KRUEGER         LMHS 4         0           VAV         0209         KRUEGER         LMHS 8         230           VAV         0210         KRUEGER         LMHS 8         230           VAV         0211         KRUEGER         LMHS 8         230           VAV         0214         KRUEGER         LMHS 4         0           VAV         0215         KRUEGER         LMHS 4         0           VAV         0218         KRUEGER <td>10</td> <td>125</td> <td>1.00 in-wg</td> <td>8"</td> <td>1</td> <td>1</td> <td>1</td>	10	125	1.00 in-wg	8"	1	1	1
VAV         0201         KRUEGER         LMHS 12         230           VAV         0202         KRUEGER         LMHS 12         230           VAV         0203         KRUEGER         LMHS 12         230           VAV         0204         KRUEGER         LMHS 12         230           VAV         0204         KRUEGER         LMHS 4         0           VAV         0205         KRUEGER         LMHS 4         0           VAV         0206         KRUEGER         LMHS 4         0           VAV         0207         KRUEGER         LMHS 4         0           VAV         0208         KRUEGER         LMHS 4         0           VAV         0209         KRUEGER         LMHS 8         230           VAV         0210         KRUEGER         LMHS 8         230           VAV         0211         KRUEGER         LMHS 8         230           VAV         0212         KRUEGER         LMHS 4         0           VAV         0214         KRUEGER         LMHS 4         0           VAV         0218         KRUEGER         LMHS 4         0           VAV         0219         KRUEGER	10	125	1.00 in-wg	12"	1	1	1
VAV         0202         KRUEGER         LMHS 12         230           VAV         0203         KRUEGER         LMHS 12         230           VAV         0204         KRUEGER         LMHS 12         230           VAV         0204         KRUEGER         LMHS 4         0           VAV         0205         KRUEGER         LMHS 4         0           VAV         0206         KRUEGER         LMHS 4         0           VAV         0207         KRUEGER         LMHS 4         0           VAV         0208         KRUEGER         LMHS 4         0           VAV         0209         KRUEGER         LMHS 4         0           VAV         0210         KRUEGER         LMHS 8         230           VAV         0211         KRUEGER         LMHS 8         230           VAV         0212         KRUEGER         LMHS 8         230           VAV         0214         KRUEGER         LMHS 4         0           VAV         0216         KRUEGER         LMHS 4         0           VAV         0218         KRUEGER         LMHS 4         0           VAV         0219         KRUEGER	175	125	0.75 in-wg	4"	0	0	180/140
VAV         0203         KRUEGER         LMHS 12         230           VAV         0204         KRUEGER         LMHS 4         0           VAV         0205         KRUEGER         LMHS 4         0           VAV         0206         KRUEGER         LMHS 4         0           VAV         0206         KRUEGER         LMHS 4         0           VAV         0207         KRUEGER         LMHS 4         0           VAV         0208         KRUEGER         LMHS 4         0           VAV         0209         KRUEGER         LMHS 4         0           VAV         0210         KRUEGER         LMHS 8         230           VAV         0211         KRUEGER         LMHS 8         230           VAV         0212         KRUEGER         LMHS 8         230           VAV         0214         KRUEGER         LMHS 8         230           VAV         0215         KRUEGER         LMHS 4         0           VAV         0218         KRUEGER         LMHS 4         160           VAV         0219         KRUEGER         LMHS 4         0           VAV         0219         KRUEGER	10	125	1.00 in-wg	12"	1	1	1
VAV         0204         KRUEGER         LMHS 4         0           VAV         0205         KRUEGER         LMHS 4         0           VAV         0206         KRUEGER         LMHS 4         0           VAV         0207         KRUEGER         LMHS 4         0           VAV         0208         KRUEGER         LMHS 4         0           VAV         0209         KRUEGER         LMHS 4         0           VAV         0210         KRUEGER         LMHS 8         230           VAV         0211         KRUEGER         LMHS 8         230           VAV         0212         KRUEGER         LMHS 8         230           VAV         0212         KRUEGER         LMHS 8         230           VAV         0214         KRUEGER         LMHS 4         0           VAV         0215         KRUEGER         LMHS 4         0           VAV         0216         KRUEGER         LMHS 4         160           VAV         0219         KRUEGER         LMHS 12         230           VAV         0219         KRUEGER         LMHS 4         0           VAV         0301         TUTTLE & BAILEY </td <td>10</td> <td>125</td> <td>1.00 in-wg</td> <td>12"</td> <td>1</td> <td>1</td> <td>1</td>	10	125	1.00 in-wg	12"	1	1	1
VAV         0205         KRUEGER         LMHS 4         0           VAV         0206         KRUEGER         LMHS 4         0           VAV         0207         KRUEGER         LMHS 4         0           VAV         0208         KRUEGER         LMHS 4         0           VAV         0209         KRUEGER         LMHS 4         0           VAV         0209         KRUEGER         LMHS 12         230           VAV         0210         KRUEGER         LMHS 8         230           VAV         0211         KRUEGER         LMHS 8         230           VAV         0212         KRUEGER         LMHS 8         230           VAV         0214         KRUEGER         LMHS 4         0           VAV         0215         KRUEGER         LMHS 4         0           VAV         0216         KRUEGER         LMHS 4         160           VAV         0219         KRUEGER         LMHS 4         0           VAV         0219         KRUEGER         LMHS 4         0           VAV         0219         KRUEGER         LMHS 4         0           VAV         0301         TUTTLE & BAILEY <td><u> </u></td> <td>125 125</td> <td>1.00 in-wg 0.75 in-wg</td> <td>12" 4"</td> <td>1 0</td> <td>1</td> <td>1 180/140</td>	<u> </u>	125 125	1.00 in-wg 0.75 in-wg	12" 4"	1 0	1	1 180/140
VAV         0206         KRUEGER         LMHS 4         0           VAV         0207         KRUEGER         LMHS 4         0           VAV         0208         KRUEGER         LMHS 4         0           VAV         0209         KRUEGER         LMHS 12         230           VAV         0210         KRUEGER         LMHS 8         230           VAV         0211         KRUEGER         LMHS 8         230           VAV         0212         KRUEGER         LMHS 8         230           VAV         0212         KRUEGER         LMHS 8         230           VAV         0214         KRUEGER         LMHS 8         230           VAV         0215         KRUEGER         LMHS 4         0           VAV         0216         KRUEGER         LMHS 4         160           VAV         0218         KRUEGER         LMHS 12         230           VAV         0219         KRUEGER         LMHS 4         0           VAV         0219         KRUEGER         LMHS 4         0           VAV         0301         TUTTLE & BAILEY         SDV         0           VAV         0303         KRUEGER	175	125	0.75 in-wg	4"	0	0	180/140
VAV         0207         KRUEGER         LMHS 4         0           VAV         0208         KRUEGER         LMHS 4         0           VAV         0209         KRUEGER         LMHS 12         230           VAV         0210         KRUEGER         LMHS 8         230           VAV         0211         KRUEGER         LMHS 8         230           VAV         0212         KRUEGER         LMHS 8         230           VAV         0214         KRUEGER         LMHS 8         230           VAV         0214         KRUEGER         LMHS 4         0           VAV         0215         KRUEGER         LMHS 4         0           VAV         0216         KRUEGER         LMHS 4         160           VAV         0218         KRUEGER         LMHS 4         160           VAV         0219         KRUEGER         LMHS 12         230           VAV         0219         KRUEGER         LMHS 4         0           VAV         0301         TUTTLE & BAILEY         SDV         0           VAV         0302         TUTTLE & BAILEY         SDV         0           VAV         0304         KR	175	125	0.75 in-wg	4"	0	0	180/140
VAV         0208         KRUEGER         LMHS 4         0           VAV         0209         KRUEGER         LMHS 12         230           VAV         0210         KRUEGER         LMHS 8         230           VAV         0211         KRUEGER         LMHS 8         230           VAV         0211         KRUEGER         LMHS 8         230           VAV         0212         KRUEGER         LMHS 8         230           VAV         0214         KRUEGER         LMHS 4         0           VAV         0215         KRUEGER         LMHS 4         0           VAV         0216         KRUEGER         LMHS 4         0           VAV         0218         KRUEGER         LMHS 4         160           VAV         0219         KRUEGER         LMHS 12         230           VAV         0219         KRUEGER         LMHS 4         0           VAV         0211         KRUEGER         LMHS 4         0           VAV         0219         KRUEGER         LMHS 4         0           VAV         0301         TUTTLE & BAILEY         SDV         0           VAV         0303         KRUEGER </td <td>175</td> <td>125</td> <td>0.75 in-wg</td> <td>4"</td> <td>0</td> <td>0</td> <td>180/140</td>	175	125	0.75 in-wg	4"	0	0	180/140
VAV         0209         KRUEGER         LMHS 12         230           VAV         0210         KRUEGER         LMHS 8         230           VAV         0211         KRUEGER         LMHS 8         230           VAV         0212         KRUEGER         LMHS 8         230           VAV         0212         KRUEGER         LMHS 8         230           VAV         0212         KRUEGER         LMHS 4         0           VAV         0214         KRUEGER         LMHS 4         0           VAV         0215         KRUEGER         LMHS 4         0           VAV         0216         KRUEGER         LMHS 4         0           VAV         0218         KRUEGER         LMHS 4         160           VAV         0219         KRUEGER         LMHS 12         230           VAV         0219         KRUEGER         LMHS 4         0           VAV         0211         KRUEGER         LMHS 4         0           VAV         0219         KRUEGER         LMHS 4         0           VAV         0301         TUTTLE & BAILEY         SDV         0           VAV         0303         KRUEGER </td <td>175</td> <td>125</td> <td>0.75 in-wg</td> <td>4"</td> <td>0</td> <td>0</td> <td>180/140</td>	175	125	0.75 in-wg	4"	0	0	180/140
VAV         0210         KRUEGER         LMHS 8         230           VAV         0211         KRUEGER         LMHS 8         230           VAV         0212         KRUEGER         LMHS 8         230           VAV         0212         KRUEGER         LMHS 8         230           VAV         0214         KRUEGER         LMHS 4         0           VAV         0215         KRUEGER         LMHS 4         0           VAV         0216         KRUEGER         LMHS 4         0           VAV         0218         KRUEGER         LMHS 4         160           VAV         0219         KRUEGER         LMHS 4         160           VAV         0219         KRUEGER         LMHS 12         230           VAV         0219         KRUEGER         LMHS 4         0           VAV         0221         KRUEGER         LMHS 4         0           VAV         0301         TUTTLE & BAILEY         SDV         0           VAV         0302         TUTTLE & BAILEY         SDV         0           VAV         0304         KRUEGER         LMHS 8         230           VAV         0305         TUT	10	125	1.00 in-wg	12"	1	1	1
VAV         0212         KRUEGER         LMHS 8         230           VAV         0214         KRUEGER         LMHS 4         0           VAV         0215         KRUEGER         LMHS 4         0           VAV         0216         KRUEGER         LMHS 4         0           VAV         0216         KRUEGER         LMHS 4         0           VAV         0218         KRUEGER         LMHS 4         160           VAV         0219         KRUEGER         LMHS 12         230           VAV         0219         KRUEGER         LMHS 12         230           VAV         0219         KRUEGER         LMHS 4         0           VAV         0221         KRUEGER         LMHS 4         0           VAV         0301         TUTTLE & BAILEY         SDV         0           VAV         0302         TUTTLE & BAILEY         SDV         0           VAV         0303         KRUEGER         LMHS 8         230           VAV         0304         KRUEGER         LMHS 8         230           VAV         0305         TUTTLE & BAILEY         SDV         0           VAV         0306         T	10	125	1.00 in-wg	8"	1	1	1
VAV         0214         KRUEGER         LMHS 4         0           VAV         0215         KRUEGER         LMHS 4         0           VAV         0216         KRUEGER         LMHS 4         0           VAV         0216         KRUEGER         LMHS 8         230           VAV         0218         KRUEGER         LMHS 4         160           VAV         0219         KRUEGER         LMHS 12         230           VAV         0219         KRUEGER         LMHS 12         230           VAV         0219         KRUEGER         LMHS 4         0           VAV         0221         KRUEGER         LMHS 4         0           VAV         0221         KRUEGER         LMHS 4         0           VAV         0301         TUTTLE & BAILEY         SDV         0           VAV         0302         TUTTLE & BAILEY         SDV         0           VAV         0303         KRUEGER         LMHS 8         230           VAV         0304         KRUEGER         LMHS 8         230           VAV         0305         TUTTLE & BAILEY         SDV         0           VAV         0306         T	10	125	1.00 in-wg	8"	1	1	1
VAV         0215         KRUEGER         LMHS 4         0           VAV         0216         KRUEGER         LMHS 8         230           VAV         0218         KRUEGER         LMHS 4         160           VAV         0219         KRUEGER         LMHS 12         230           VAV         0221         KRUEGER         LMHS 4         0           VAV         0301         TUTTLE & BAILEY         SDV         0           VAV         0302         TUTTLE & BAILEY         SDV         0           VAV         0303         KRUEGER         LMHS 8         230           VAV         0304         KRUEGER         LMHS 8         230           VAV         0305         TUTTLE & BAILEY         SDV         0           VAV         0306         TUTTLE & BAILEY         SDV         0	10	125	1.00 in-wg	8"	1	1	1
VAV         0216         KRUEGER         LMHS 8         230           VAV         0218         KRUEGER         LMHS 4         160           VAV         0219         KRUEGER         LMHS 12         230           VAV         0219         KRUEGER         LMHS 12         230           VAV         0219         KRUEGER         LMHS 12         230           VAV         0221         KRUEGER         LMHS 12         230           VAV         0221         KRUEGER         LMHS 4         0           VAV         0301         TUTTLE & BAILEY         SDV         0           VAV         0302         TUTTLE & BAILEY         SDV         0           VAV         0303         KRUEGER         LMHS 8         230           VAV         0304         KRUEGER         LMHS 8         230           VAV         0305         TUTTLE & BAILEY         SDV         0           VAV         0306         TUTTLE & BAILEY         SDV         0	175	125	0.75 in-wg	4"	0	0	180/140
VAV         0218         KRUEGER         LMHS 4         160           VAV         0219         KRUEGER         LMHS 12         230           VAV         0221         KRUEGER         LMHS 4         0           VAV         0301         TUTTLE & BAILEY         SDV         0           VAV         0302         TUTTLE & BAILEY         SDV         0           VAV         0303         KRUEGER         LMHS 8         230           VAV         0304         KRUEGER         LMHS 8         230           VAV         0305         TUTTLE & BAILEY         SDV         0           VAV         0306         TUTTLE & BAILEY         SDV         0	175	125	0.75 in-wg	4"	0	0	180/140
VAV         0219         KRUEGER         LMHS 12         230           VAV         0219         KRUEGER         LMHS 12         230           VAV         0221         KRUEGER         LMHS 12         230           VAV         0221         KRUEGER         LMHS 4         0           VAV         0301         TUTTLE & BAILEY         SDV         0           VAV         0302         TUTTLE & BAILEY         SDV         0           VAV         0303         KRUEGER         LMHS 8         230           VAV         0304         KRUEGER         LMHS 8         230           VAV         0305         TUTTLE & BAILEY         SDV         0           VAV         0306         TUTTLE & BAILEY         SDV         0	10	125	1.00 in-wg	8"	1	1	1
VAV         0219         KRUEGER         LMHS 12         230           VAV         0221         KRUEGER         LMHS 4         0           VAV         0301         TUTTLE & BAILEY         SDV         0           VAV         0302         TUTTLE & BAILEY         SDV         0           VAV         0303         KRUEGER         LMHS 8         230           VAV         0304         KRUEGER         LMHS 8         230           VAV         0305         TUTTLE & BAILEY         SDV         0           VAV         0306         TUTTLE & BAILEY         SDV         0	175	125	0.75 in-wg	4"	0	0	180/140
VAV         0221         KRUEGER         LMHS 4         0           VAV         0301         TUTTLE & BAILEY         SDV         0           VAV         0302         TUTTLE & BAILEY         SDV         0           VAV         0302         TUTTLE & BAILEY         SDV         0           VAV         0303         KRUEGER         LMHS 8         230           VAV         0304         KRUEGER         LMHS 8         230           VAV         0305         TUTTLE & BAILEY         SDV         0           VAV         0306         TUTTLE & BAILEY         SDV         0	10	125	1.00 in-wg	12"	1	1	1
VAV         0301         TUTTLE & BAILEY         SDV         0           VAV         0302         TUTTLE & BAILEY         SDV         0           VAV         0303         TUTTLE & BAILEY         SDV         0           VAV         0303         KRUEGER         LMHS 8         230           VAV         0304         KRUEGER         LMHS 8         230           VAV         0305         TUTTLE & BAILEY         SDV         0           VAV         0306         TUTTLE & BAILEY         SDV         0	10 175	125 125	1.00 in-wg 0.75 in-wg	12" 4"	1 0	1 0	180/140
VAV         0302         TUTTLE & BAILEY         SDV         0           VAV         0303         KRUEGER         LMHS 8         230           VAV         0304         KRUEGER         LMHS 8         230           VAV         0305         TUTTLE & BAILEY         SDV         0           VAV         0306         TUTTLE & BAILEY         SDV         0	175	125	0.75 in-wg	8"	0	0	180/140
VAV         0303         KRUEGER         LMHS 8         230           VAV         0304         KRUEGER         LMHS 8         230           VAV         0305         TUTTLE & BAILEY         SDV         0           VAV         0306         TUTTLE & BAILEY         SDV         0	175		0.75 in-wg	8"	0	0	180/140
VAV         0304         KRUEGER         LMHS 8         230           VAV         0305         TUTTLE & BAILEY         SDV         0           VAV         0306         TUTTLE & BAILEY         SDV         0	10	125	1.00 in-wg	8"	1	1	1
VAV         0305         TUTTLE & BAILEY         SDV         0           VAV         0306         TUTTLE & BAILEY         SDV         0	10	125	1.00 in-wg	8"	1	1	1
VAV 0306 TUTTLE & BAILEY SDV 0	175		0.75 in-wg	8"	0	0	180/140
VAV 0307 TUTTLE & BAILEY SDV 0	175		0.75 in-wg	8"	0	0	180/140
	175		0.75 in-wg	8"	0	0	180/140
VAV 0308 TUTTLE & BAILEY SDV 0	175		0.75 in-wg	8"	0	0	180/140
VAV 0309 TUTTLE & BAILEY SDV 0	175		0.75 in-wg	8"	0	0	180/140
VAV         E01         KRUEGER         KQFS 5         2100	0		0.75 in-wg	12"	1	0	180/140
VAV E02 KRUEGER KQFS 5 2800	0		0.75 in-wg	13"	1	0	180/140
VAV         E03         KRUEGER         KQFS 3         1450           VAV         E04         KEUEGER         KQFS 3         1450	0	_	0.75 in-wg	10"	1	0	180/140
VAV         E04         KRUEGER         KQFS 3         1450           VAV         E05         KRUEGER         KQFS 3         1450	0		0.75 in-wg 0.75 in-wg	10" 10"	1	0	180/140 180/140

### COMMENTS:

CAPACITY BASED ON 30% PROPYLENE GLYCOL. 1

CAPACITY BASED ON 55 DEG. EAT. 2

PROVIDE WITH DISCONNECT SWITCH. 3

4 FAN SHALL HAVE SCR SPEED CONTROL.

	FAN SCHEDULE											
UNIT TYPE	UNIT NUMBER	MANUFACTURER	MODEL	LOCATION	SERVICE	VIBRATION ISOLATION	CFM	S.P.D.	VOLTAGE	HP	SONES	РНА
SF	1	LOREN COOK COMPANY	300PLCD17		SUPPLY		20000	4.00 in-wg	0	20	0	(
SF	2	LOREN COOK COMPANY	300PLCD17		SUPPLY		20000	4.00 in-wg	0	20	0	

COMMENTS:

1 PROVIDE WITH STANDARD PREWIRED DISCONNECT.

PROVIDE WITH THERMAL OVERLOAD. 2

PROVIDE WITH MOTORIZED DAMPER. 3

4 PROVIDE WITH RUBBER ISOLATORS. PROVIDE WITH ROOF CURB. 5

PROVIDE WITH ANODIZED ALUMINUM OR PLASTIC GRILLE. 6


PROVIDE WITH WALL CAP, ROOF CAP, EAVE VENT WITH BACK DRAFT DAMPER. 7

INLINE FAN WITH STANDARD PLUG DISCONNECT, ALUMINUM WALL CAP. 8

PROVIDE WITH STD DISCONNECT NEMA 3, VENTED ROOF CURB, GREASE TERMINATOR. FAN TO BE UL 762 RATED FOR GREASE EXHAUST. 9


PROVIDE VARIABLE SPEED SWITCH. 10

AM S. 20	FOULING FACTOR 0		CAPACI 0	TY % GLYC 0		<u>-</u>	COArchOP1108 S. Main St. 102Aberdeen, SD 57401Phone: 605-725-4852601 Kansas City St. 7Rapid City, SD 57701
REHEA LWT	LE AT SECTIO ROWS	<b>WPD</b> 2.307	<b>APD</b> 1.00 in-wg	% GLYCOL	1	COMMENTS	300 N. Phillips Ave. 120 Sioux Falls, SD 57104 Phone: 605-334-9999
1 1 /140 /140 /140	4 4 4 4 4 4	2.307 · 0 ( 0 ( 0 ( 0 (	1.00 in-wg 1.00 in-wg 0.00 in-wg 0.00 in-wg 0.00 in-wg	1 1 1 1 1	1 20 20 20		co-oparch.com
/140 /140 /140 /140 /140 /140	4 4 4 4 4 4 4 4 4	0 ( 0 ( 0 ( 0 ( 0 ( 0 (	0.00 in-wg 0.00 in-wg 0.00 in-wg 0.00 in-wg 0.00 in-wg 0.00 in-wg 1.00 in-wg	1 1 1 1 1 1 1 1	20 20 20 20 20 20 20 1		STRANG DESIGN SYNCHRONICITY
/140 /140 /140 /140 1 /140	4       4       4       4       4       4       4       4	0 ( 0 ( 0 ( 0 ( 2.307 - 0 (	0.00 in-wg 0.00 in-wg 0.00 in-wg 0.00 in-wg 1.00 in-wg 0.00 in-wg	1 1 1 1 1 1 1	20 20 20 20 1 20		811 East Washington Ave. 200 Madison, WI 53703 Phone: 608-276-9200
/140 /140 /140 1 1 1	4 4 4 4 4 4	0 ( 0 ( 2.307 / 2.307 /	0.00 in-wg 0.00 in-wg 0.00 in-wg 1.00 in-wg 1.00 in-wg 1.00 in-wg	1 1 1 1 1	20 20 20 1 1		W238N1610 Busse Rd. 102 Waukesha, WI 53188 Phone: 262-875-6760 strang-inc.com
/140 1 1 1 /140	4 4 4 4 4 4 4	0 ( 2.307 · 2.307 · 2.307 · 0 (	0.00 in-wg 1.00 in-wg 1.00 in-wg 1.00 in-wg 0.00 in-wg	1 1 1 1 1 1 1	1 20 1 1 1 20 20		WPE# BR19035 WEST PLAINS ENGINEERING. INC. 1750 RAND ROAD • RAPID CITY SD, 57702 PHONE: (605) 348-7455 • FAX: (605) 348-9445
/140 /140 /140 /140 1 1	4       4       4       4       4       4       4       4	0 ( 0 ( 2.307 · 2.307 ·	0.00 in-wg 0.00 in-wg 0.00 in-wg 0.00 in-wg 1.00 in-wg	1 1 1 1 1 1 1	20 20 20 20 1 1		CO-OP PROJECT NO: 1936
1 1 /140 /140 1 /140 1	4 4 4 4 4 4 4 4 4	2.307 ( 0 ( 0 ( 2.307 ( 0 (	1.00 in-wg 1.00 in-wg 0.00 in-wg 0.00 in-wg 1.00 in-wg 1.00 in-wg	1 1 1 1 1 1 1 1	1 20 20 1 20 1 20 1		PRELIMINARY NOT FOR
1 /140 /140 /140 1 1	4 4 1 1 4 4 4	2.307 ( 0 ( 0 ( 0 ( 2.307 (	1.00 in-wg 0.00 in-wg 0.00 in-wg 0.00 in-wg 1.00 in-wg 1.00 in-wg	1 1 1 1 1	1 20 20 20 1 1		CONSTRUCTION
/140 /140 /140 /140 /140 /140	1 1 1 1 1 1 1 1	0 ( 0 ( 0 ( 0 ( 0 ( 0 (	0.00 in-wg 0.00 in-wg 0.00 in-wg 0.00 in-wg 0.00 in-wg 0.00 in-wg	0	20 20 20 20 20 20 -		ISSUE: Issue Date Project Status
/140 /140 /140 /140	1 1 1 1	0.339 ( 0.339 ( 0.339 (	).35 in-wg ).35 in-wg ).35 in-wg ).35 in-wg	0 0 0	- - -		REVISION SCHEDULE: REV. # REV. DSC. REV. DATE
РН	<b>ASES</b> 0 0	COMMENTS					PROJECT: SDSMT DEVEREAUX LIBRARY PHASE 1 SOUTH DAKOTA SCHOOL OF MINES AND TECHNOLOGY RAPID CITY, SOUTH DAKOTA
							<u>SHEET TITLE:</u> MECHANICAL SCHEDULES
							M6-0

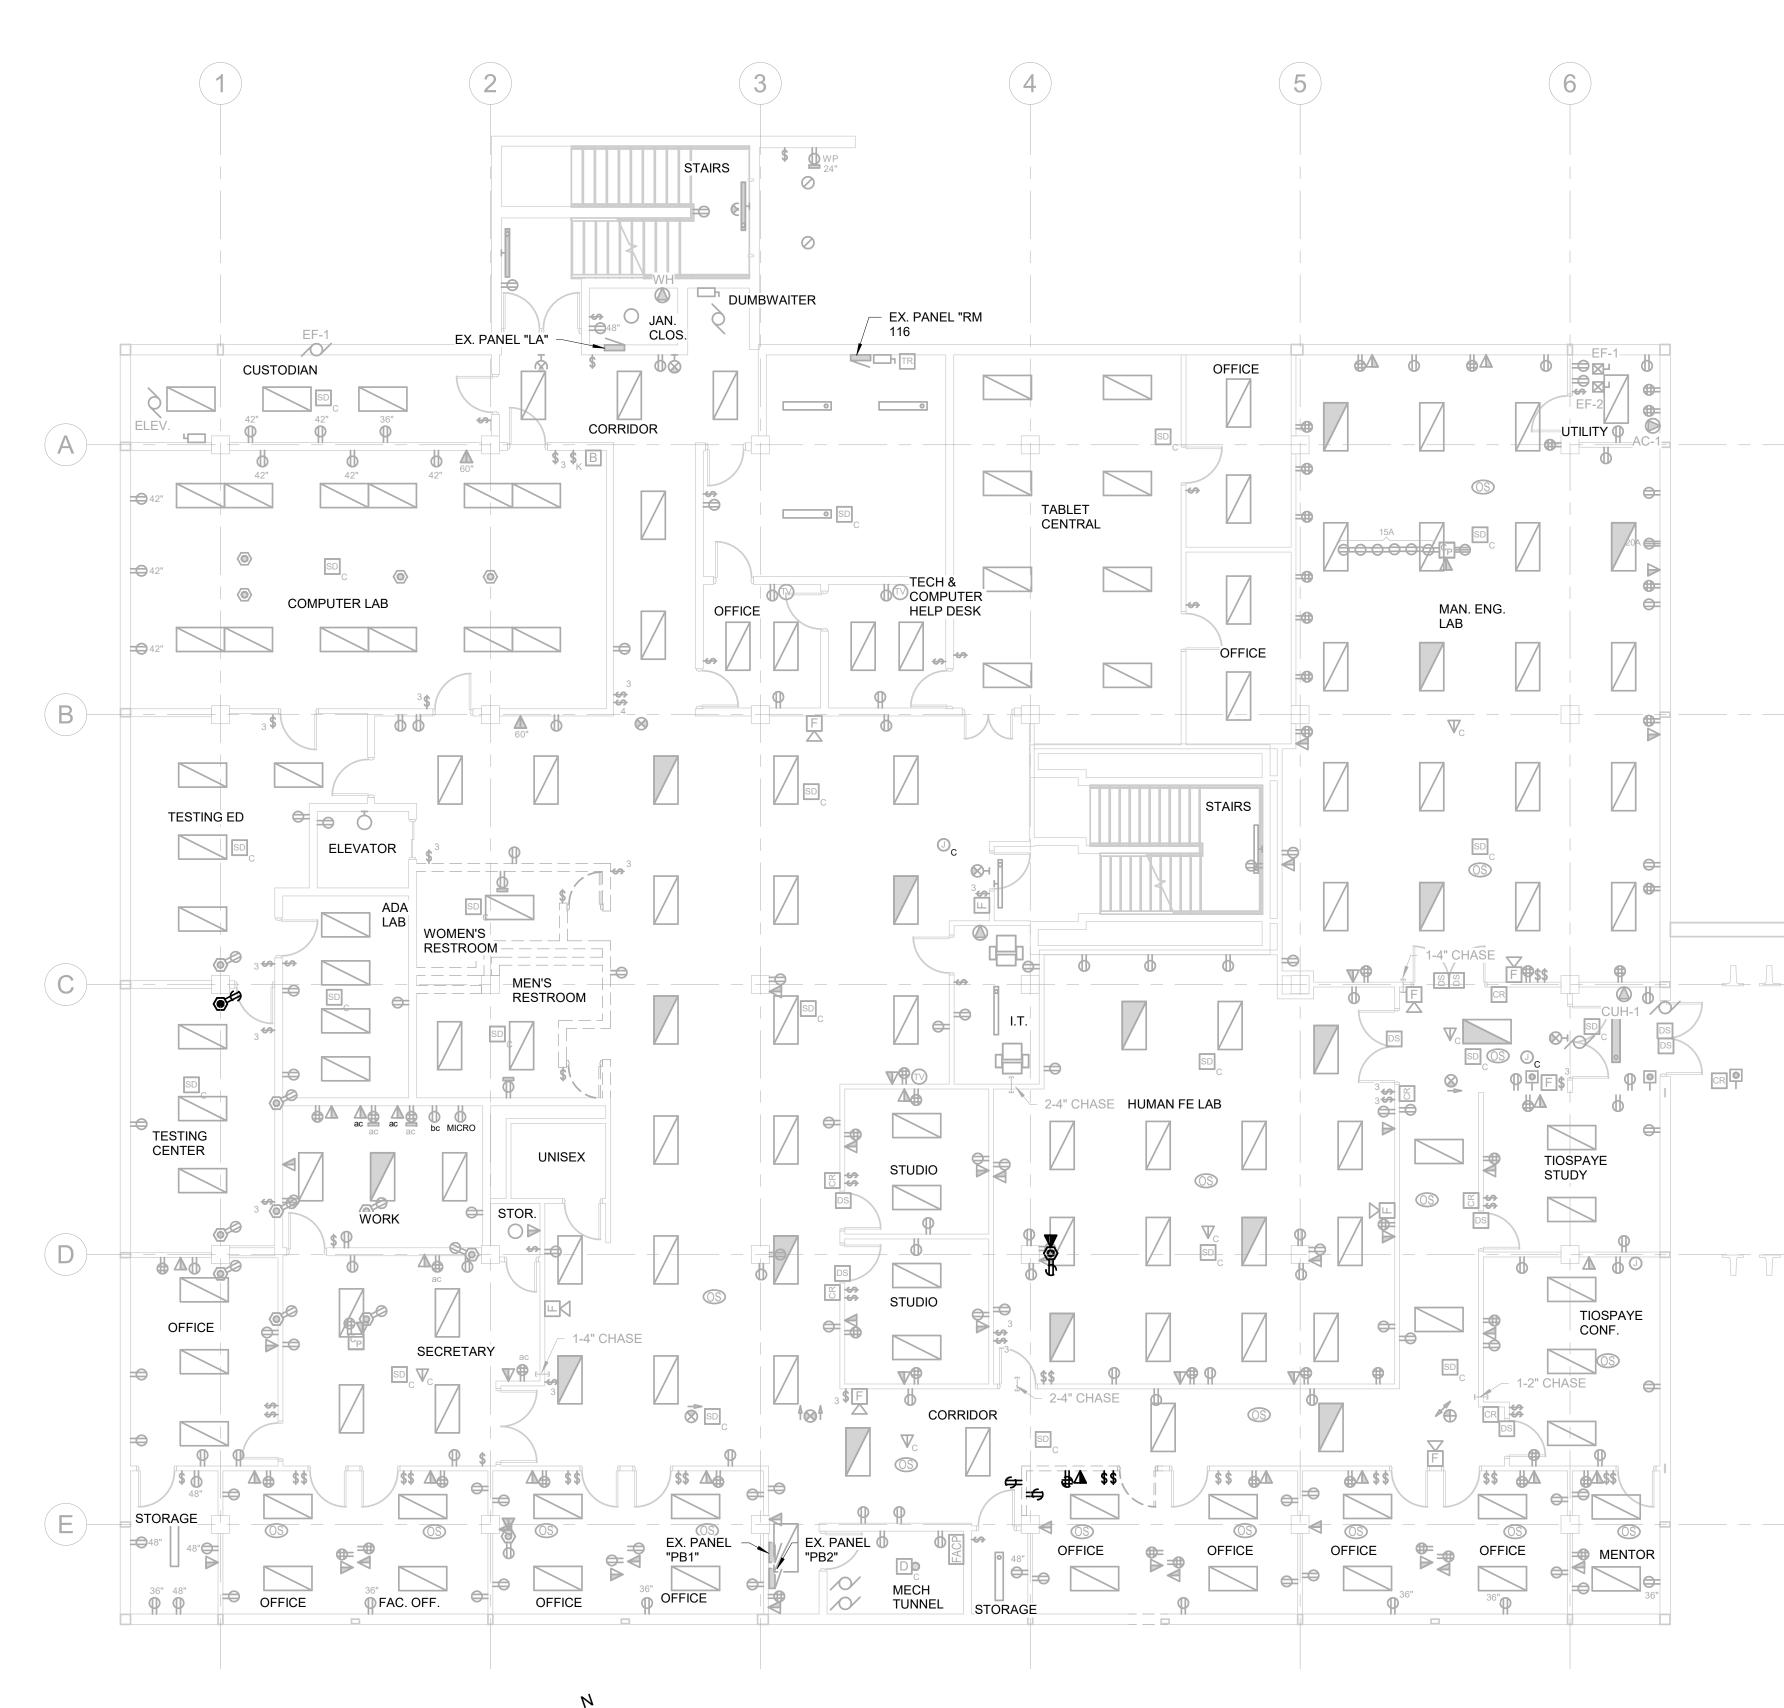

LOWER LEVEL ELECTRICAL DEMOLITION PLAN


	СО
	Arch <b>OP</b>
	1108 S. Main St. 102
	Aberdeen, SD 57401 Phone: 605-725-4852 601 Kansas City St. 7
ELECTRICAL MISCELLANEOUS NOTES	Rapid City, SD 57701 Phone: 605-716-3652 300 N. Phillips Ave. 120
B C D	Sioux Falls, SD 57104 Phone: 605-334-9999 co-oparch.com
# ELECTRICAL SPECIFIC NOTES	
	DESIGN SYNCHRONICITY
	811 East Washington Ave. 200 Madison, WI 53703 Phone: 608-276-9200
	W238N1610 Busse Rd. 102 Waukesha, WI 53188 Phone: 262-875-6760 strang-inc.com
	WPE# BR19035 WEST PLAINS PLAINS PLAINS PLAINS ITSO RAND ROAD • RAPID CITY SD, 57702 PHONE: (605) 348-7455 • FAX: (605) 348-9445 WWW.WESTPLAINSENGINEERING.COM RAPID CITY, SD • SIDUX FALLS, SD • CASPER, WY • CEDAR RAPIDS, IA • BISMARCK, ND
	CO-OP PROJECT NO: 1936
	PRELIMINARY NOT FOR CONSTRUCTION
	ISSUE: Issue Date Project Status REVISION SCHEDULE:
	REV. # REV. DSC. REV. DATE
	PROJECT: SDSMT DEVEREAUX LIBRARY PHASE 1 SOUTH DAKOTA SCHOOL OF MINES AND TECHNOLOGY RAPID CITY, SOUTH DAKOTA
	SHEET TITLE: LOWER LEVEL ELECTRICAL DEMOLITION PLAN
	E1-0
	1

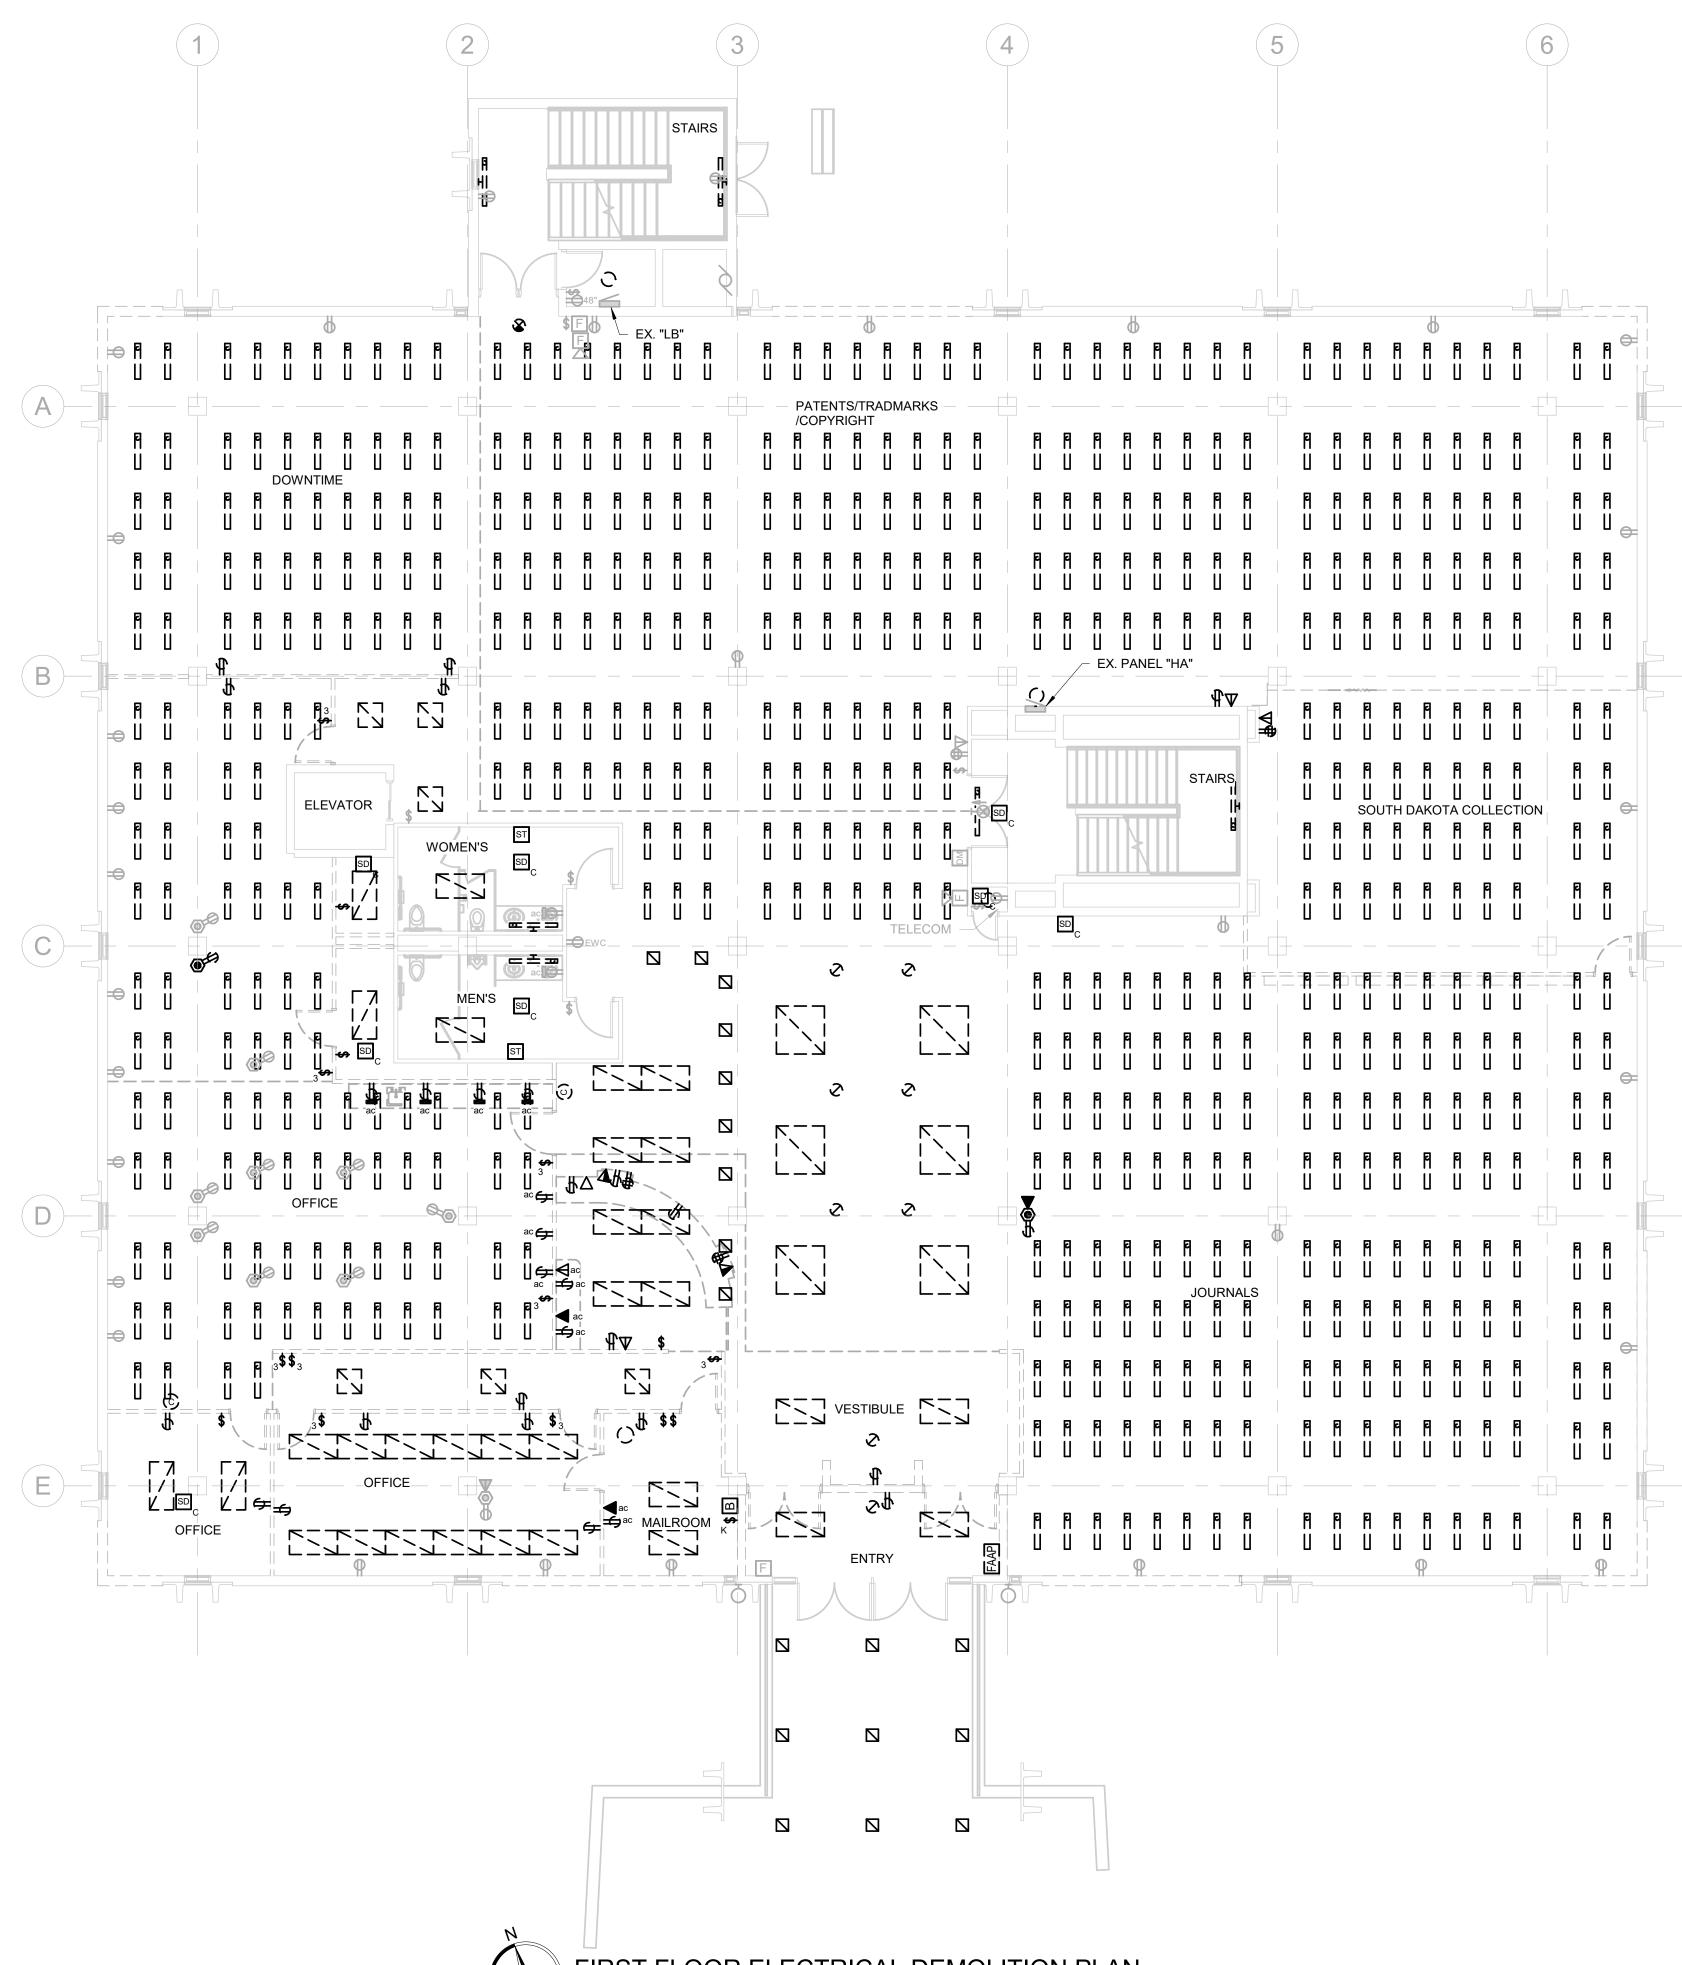



FIRST FLOOR ELECTRICAL DEMOLITION PLAN


	<b>CO</b>
	Arch <b>OP</b>
	1108 S. Main St. 102 Aberdeen, SD 57401 Phone: 605-725-4852
ELECTRICAL MISCELLANEOUS NOTES	601 Kansas City St. 7 Rapid City, SD 57701 Phone: 605-716-3652 300 N. Phillips Ave. 120
A B C D	Sioux Falls, SD 57104 Phone: 605-334-9999 co-oparch.com
#       ELECTRICAL SPECIFIC NOTES	STRANG DESIGN SYNCHRONICITY
	811 East Washington Ave. 200 Madison, WI 53703 Phone: 608-276-9200
	W238N1610 Busse Rd. 102 Waukesha, WI 53188 Phone: 262-875-6760 strang-inc.com
	WPE# BR19035 WEST PLAINS ENGINEERING. INC. 1750 RAND ROAD + RAPID CITY SD, 57702 PHONE: (605) 348-7455 • FAX: (605) 348-9445 WWW.WESTPAINSENGINEERINGCOM RAPID CITY, SD • SIOUX FALLS, SD • CASPER, WY • CEDAR RAPIDS, IA • BISMARCK, ND
	CO-OP PROJECT NO: 1936
	PRELIMINARY NOT FOR CONSTRUCTION
	ISSUE: Issue Date Project Status REVISION SCHEDULE: REV. # REV. DSC. REV. DATE
	PROJECT: SDSMT DEVEREAUX LIBRARY PHASE 1 SOUTH DAKOTA SCHOOL OF MINES AND TECHNOLOGY RAPID CITY, SOUTH DAKOTA
	SHEET TITLE: FIRST FLOOR ELECTRICAL DEMOLITION PLAN
	E1-1
	1

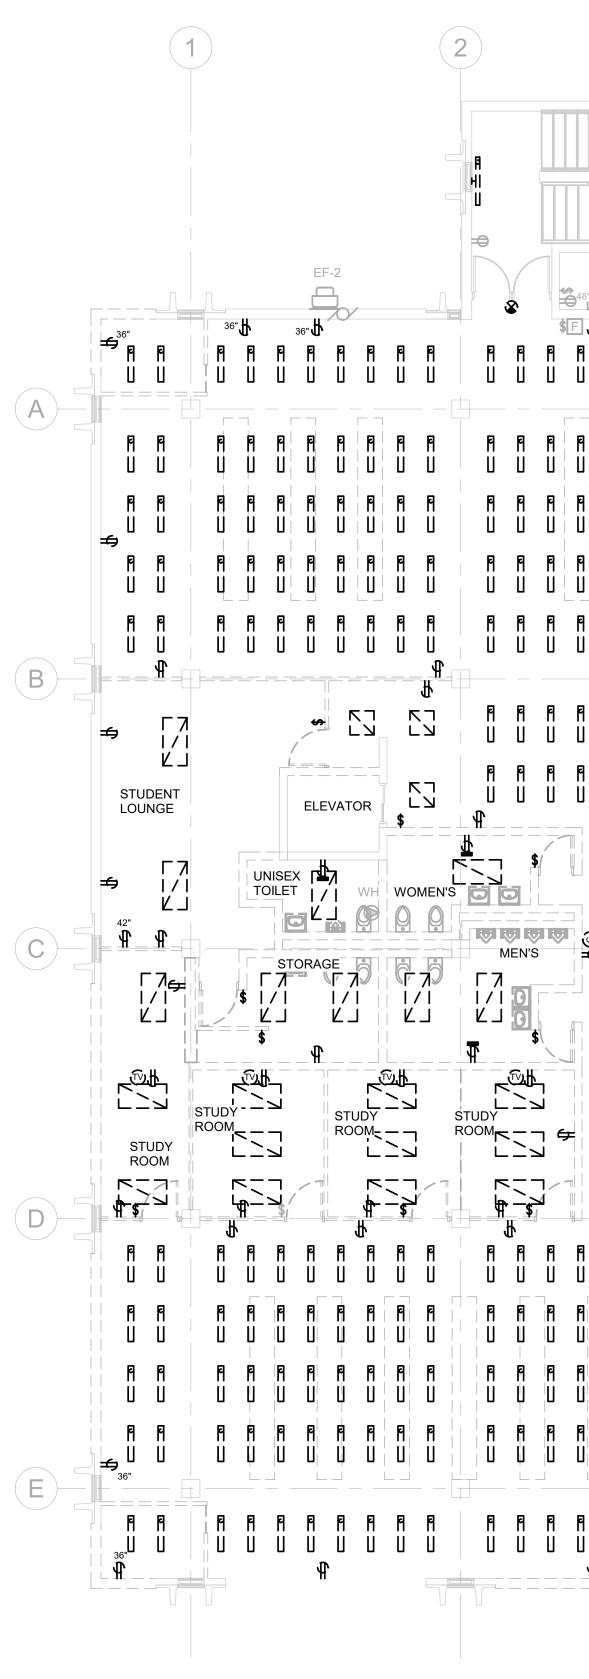


	3							4							5							6											
	ST	AIRS		П Фі	-																												
<b>\$</b> 48		TR		EF-3	2	Л			— —																			1					
\$F    	9	- EX. P U	. "LC" <b>f</b> L	۹ ۱		P 	P 	P 	٦£    	P 	P 	₽ 	P 		9 U	P 	P 	0  9 	)    	P 	P L	P L		P L	P 	P 	ر ۹ ۱	4 9 U	P 	P 	P       	٩ ١	36" ଐ ₽ U
      	   <b> </b>	P   L   P   L	           	P       		<b>9</b>    	6     	<b>P</b>            	9    	9    	<b> </b>     <b> </b>     <b> </b>     <b> </b>     <b> </b>	P    	₽       			P    	<b>P</b>            	P     	■       	9 U 9	9 U 9 U	ମ       		6    	P    	P    		P       	9    	9    	위    	         	[]  9
9       	P	     		9       		9       	9       	<b>P</b>             	P U P U TACKS	<b>P</b> U <b>P</b> U	         	₽    	위 [] [] []	     	₽       	9  ]  ]	<b> </b>       	9 U 9 U	9          7	9       	9       	9       	     	위  ]  ]	    	₽       	₽    	₽       	9       	9    	₽    	9       	L P
	U P U U P U	9 9 0 9 0	9 1 9 1 1 9 1 1	9 1 9 1 1		9 11 9 11 11 11 11	P U P U U F U	P U P U U P U	9 1 9 1 1	9 11 9 11 9 11	9 1 9 1 1			SD (	$\hat{\boldsymbol{\varphi}}$						AIRS			9 11 9 11 9 11	9 1) 9 1) 9	                		9 U 9 U 1			₽ IJ ₽ IJ ₽ IJ ₽	9 9 9 9 9 9	U P C C P U P
		U	U	9 11 11 11 11 11 11 11 11 11 11 11 11 11		9 11 11 11 11 11 11 11 11 11 11 11 11 11	Р          	P U U P U U		⊤          					P U P U U P U	9 11 11 11 11 11	             	SD _	             	9 11 11 11 11 11 11 11 11 11 11 11 11 11	9 11 11 11 11 11 11 11 11 11 11 11 11 11			9 11 11 11 11 11					9 11 11 11 11 11 11	9 11 11 11 11 11	Р Ц Ц Ц	9 9 9 1	₽       
9 9 0 9 0 9 0 9	          	9 11 11 11 11 11	9 U 9 U 9 U	9 1 1 1 1 1		9 11 11 11 11 11	9 11 11 11 11 11	ST                      			9 1 1 1 1 1 1 1	9 11 11 11 11			₽ U ₽ U ₽	9 11 19 11			9 1 9 1		9 1) 1) 1) 1) 1) 1) 1)	Р Ц Ц Ц Ц		9 11 19 11 11	P U U U U		₽ ┃ ┃ ┃ ┃ ┃ ┃				Р Ц Ц Ц	9 9 1 9 1	
P 	  []	<b>P</b> U	¶ U				<b>P</b> <b>U</b>				<b>P</b>		P U		<b>P</b>	<b>P</b>	<b>P</b> U	۹ ا	P U	<b>P</b> U	<b>P</b> U	P L		P U	P U	<b>P</b>	۲ ۲ ۲	۹ <sub>6"</sub> Ц	<b>P</b>	₽    36" ₽			 

SECOND FLOOR ELECTRICAL DEMOLITION PLAN

ELECTRICAL MISCELLANEOUS NOTES           A           B           C           D	CO         Arch       OP         1108 S. Main St. 102         Aberdeen, SD 57401         Phone: 605-725-4852         601 Kansas City St. 7         Rapid City, SD 57701         Phone: 605-716-3652         300 N. Phillips Ave. 120         Sioux Falls, SD 57104         Phone: 605-334-9999         co-oparch.com
Image: Decented specific notes	<image/> <text><text><text><text><text><text><text><text></text></text></text></text></text></text></text></text>
	ISSUE: Issue Date Project Status REVISION SCHEDULE: REV. # REV. DSC. REV. DATE PROJECT: SDSMT DEVEREAUX LIBRARY PHASE 1 SOUTH DAKOTA SCHOOL OF MINES AND TECHNOLOGY RAPID CITY, SOUTH DAKOTA SHEET TITLE: SECOND FLOOR ELECTRICAL DEMOLITION PLAN

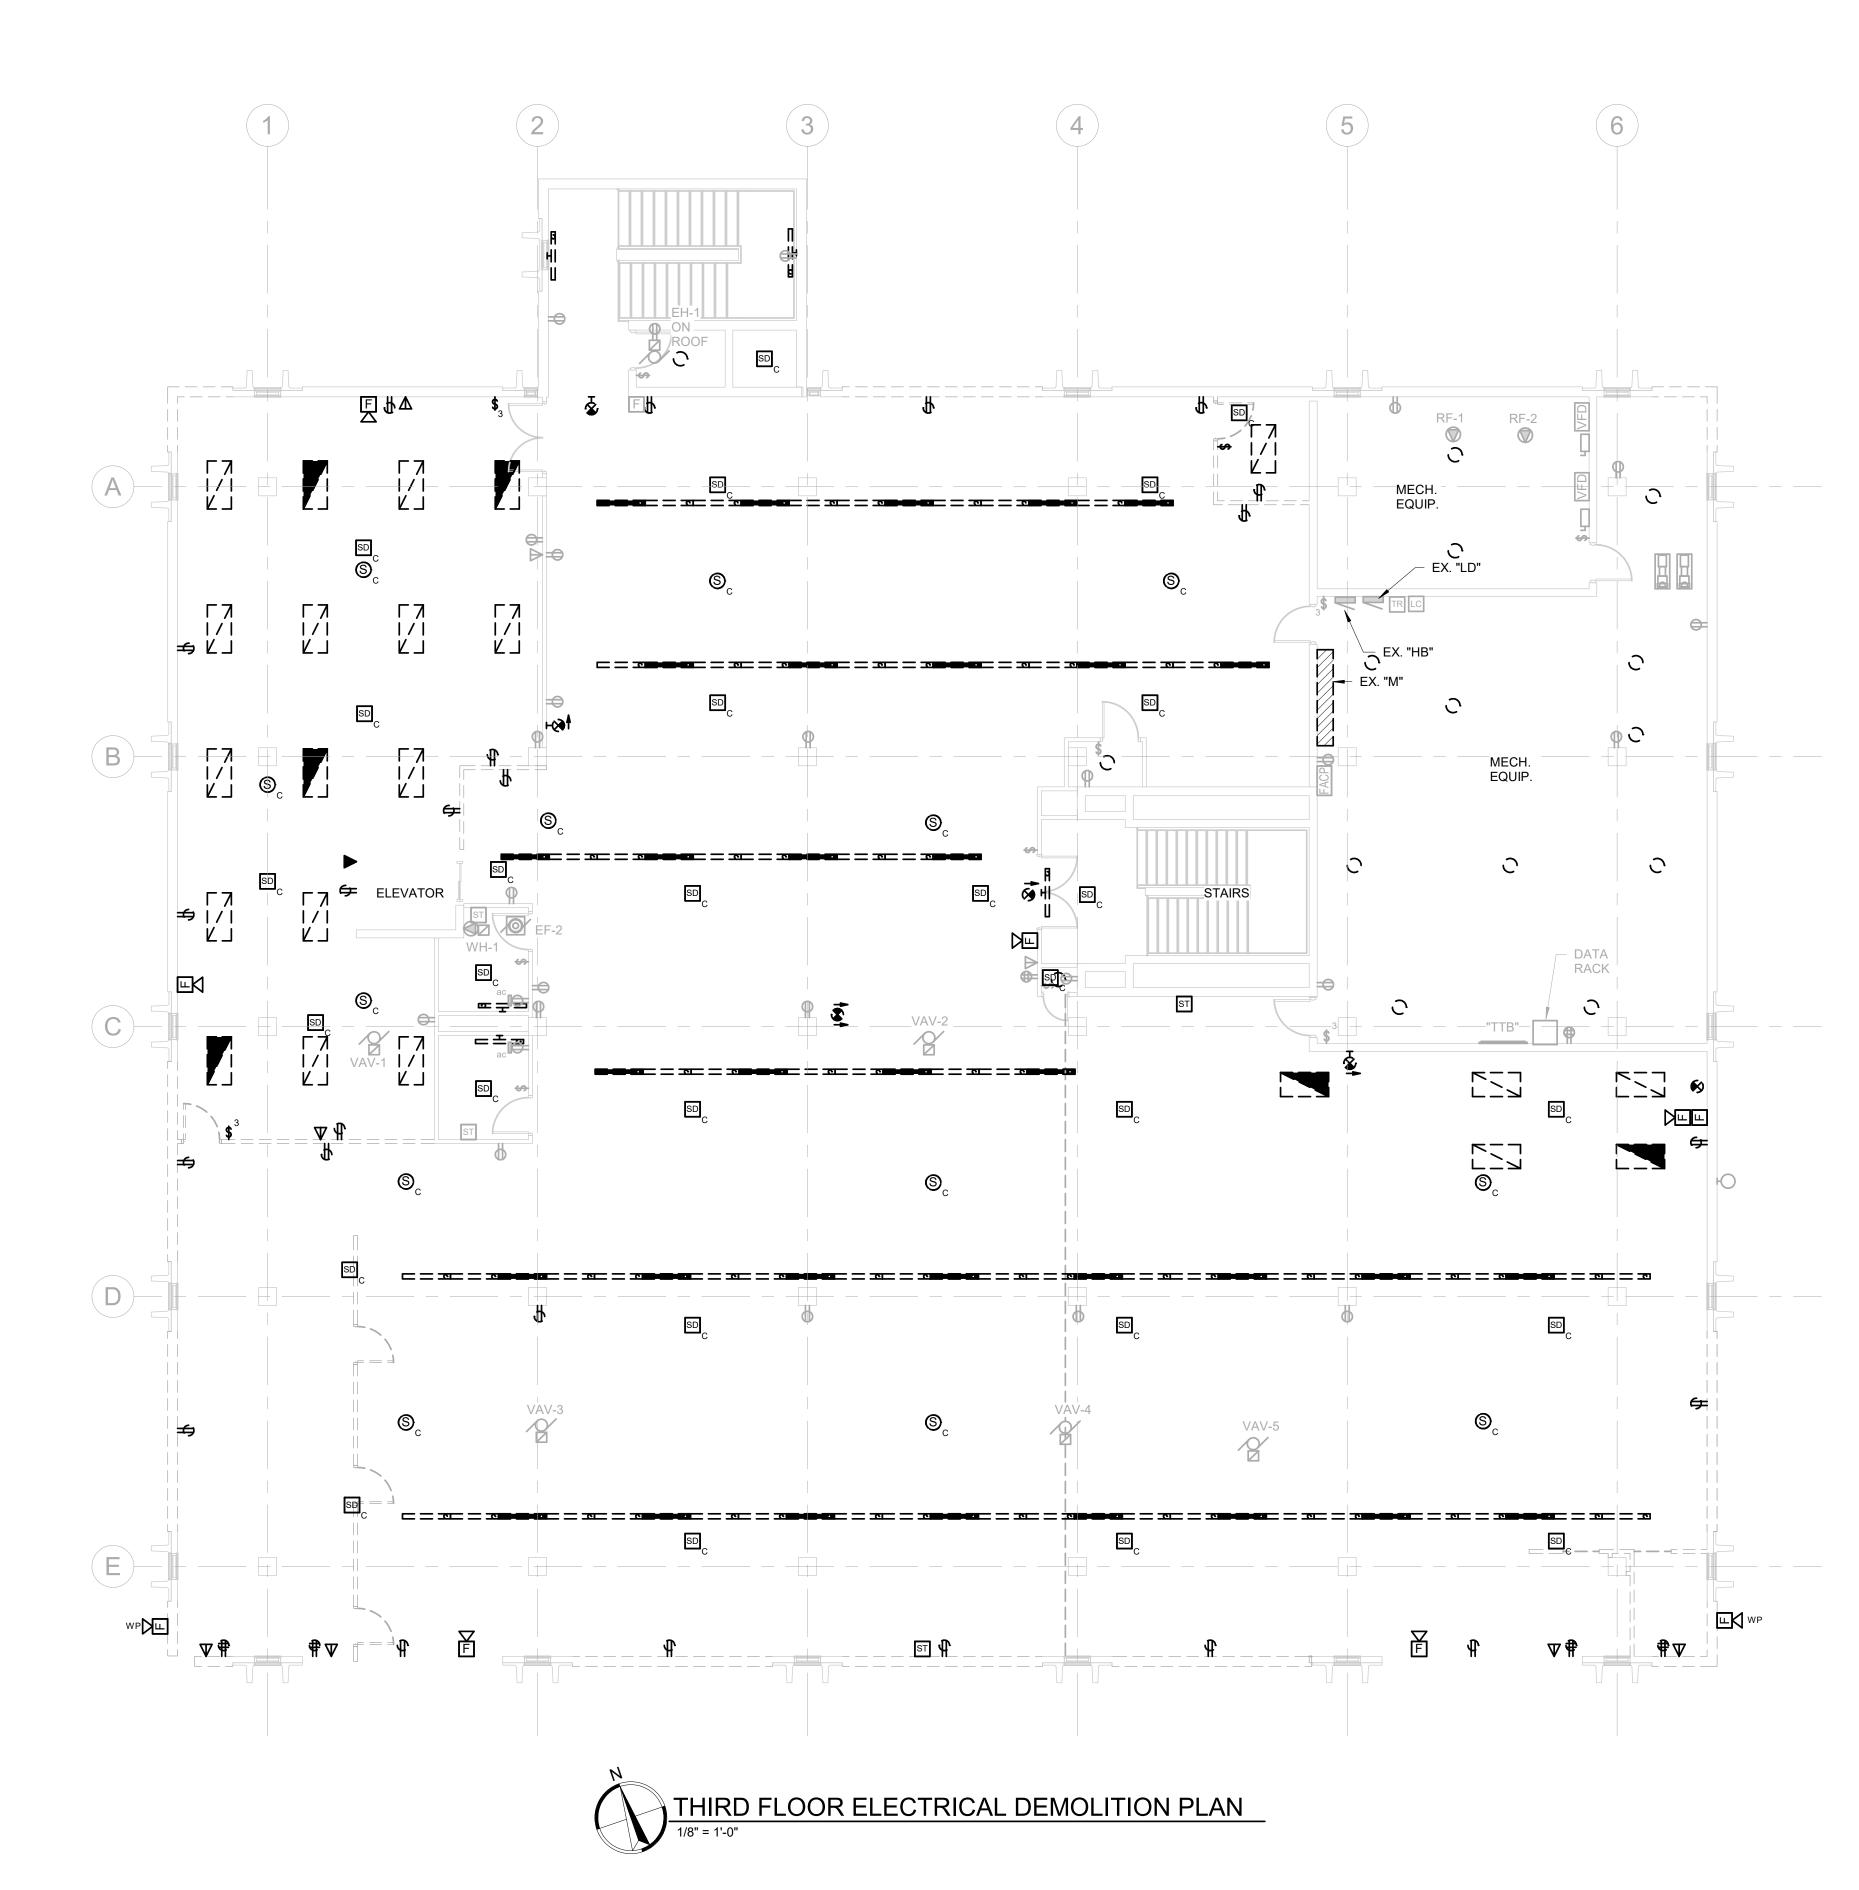


	СО
	Arch <b>OP</b>
	1108 S. Main St. 102 Aberdeen, SD 57401 Phone: 605-725-4852
	601 Kansas City St. 7 Rapid City, SD 57701 Phone: 605-716-3652
ELECTRICAL MISCELLANEOUS NOTES A B C	300 N. Phillips Ave. 120 Sioux Falls, SD 57104 Phone: 605-334-9999
ELECTRICAL SPECIFIC NOTES	co-oparch.com
	STRANG DESIGN SYNCHRONICITY
	811 East Washington Ave. 200 Madison, WI 53703 Phone: 608-276-9200
	W238N1610 Busse Rd. 102 Waukesha, WI 53188 Phone: 262-875-6760 strang-inc.com
	WPE# BR19035 WEST PLAINS ENGINEERING. INC. 1750 RAND ROAD • RAPID CITY SD, 57702 PHONE: (605) 348-7455 • FAX: (605) 348-9445 WWW.WESTPLAINSENGINEERING.COM RAPID CITY, SD • SIOUX FALLS, SD • CASPER, WY • CEDAR RAPIDS, IA • BISMARCK, ND
	CO-OP PROJECT NO: 1936
	PRELIMINARY NOT FOR CONSTRUCTION
	ISSUE: Issue Date Project Status REVISION SCHEDULE: REV. # REV. DSC. REV. DATE
	PROJECT: SDSMT DEVEREAUX LIBRARY PHASE 1 SOUTH DAKOTA SCHOOL OF MINES AND TECHNOLOGY RAPID CITY, SOUTH DAKOTA
	<u>SHEET TITLE:</u> THIRD FLOOR ELECTRICAL DEMOLITION PLAN
	E1-3

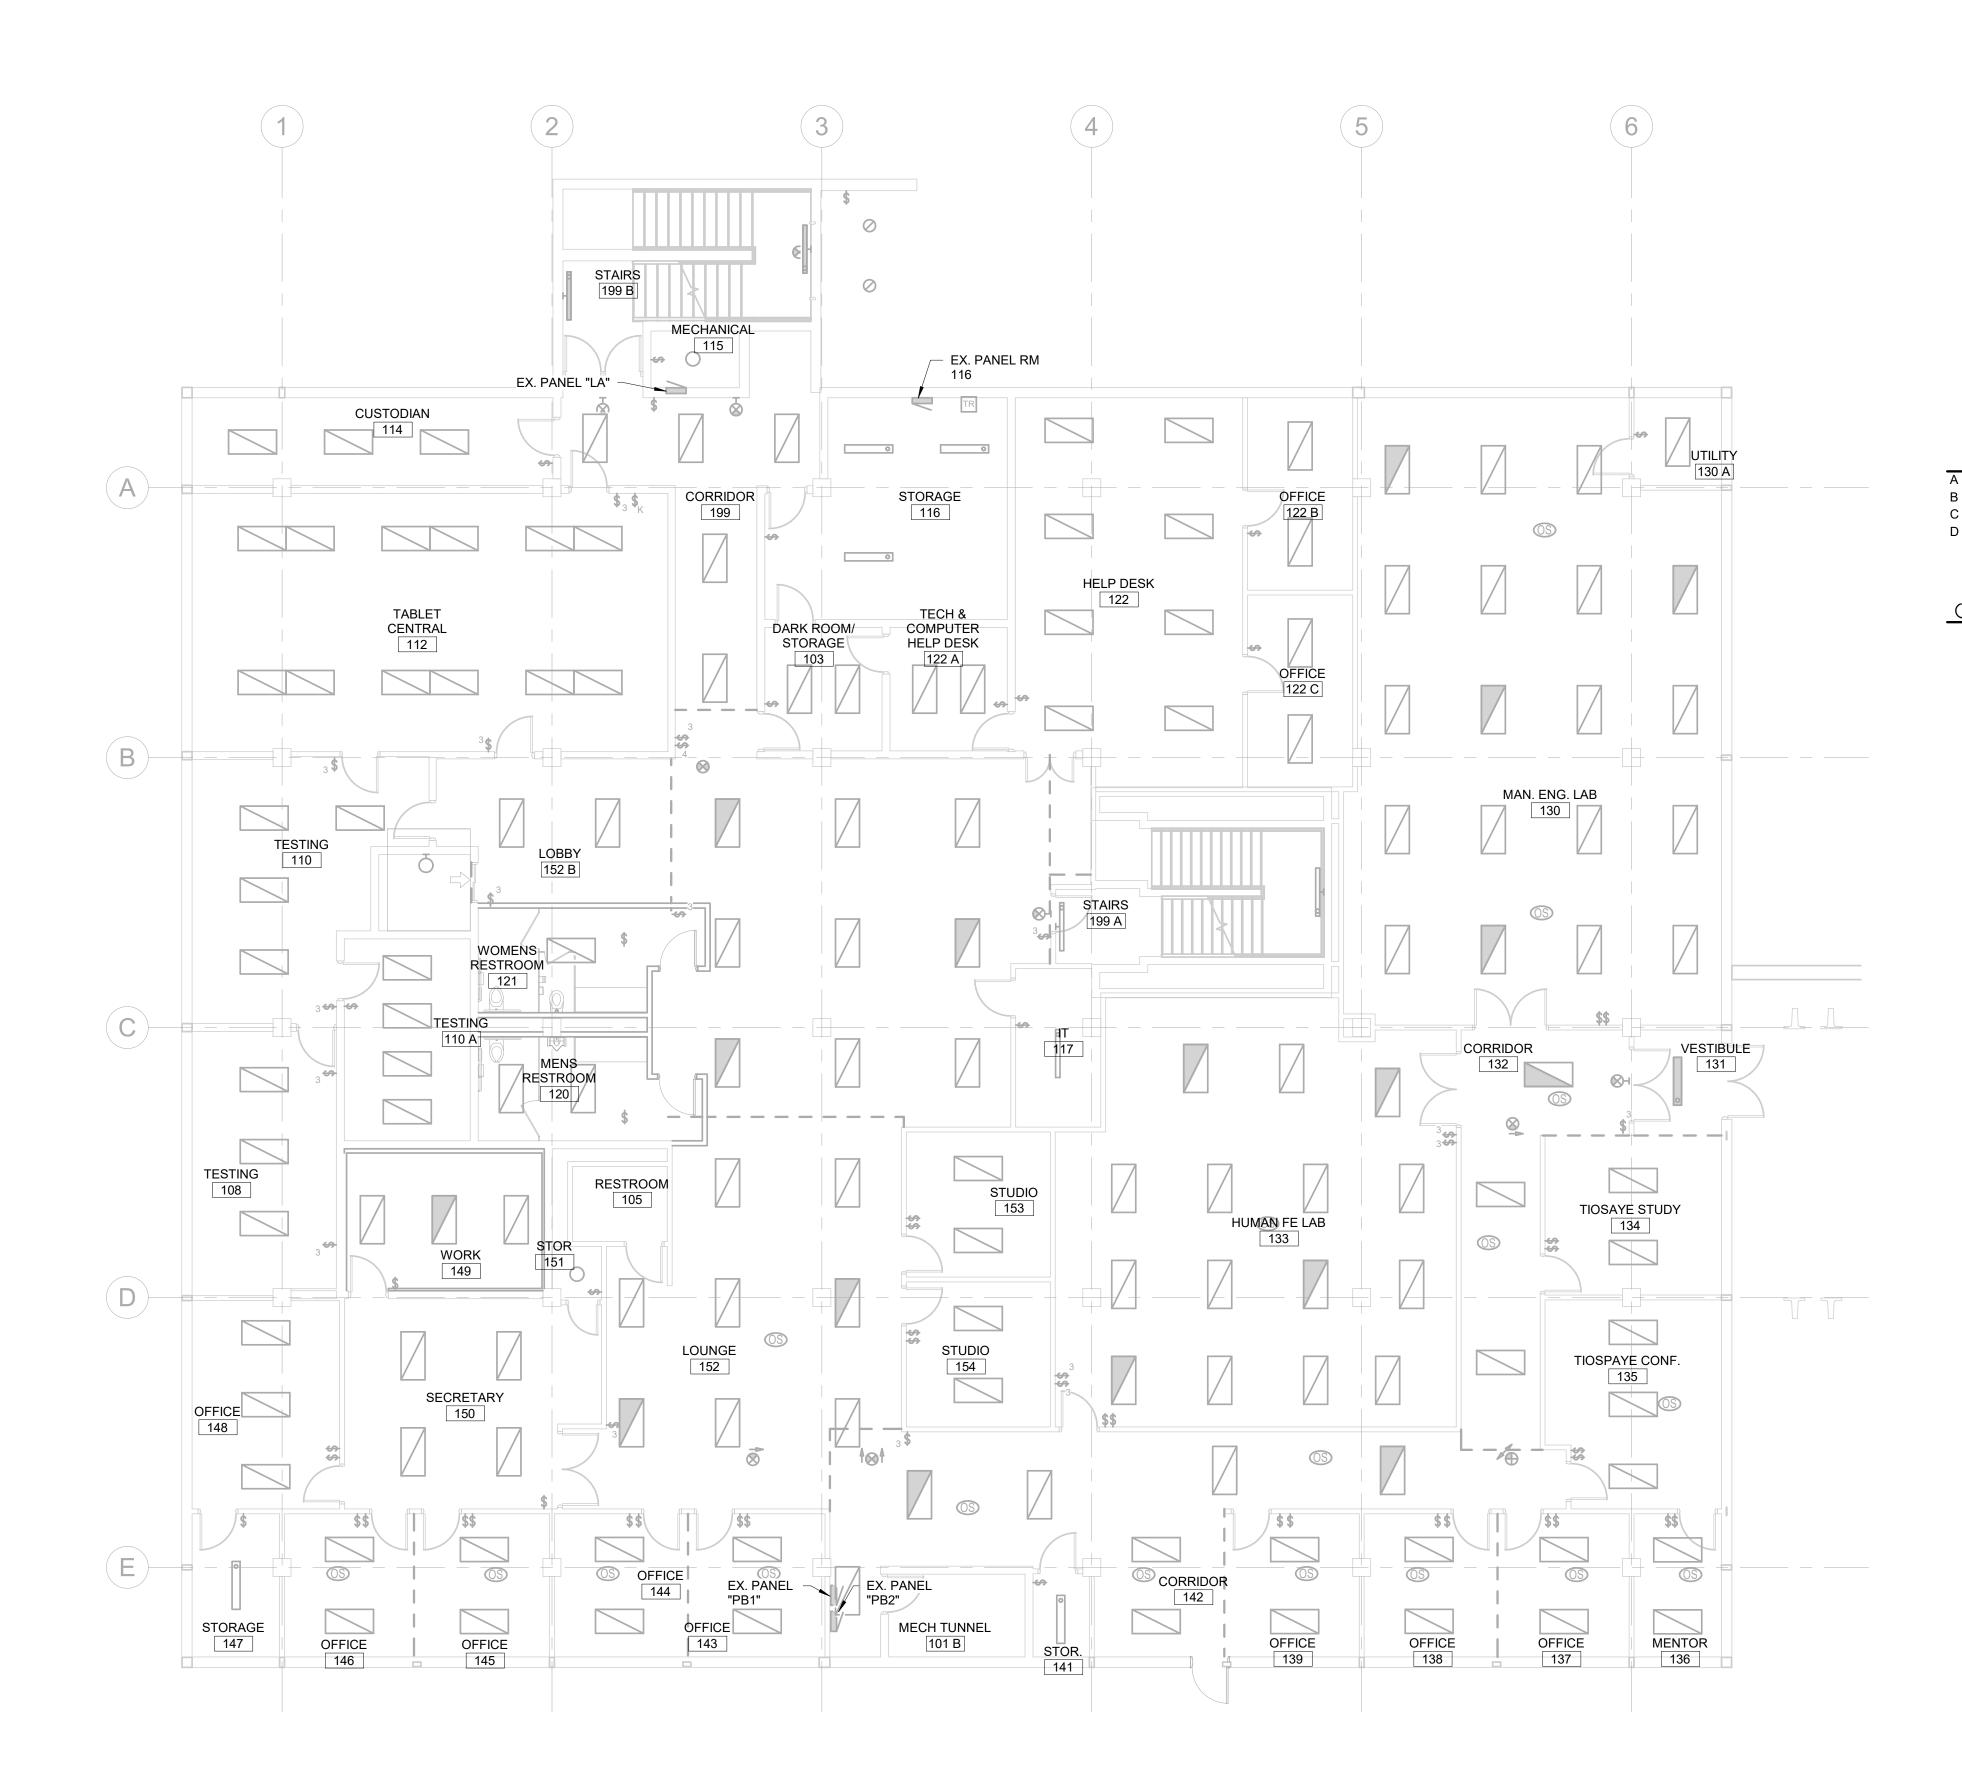







	CO	
		Aain St. 102
	Phone: 60 601 Kansa Rapid City	, SD 57401 5-725-4852 as City St. 7 v, SD 57701 5-716-3652
ELECTRICAL MISCELLANEOUS NOTES	Sioux Falls Phone: 60	lips Ave. 120 s, SD 57104 95-334-9999 arch.com
# ELECTRICAL SPECIFIC NOTES		RANG
	Madison, Phone: 60	nington Ave. 200 WI 53703 8-276-9200 Busse Rd. 102
	Waukesha Phone: 26	a, WI 53188 52-875-6760 -inc.com
	PHONE: (605) 348-74 WWW.WESTPLA RAPID CITY, SD - SIOUX FALLS, SD - CA	WEST PLAINS ENGINEERING. INC. • RAPID CITY SD, 57702 155 • FAX: (605) 348-9445 INSENGINEERING.COM SPER, WY • CEDAR RAPIDS, IA • BISMARCK, ND
	CO-OP PROJEC	<u>T NO: 1936</u> MINARY
		FOR RUCTION
	ISSUE: Issue Date Project St	ratus
	REVISION SCHE REV. # REV. E	
	PROJECT: SDSMT DEVERE PHASE 1 SOUTH DAKOTA MINES AND TEC RAPID CITY, SC	A SCHOOL OF CHNOLOGY
	<u>SHEET TITLE:</u> LOWER LEVEL	LIGHTING PLAN
	E2	2.0

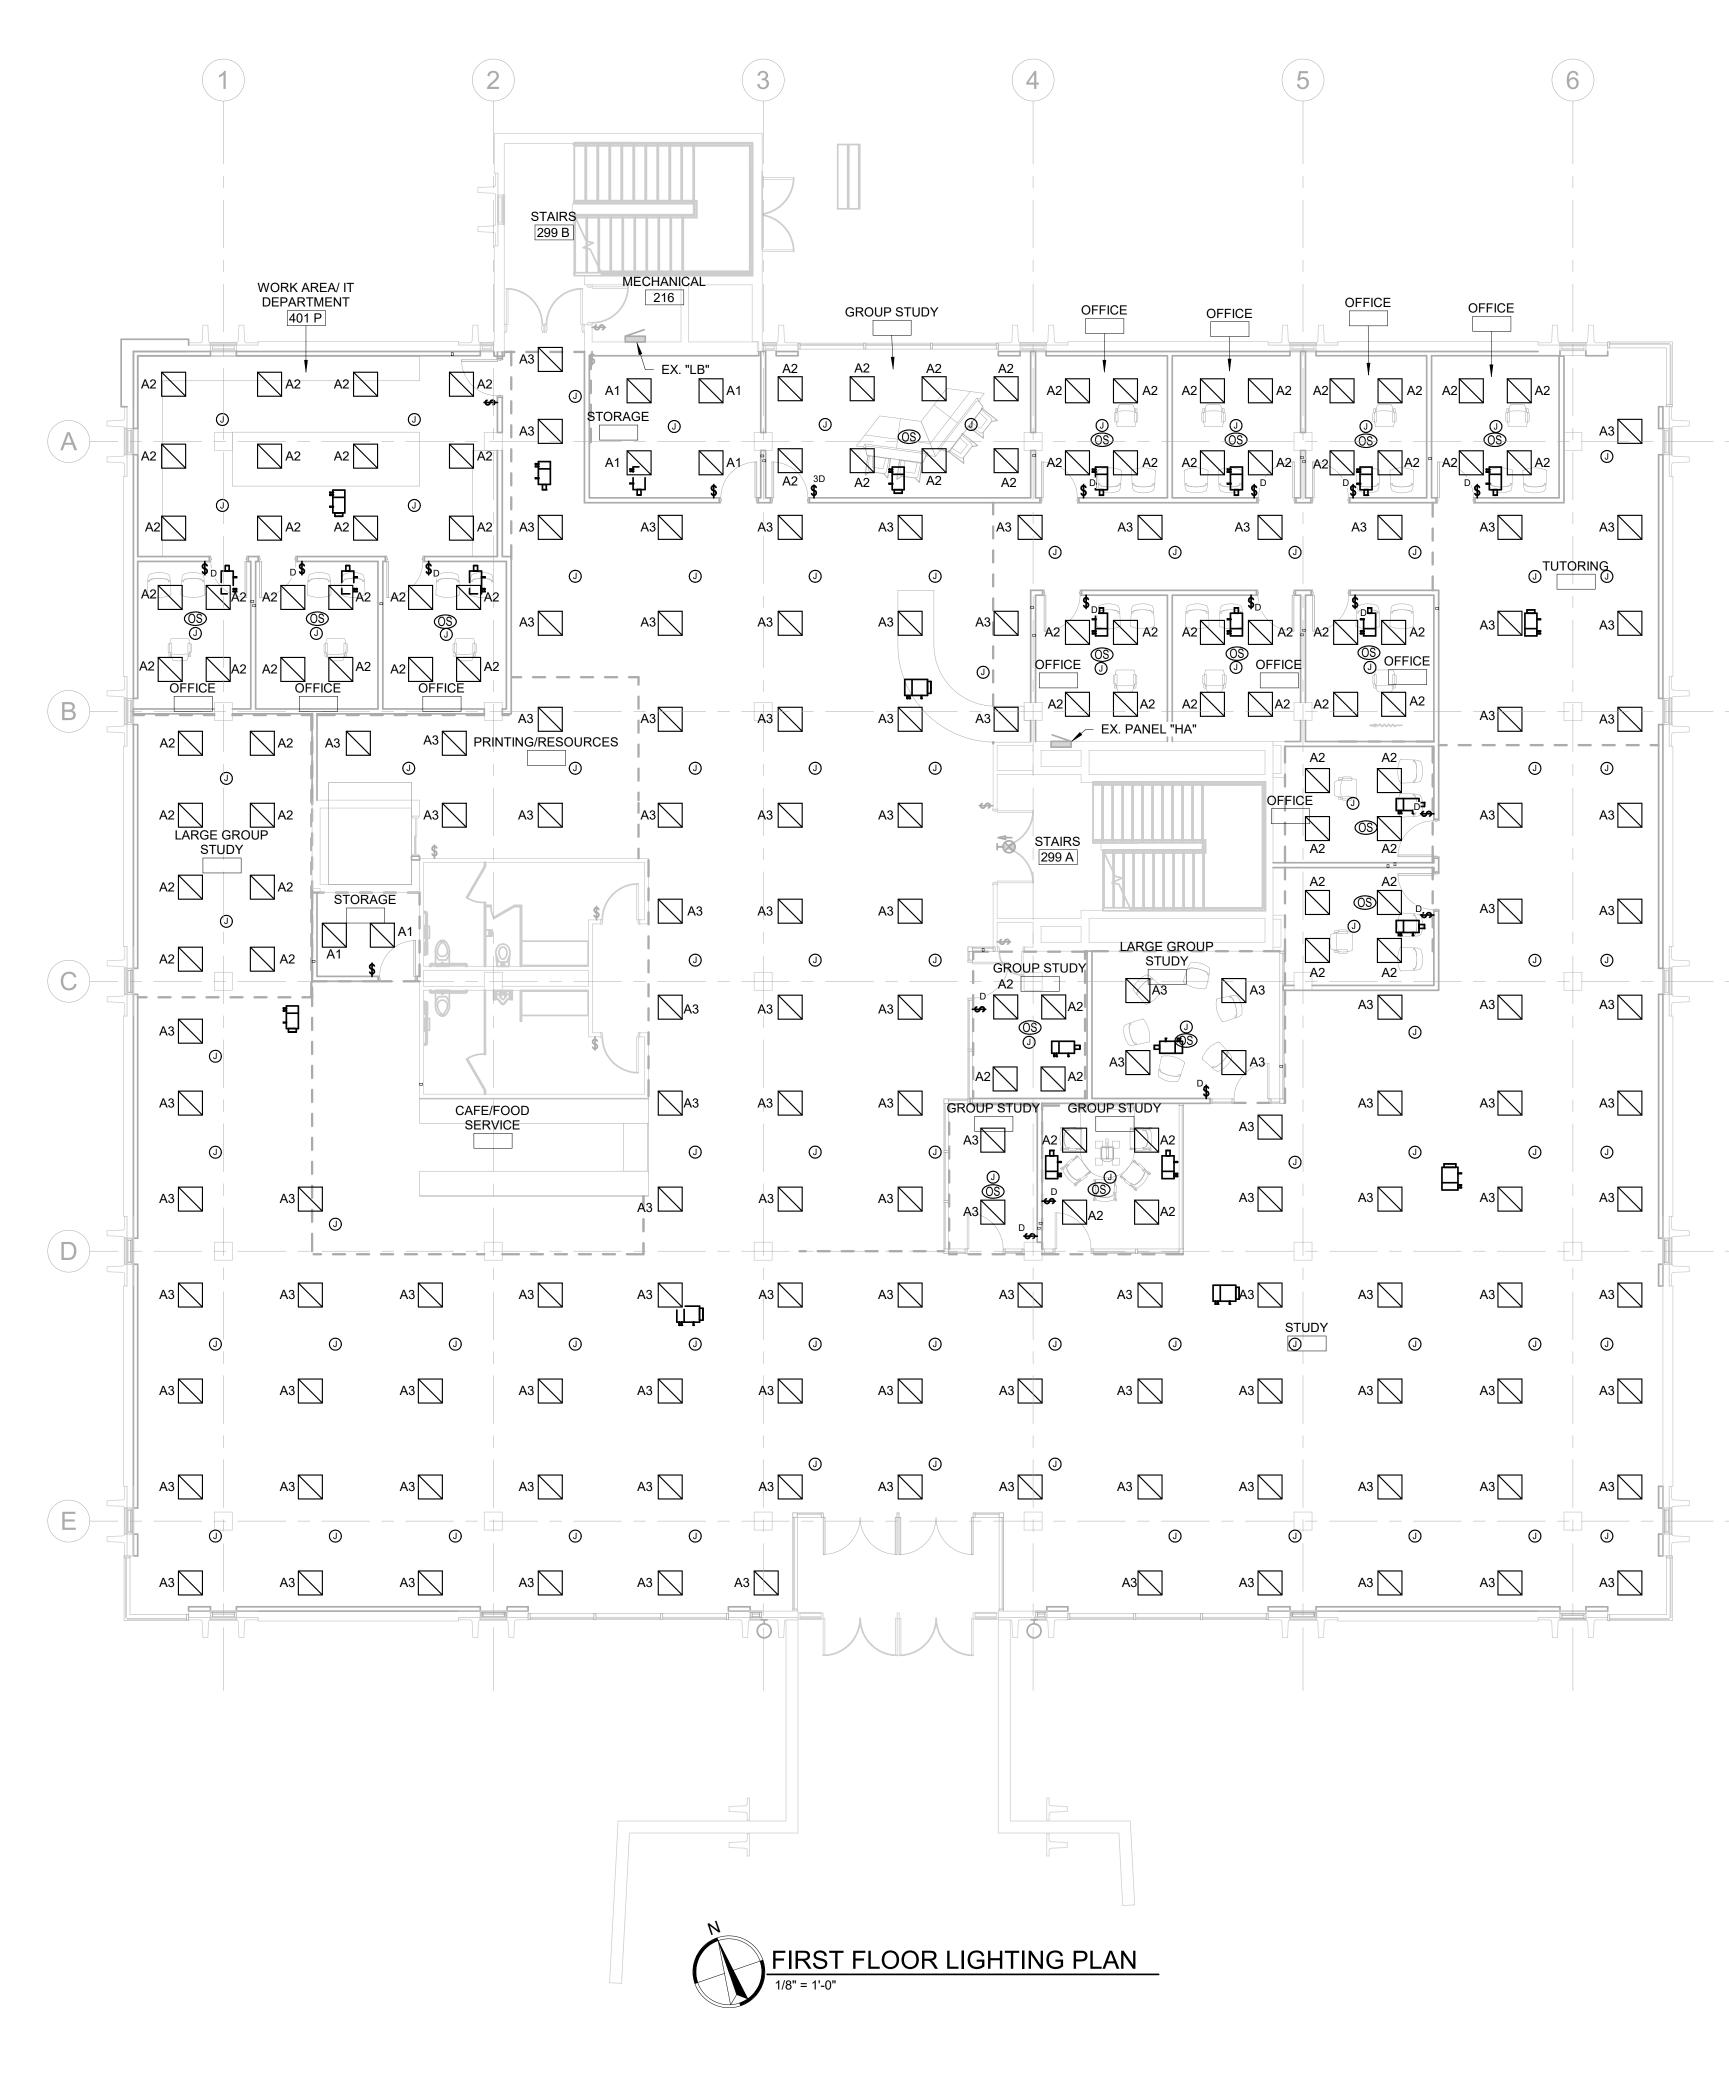


	CO Arch OP
ELECTRICAL MISCELLANEOUS NOTES	1108 S. Main St. 102 Aberdeen, SD 57401 Phone: 605-725-4852 601 Kansas City St. 7 Rapid City, SD 57701 Phone: 605-716-3652 300 N. Phillips Ave. 120 Sioux Falls, SD 57104 Phone: 605-334-9999
(#)       ELECTRICAL SPECIFIC NOTES	<image/> <text><text><text><text><text><text><text></text></text></text></text></text></text></text>
	PRELIMINARY         NOT FOR         NOT FOR         CONSTRUCTION
	PROJECT: SDSMT DEVEREAUX LIBRARY PHASE 1 SOUTH DAKOTA SCHOOL OF MINES AND TECHNOLOGY RAPID CITY, SOUTH DAKOTA

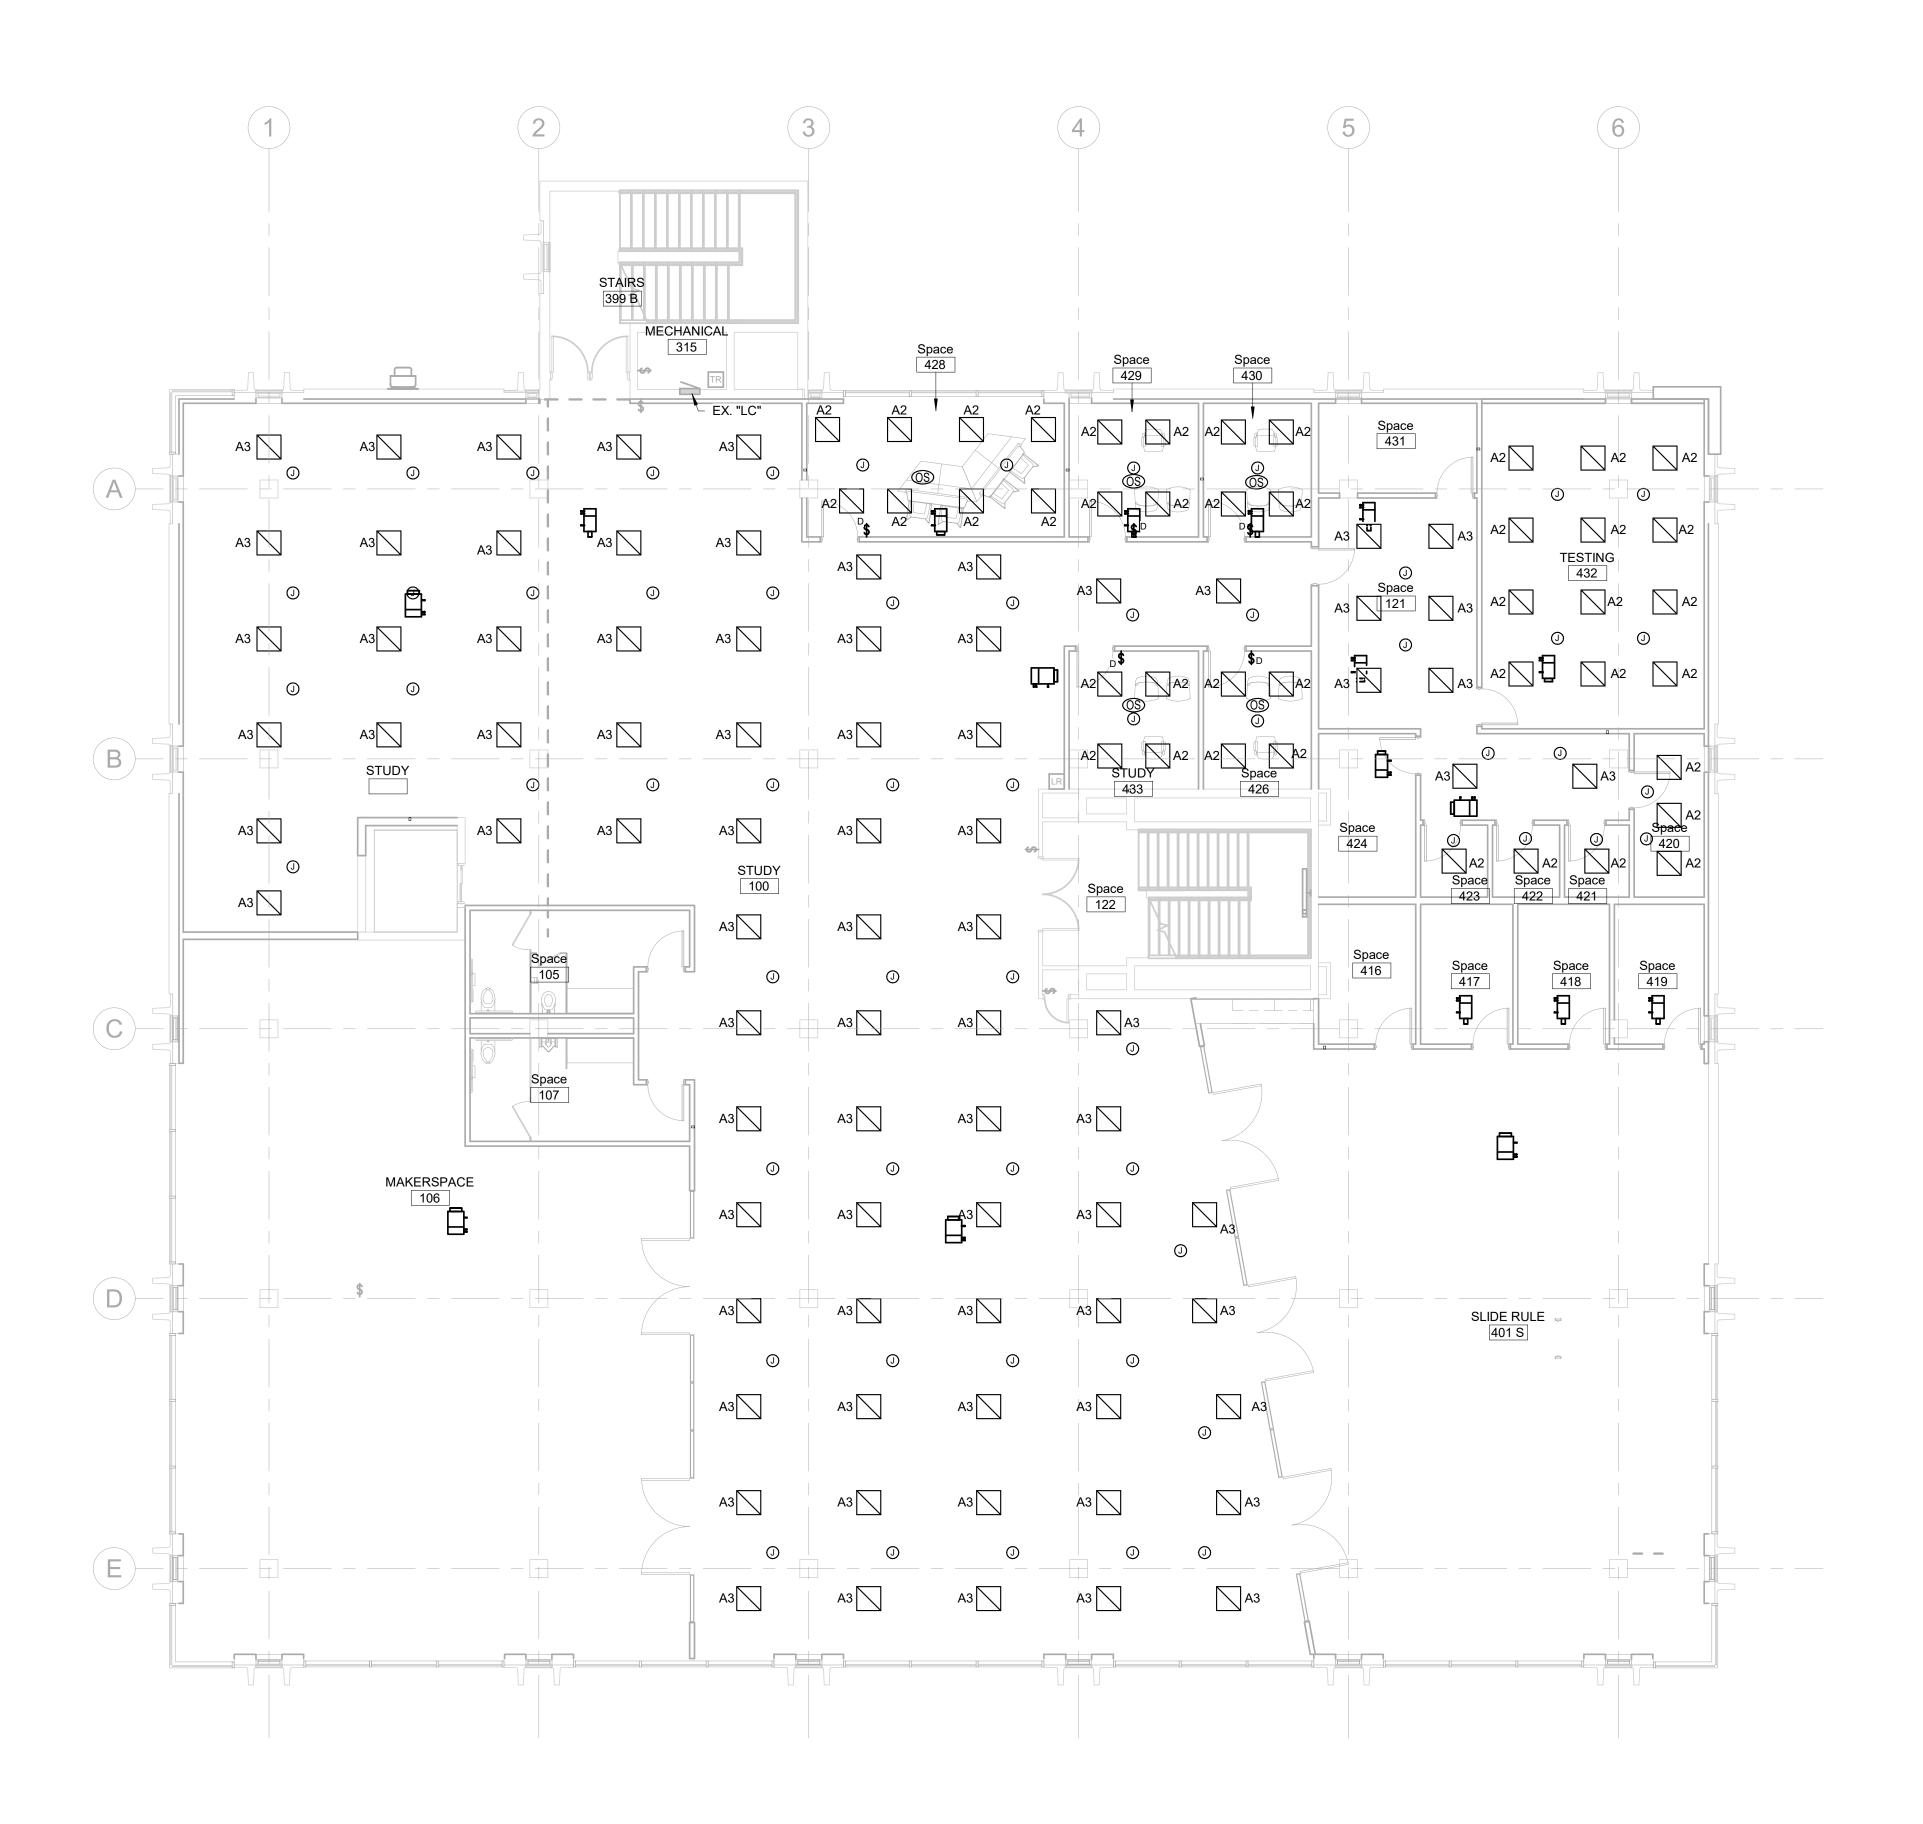


	CO
	Arch <b>OP</b>
	1108 S. Main St. 102 Aberdeen, SD 57401 Phone: 605-725-4852
ELECTRICAL MISCELLANEOUS NOTES	601 Kansas City St. 7 Rapid City, SD 57701 Phone: 605-716-3652 300 N. Phillips Ave. 120
	Sioux Falls, SD 57104 Phone: 605-334-9999 co-oparch.com
# ELECTRICAL SPECIFIC NOTES	
	STRANG DESIGN SYNCHRONICITY
	811 East Washington Ave. 200 Madison, WI 53703 Phone: 608-276-9200
	W238N1610 Busse Rd. 102 Waukesha, WI 53188 Phone: 262-875-6760 strang-inc.com
	WPE# BR19035 WEST PLAINS ENGINEERING. INC. 1750 RAND ROAD • RAPID CITY SD, 57702 PHONE: (605) 348-7455 • FAX: (605) 348-9445 WWW.WESTPLAINSENGINEERING.COM RAPID CITY, SD • SIDUX FALLS, SD • CASPER, WY • CEDAR RAPIDS, IA • BISMARCK, ND
	CO-OP PROJECT NO: 1936
	PRELIMINARY NOT FOR CONSTRUCTION
	ISSUE: Issue Date Project Status
	REVISION SCHEDULE: REV. # REV. DSC. REV. DATE
	PROJECT: SDSMT DEVEREAUX LIBRARY PHASE 1 SOUTH DAKOTA SCHOOL OF MINES AND TECHNOLOGY RAPID CITY, SOUTH DAKOTA
	<u>SHEET TITLE:</u> SECOND FLOOR LIGHTING PLAN
	E2.2

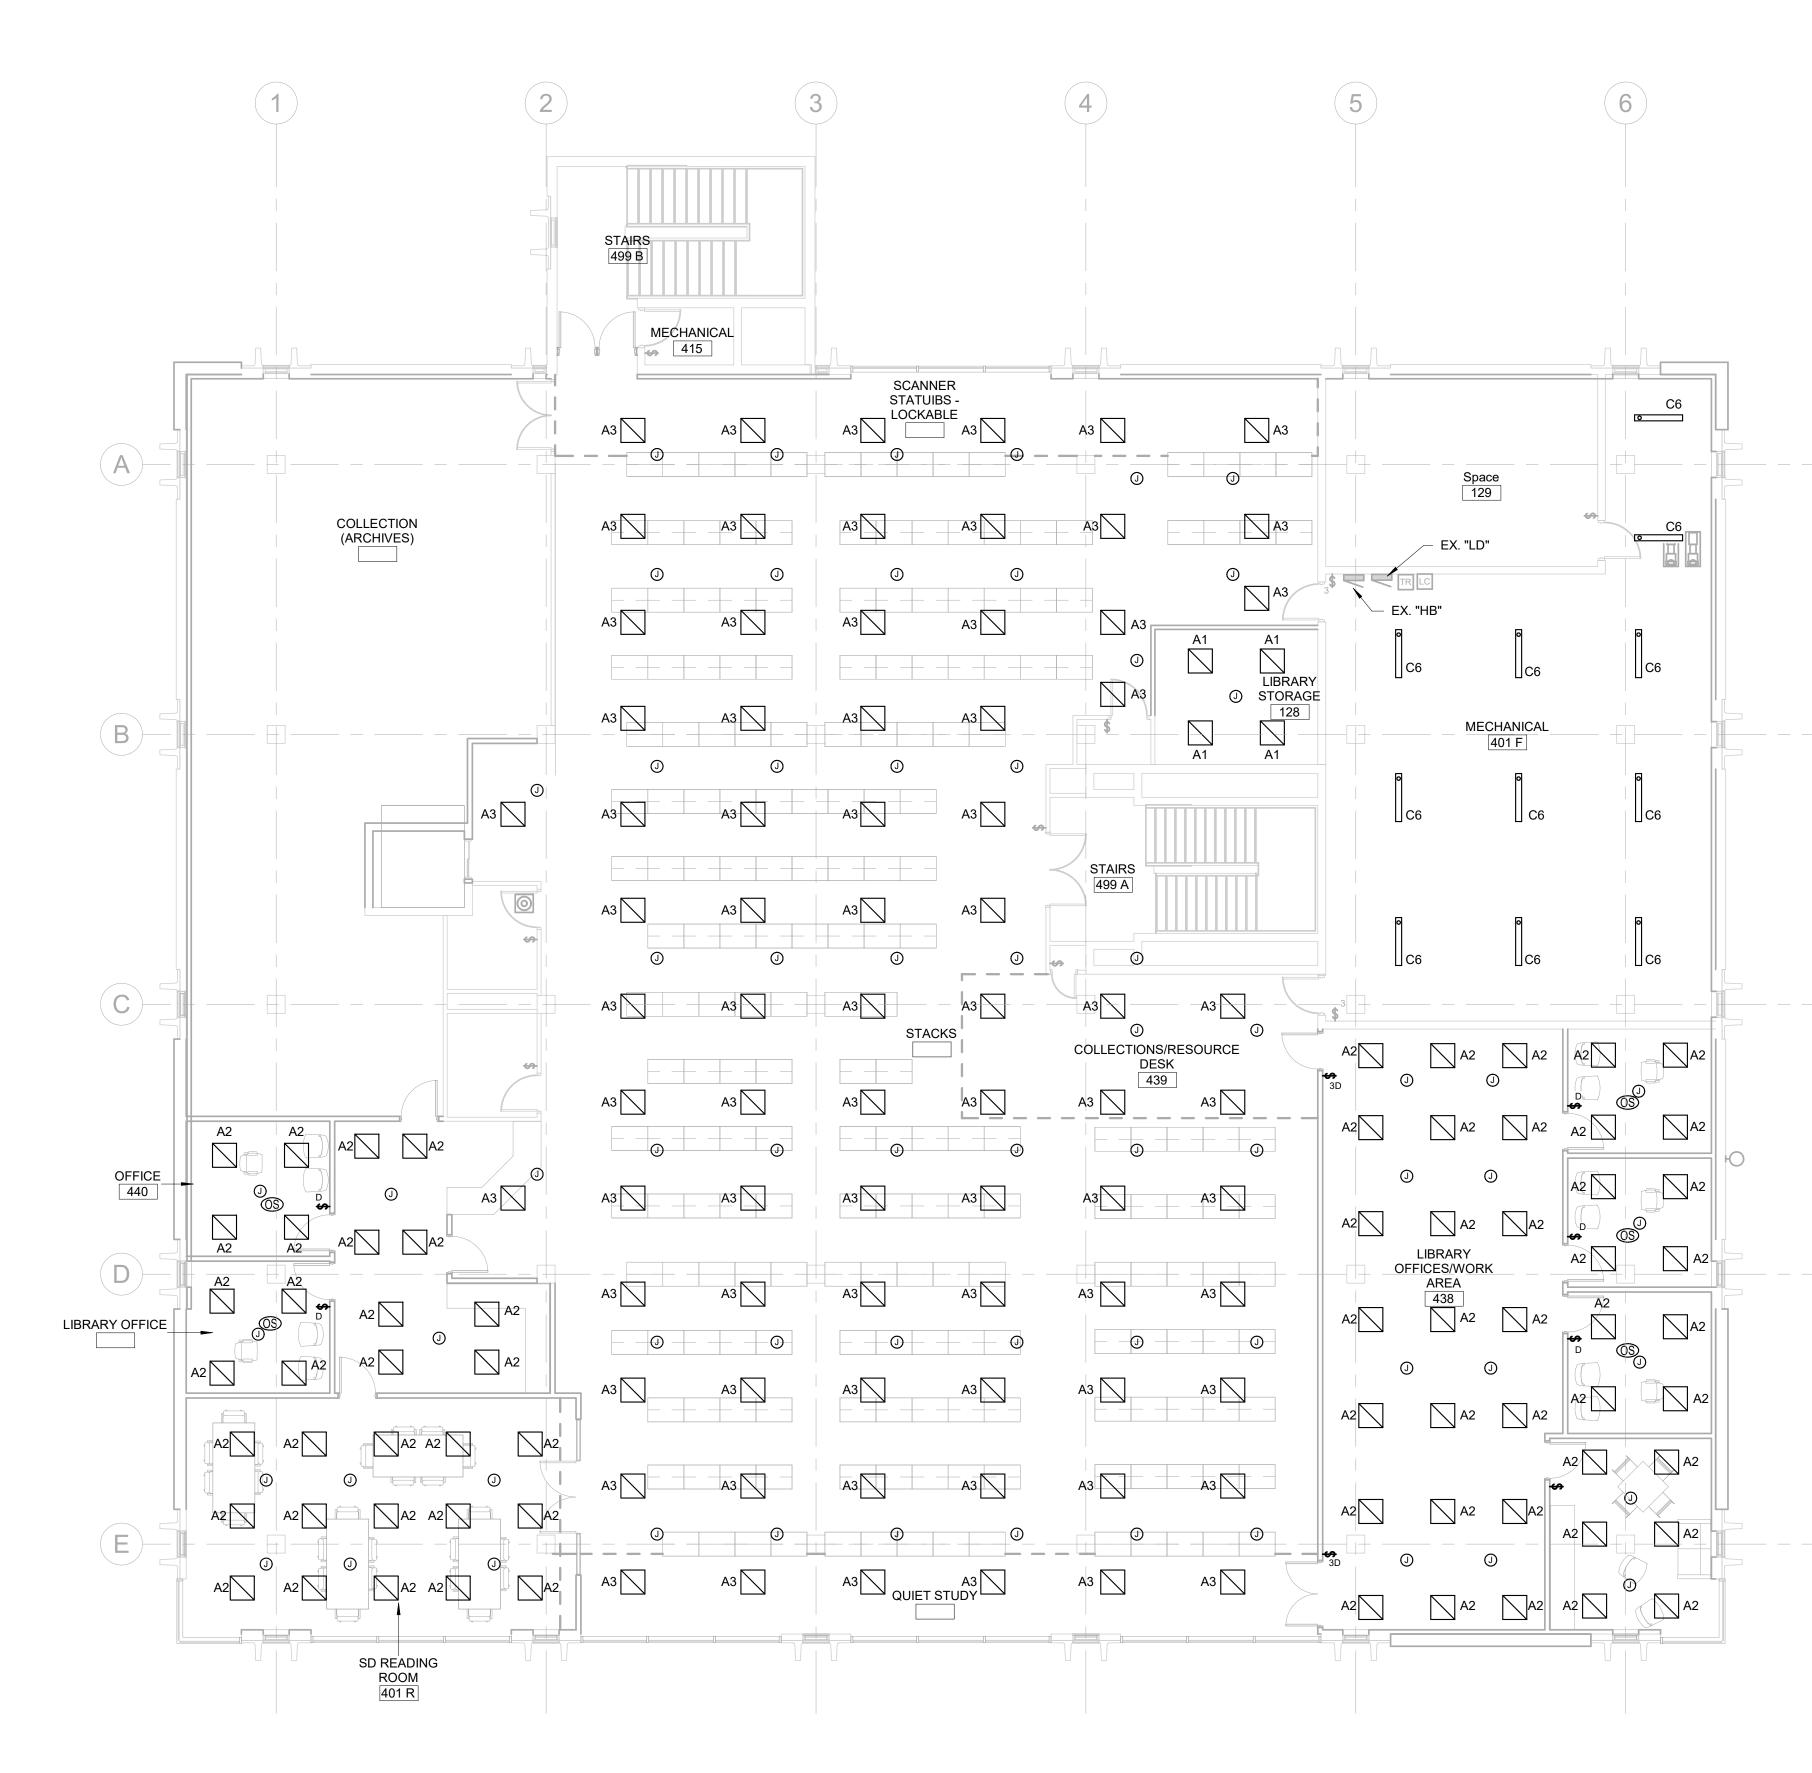

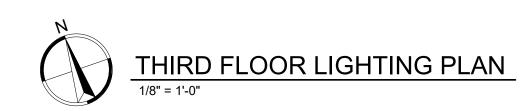


	CO Arch OP
ELECTRICAL MISCELLANEOUS NOTES A B C D	1108 S. Main St. 102 Aberdeen, SD 57401 Phone: 605-725-4852 601 Kansas City St. 7 Rapid City, SD 57701 Phone: 605-716-3652 300 N. Phillips Ave. 120 Sioux Falls, SD 57104 Phone: 605-334-9999 co-oparch.com
ELECTRICAL SPECIFIC NOTES	4.
	DESIGN SYNCHRONICITY
	811 East Washington Ave. 200 Madison, WI 53703 Phone: 608-276-9200 W238N1610 Busse Rd. 102 Waukesha, WI 53188 Phone: 262-875-6760 strang-inc.com
	WPE# BR19035 WEST PLAINS ENGINEERING. INC. 1750 RAND ROAD - RAPID CITY SD, 57702 PHONE: 005) 348-7455 - FAX: (605) 348-9445 WWW.WESTHAINSCHREIMICGOM RAPID CITY, SD - SIOUX FALLS, SD - CASPER, WY - CEDAR RAPIDS, IA - BISMARCK, ND
	CO-OP PROJECT NO: 1936 PRELIMINARY NOT FOR CONSTRUCTION
	ISSUE: Issue Date Project Status REVISION SCHEDULE: REV. # REV. DSC. REV. DATE
	PROJECT: SDSMT DEVEREAUX LIBRARY PHASE 1 SOUTH DAKOTA SCHOOL OF MINES AND TECHNOLOGY RAPID CITY, SOUTH DAKOTA
	<u>SHEET TITLE:</u> THIRD FLOOR LIGHTING PLAN
	E2.3

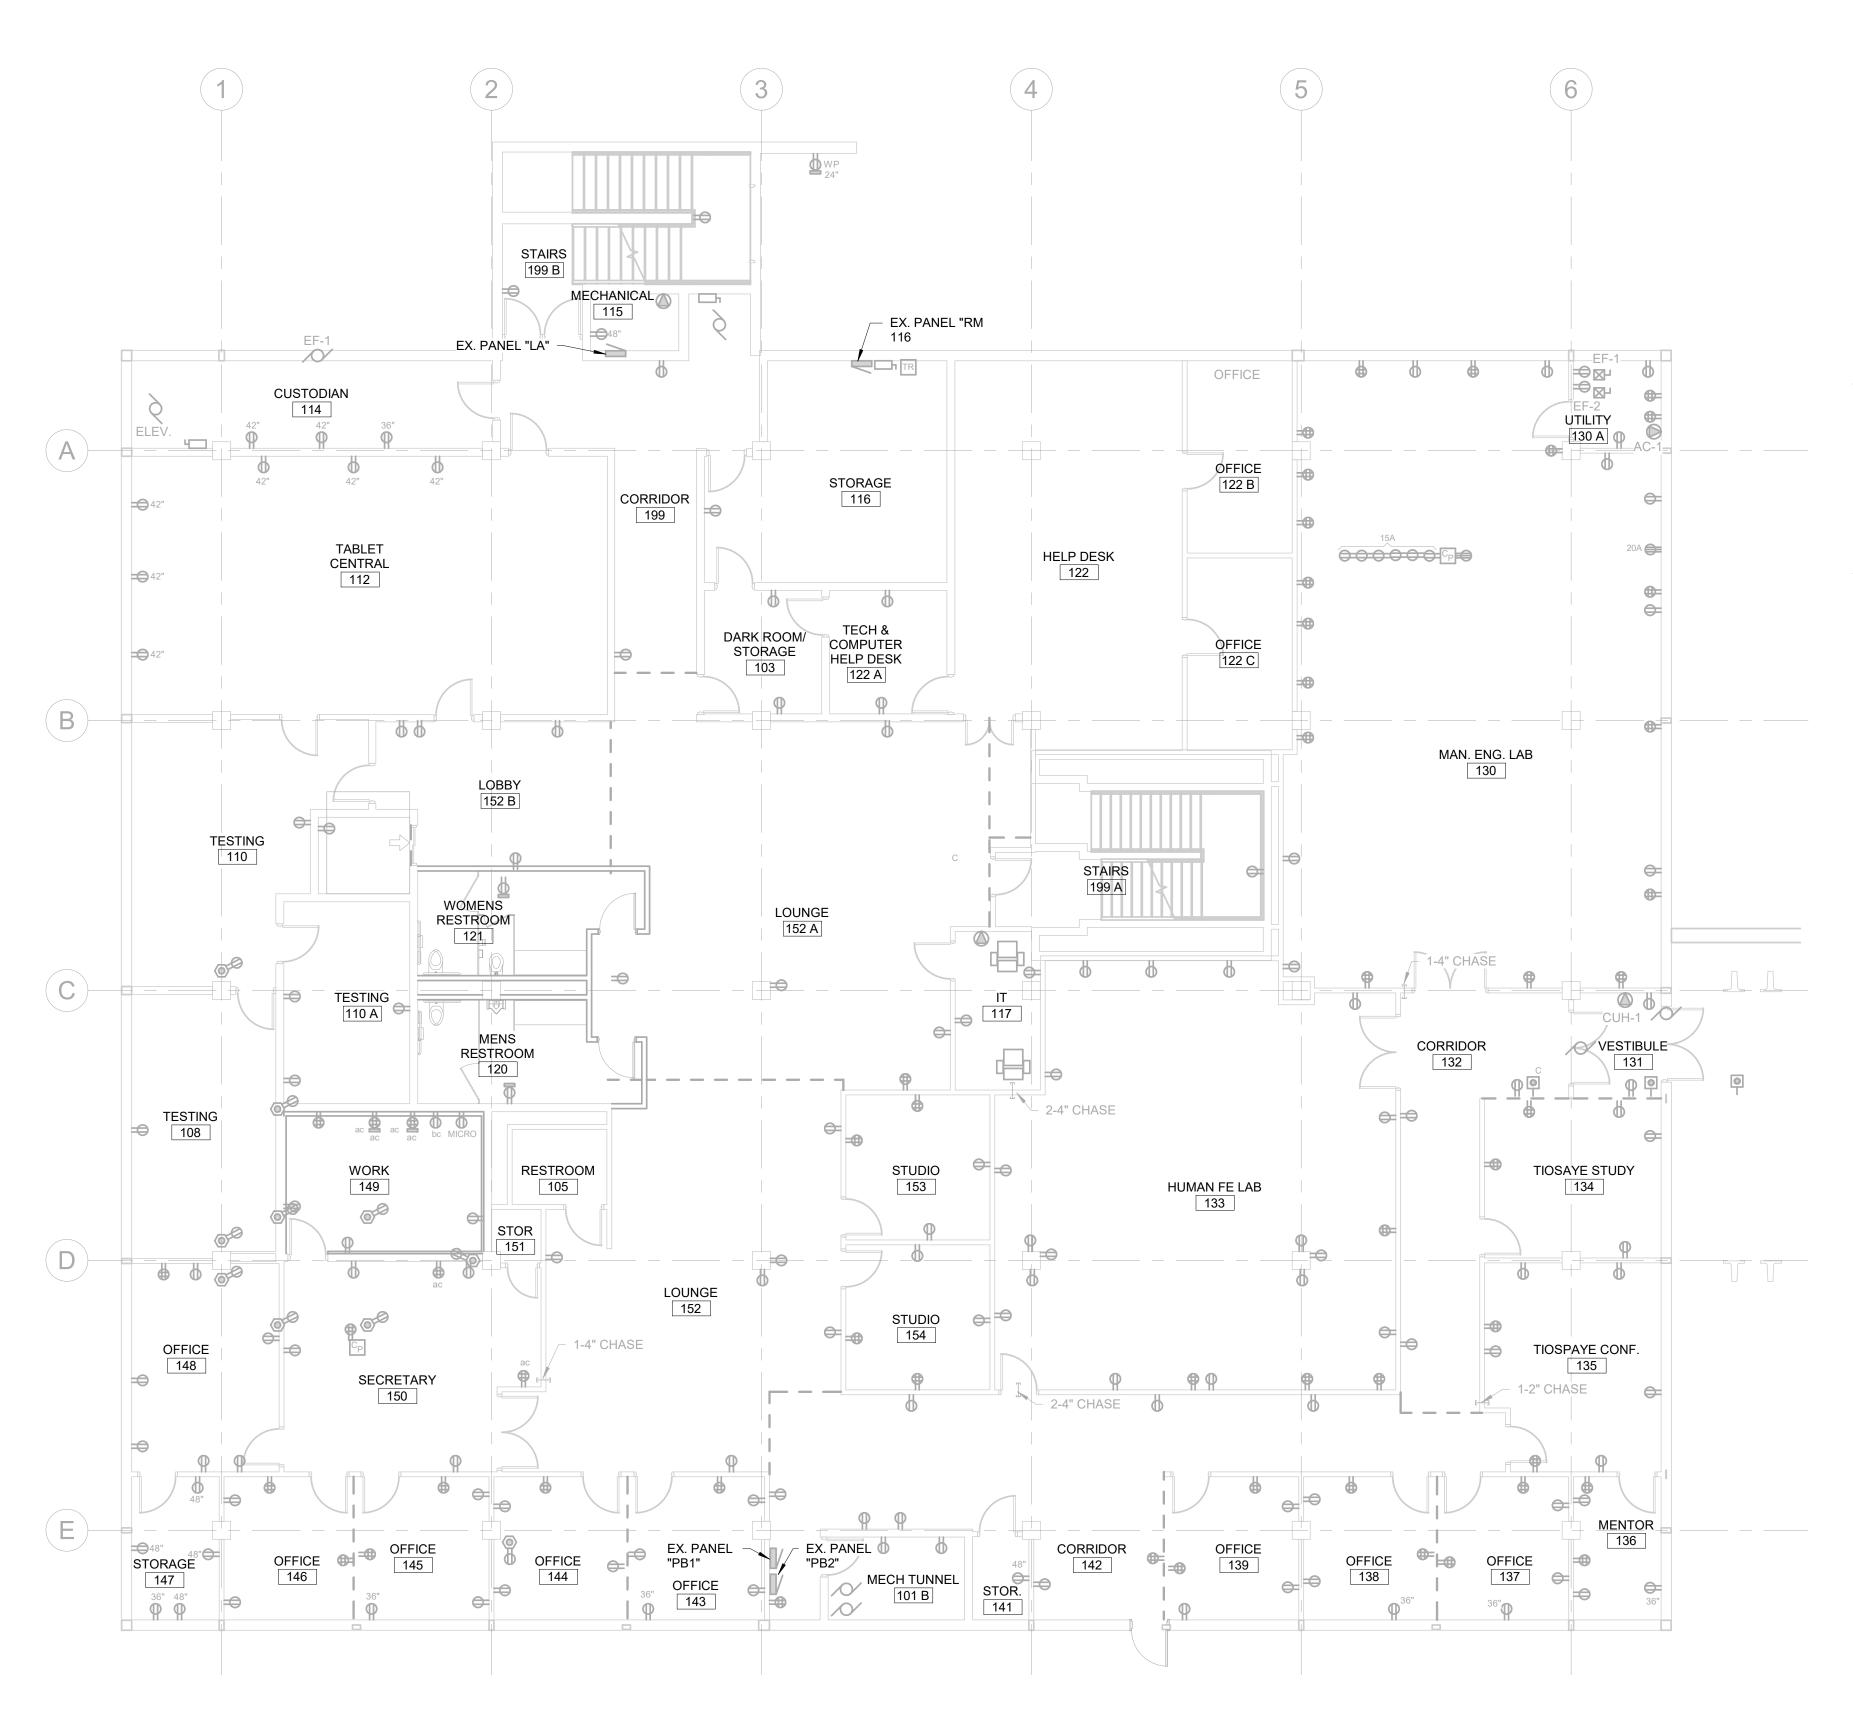

LOWER LEVEL POWER PLAN 1/8" = 1'-0"

	CO	
	Arch	OP
ELECTRICAL MISCELLANEOUS NOTES	Aberdeen Phone: 60 601 Kansa Rapid City	Main St. 102 , SD 57401 95-725-4852 as City St. 7 7, SD 57701 95-716-3652
A B C D	Sioux Falls Phone: 60	lips Ave. 120 s, SD 57104 )5-334-9999 arch.com
# ELECTRICAL SPECIFIC NOTES		RANG
	Madison, Phone: 60 W238N1610 Waukesha	nington Ave. 200 , WI 53703 )8-276-9200 Busse Rd. 102 a, WI 53188 52-875-6760
	1750 RAND ROAD PHONE: (605) 348-7 www.westru	WPE# BR19035 WEST PLAINS ENGINEERING. INC. • RAPID CITY SD, 57702 455 • FAX: (605) 348-9445 UNBRENCHERING.COM SPER, WY • CEDAR RAPIDS, IA • BISMARCK, ND
	NOT	MINARY FOR RUCTION
	ISSUE: Issue Date Project St REVISION SCHE REV. # REV. E	EDULE:
	PROJECT: SDSMT DEVERE PHASE 1 SOUTH DAKOTA MINES AND TEC RAPID CITY, SC	A SCHOOL OF CHNOLOGY
	<u>SHEET TITLE:</u> LOWER LEVEL	POWER PLAN
	E	3.0

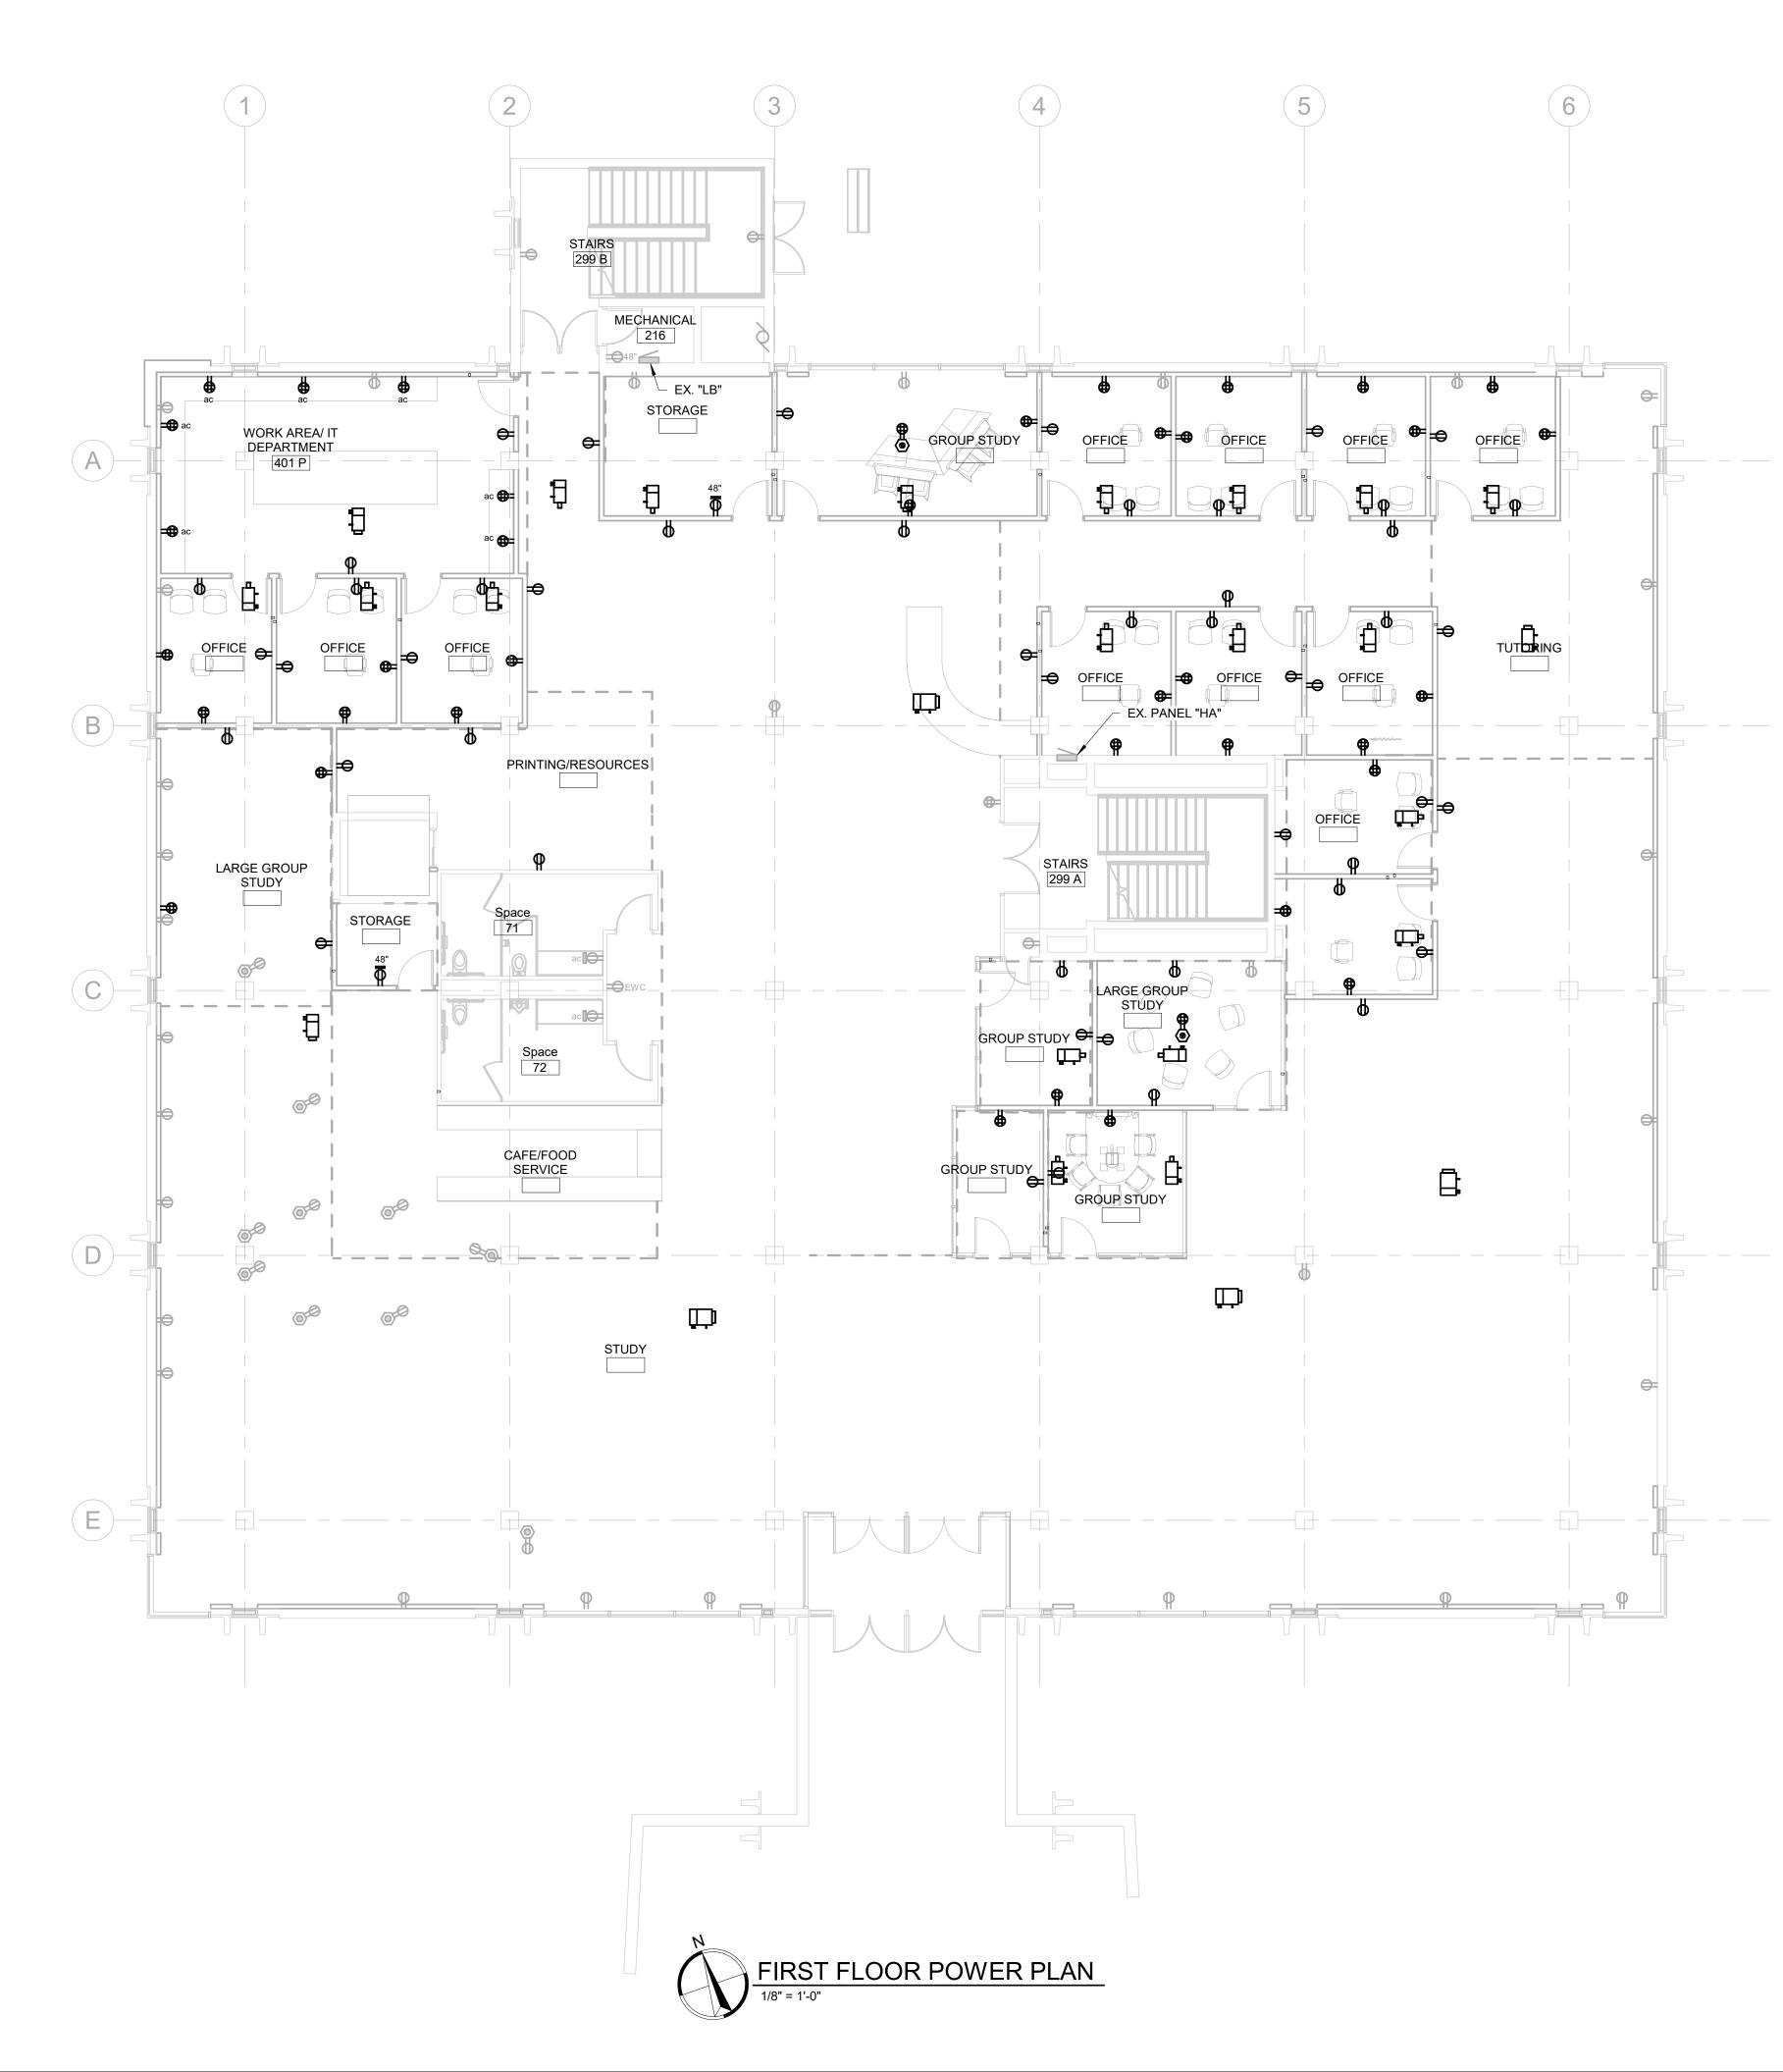


	CO
	Arch <b>OP</b>
	1108 S. Main St. 102 Aberdeen, SD 57401 Phone: 605-725-4852
ELECTRICAL MISCELLANEOUS NOTES A B C D	601 Kansas City St. 7 Rapid City, SD 57701 Phone: 605-716-3652 300 N. Phillips Ave. 120 Sioux Falls, SD 57104
# ELECTRICAL SPECIFIC NOTES	Phone: 605-334-9999 co-oparch.com
	STRANG DESIGN SYNCHRONICITY
	811 East Washington Ave. 200 Madison, WI 53703 Phone: 608-276-9200
	W238N1610 Busse Rd. 102 Waukesha, WI 53188 Phone: 262-875-6760 strang-inc.com
	WPE# BR19035 WEST PLAINS ENGINEERING. INC. 1750 RAND ROAD • RAPID CITY SD, 57702 PHONE: (605) 348-7455 • FAX: (605) 348-9445 WWW.WESTPLAINSCHERING.COM RAPID CITY, SD • SIOUX FALLS, SD • CASPER, WY • CEDAR RAPIDS, IA • BISMARCK, ND
	CO-OP PROJECT NO: 1936
	PRELIMINARY NOT FOR CONSTRUCTION
	ISSUE: Issue Date Project Status
	REVISION SCHEDULE: REV. # REV. DSC. REV. DATE
	PROJECT: SDSMT DEVEREAUX LIBRARY PHASE 1 SOUTH DAKOTA SCHOOL OF MINES AND TECHNOLOGY RAPID CITY, SOUTH DAKOTA
	<u>SHEET TITLE:</u> FIRST FLOOR POWER PLAN
	E3.1






	CO Arch OP
ELECTRICAL MISCELLANEOUS NOTES	1108 S. Main St. 102 Aberdeen, SD 57401 Phone: 605-725-4852 601 Kansas City St. 7 Rapid City, SD 57701 Phone: 605-716-3652 300 N. Phillips Ave. 120 Sioux Falls, SD 57104 Phone: 605-334-9999 co-oparch.com
# ELECTRICAL SPECIFIC NOTES	811 East Washington Ave. 200 Madison, WI 53703
	Phone: 608-276-9200 W238N1610 Busse Rd. 102 Waukesha, WI 53188 Phone: 262-875-6760 strang-inc.com
	150 RAND ROAD - RAPID CITY SD, 57702 PHONE: (605) 348-7455 - FAX: (605) 348-7445 WWW.WESTPLAINGENCINEERING.COM RAPID CITY, SD - SIDUK PALLS, SD - GSPER, WY - CEDAR MAPLIDS, IA - BISMARCK, ND CO-OP PROJECT NO: 1936 PRELIMINARY NOT FOR CONSTRUCTION
	ISSUE: Issue Date Project Status REVISION SCHEDULE: REV. # REV. DSC. REV. DATE
	PROJECT: SDSMT DEVEREAUX LIBRARY PHASE 1 SOUTH DAKOTA SCHOOL OF MINES AND TECHNOLOGY
	RAPID CITY, SOUTH DAKOTA          SHEET TITLE:         SECOND FLOOR POWER PLAN
	E3.2

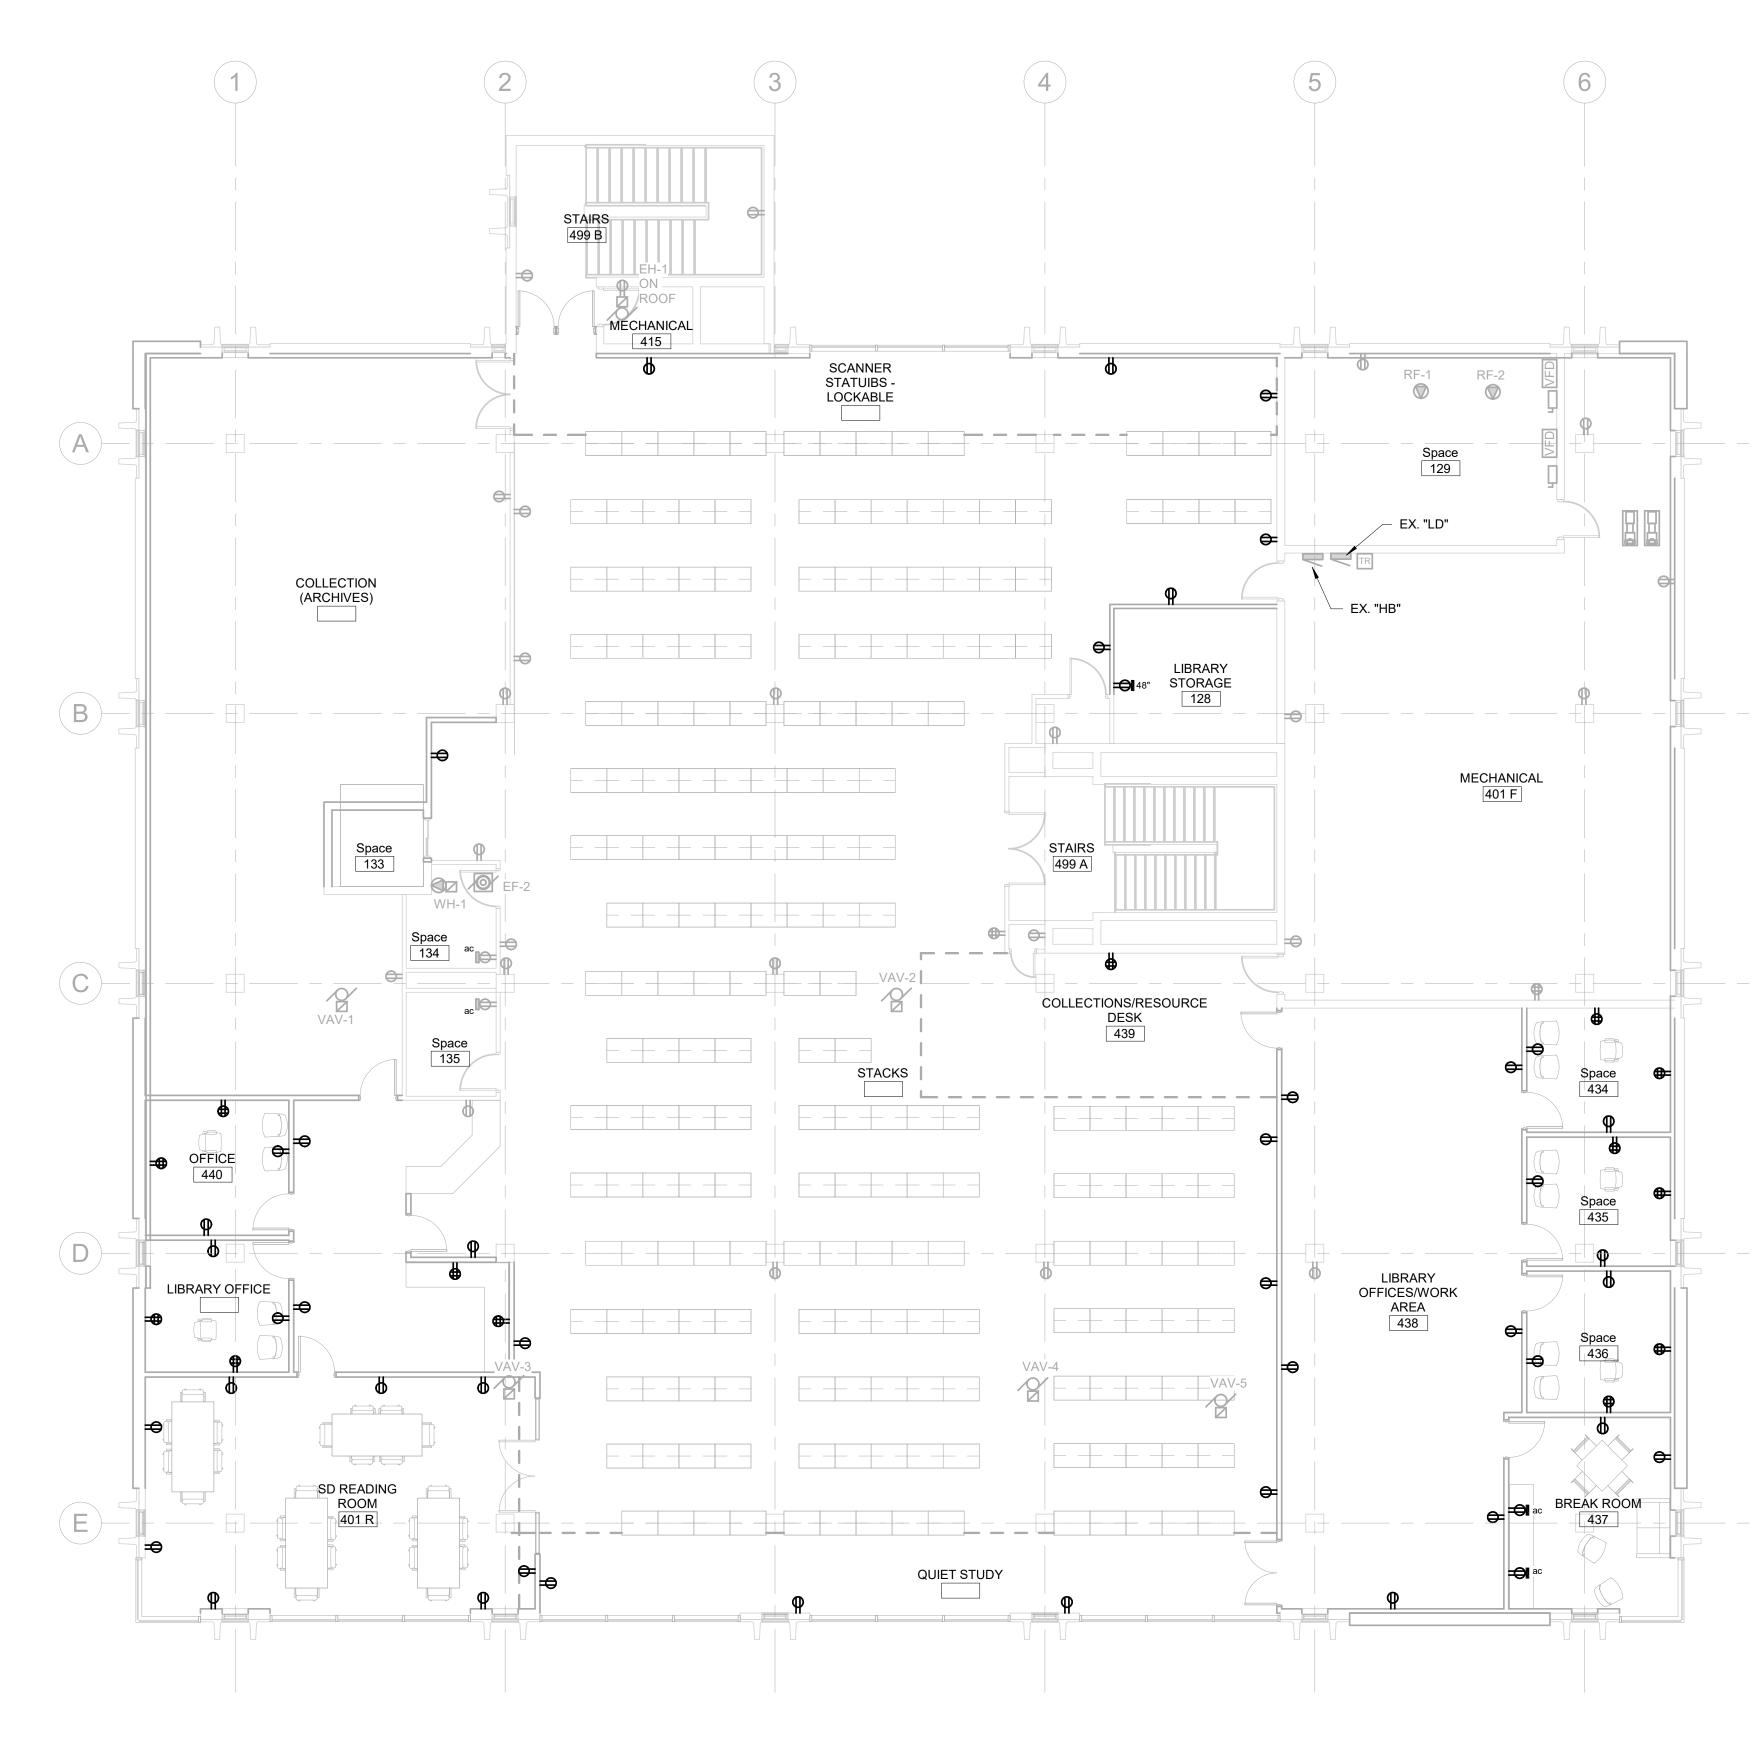




	CO Arch OP
ELECTRICAL MISCELLANEOUS NOTES A B C D	1108 S. Main St. 102 Aberdeen, SD 57401 Phone: 605-725-4852 601 Kansas City St. 7 Rapid City, SD 57701 Phone: 605-716-3652 300 N. Phillips Ave. 120 Sioux Falls, SD 57104 Phone: 605-334-9999 co-oparch.com
ELECTRICAL SPECIFIC NOTES	WERE BRISCISCO           WINNER BRISCO           STANDARD
	ISO RAND ROAD - RAPID CITY SD, 57702 HONE: (605) 348-7455 - FAX: (605) 348-9445 WIW WESTHANGENEINERENCOM MIDICITY SD - SOUX FALLS SD - GAPRY, W - CEDAR RAPIDS, IA - BISMARCK, ND CO-OP PROJECT NO: 1936 NO. 1936 NO. 1937 NO. 1937
	ISSUE: Issue Date Project Status REVISION SCHEDULE: REV. # REV. DSC. REV. DATE
	PROJECT: SDSMT DEVEREAUX LIBRARY PHASE 1 SOUTH DAKOTA SCHOOL OF MINES AND TECHNOLOGY RAPID CITY, SOUTH DAKOTA SHEET TITLE: THIRD FLOOR POWER PLAN <b>E3.3</b>

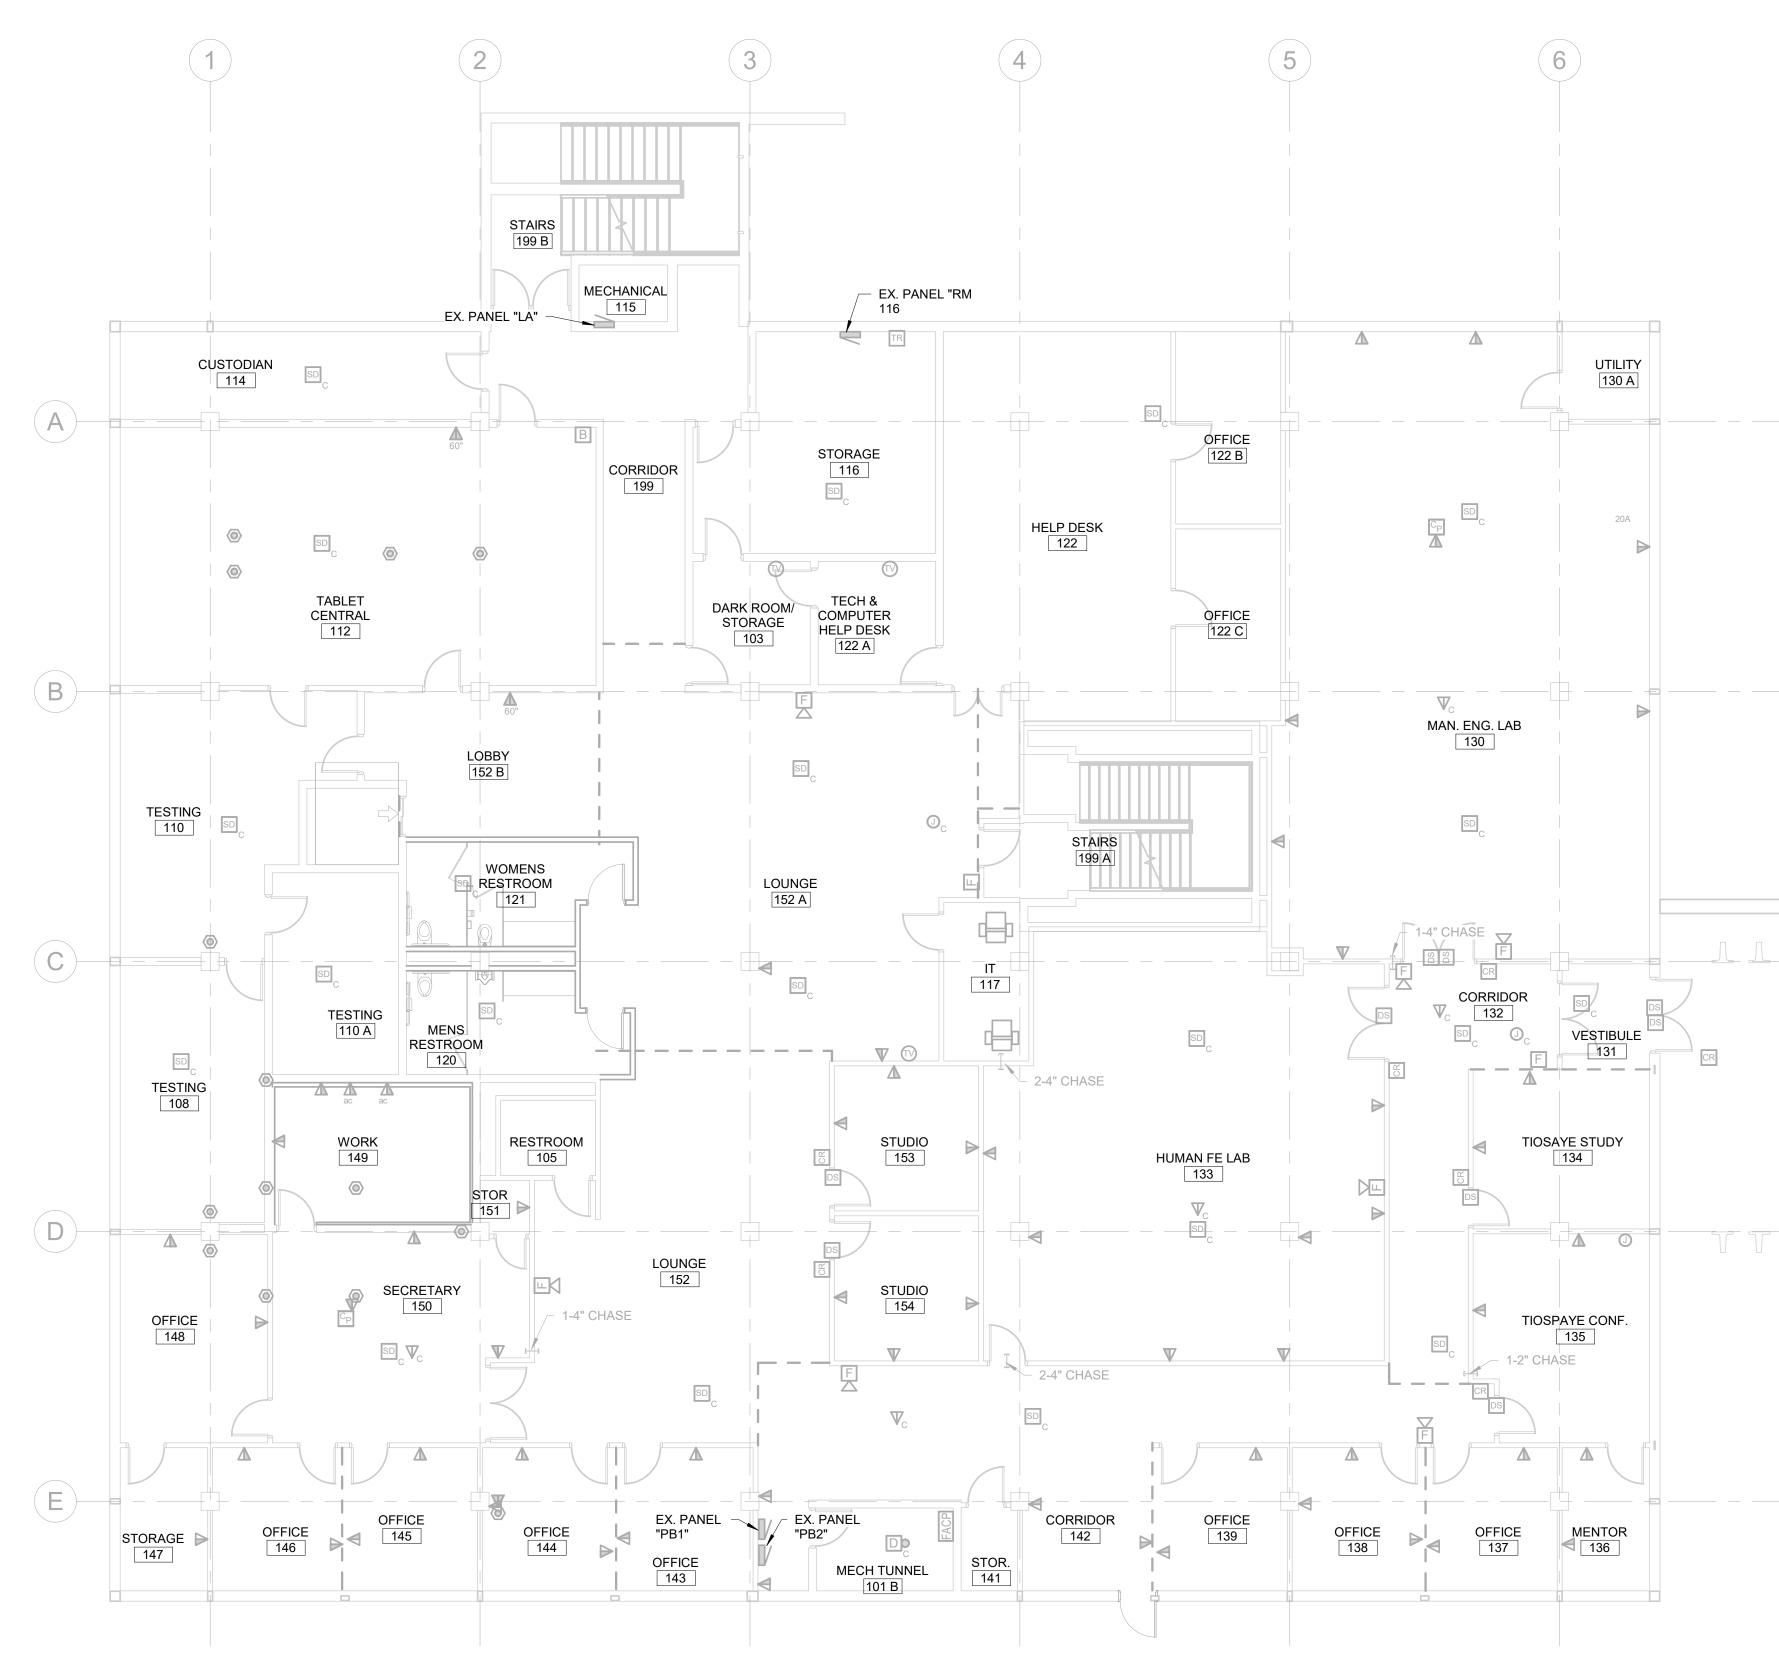




			CO Arch
El A B C D	ECTRICAL MISCELLANEOUS NOTES		1108 S. Main St. 102 Aberdeen, SD 57401 Phone: 605-725-4852 601 Kansas City St. 7 Rapid City, SD 57701 Phone: 605-716-3652 300 N. Phillips Ave. 120 Sioux Falls, SD 57104 Phone: 605-334-9999 co-oparch.com
#	ELECTRICAL SPECIFIC NOTES	— [	STRAN DESIGN SYNCHRONI
			811 East Washington Ave. 2 Madison, WI 53703 Phone: 608-276-9200 W238N1610 Busse Rd. 10 Waukesha, WI 53188 Phone: 262-875-6760 strang-inc.com
			WPE# BR190 WEF# BR190
			CO-OP PROJECT NO: PRELIMINARY NOT FOR CONSTRUCTION
			ISSUE: Issue Date Project Status REVISION SCHEDULE: REV. # REV. DSC. REV
			PROJECT: SDSMT DEVEREAUX LIBRA PHASE 1 SOUTH DAKOTA SCHOOL C MINES AND TECHNOLOGY RAPID CITY, SOUTH DAKOT
			<u>SHEET TITLE:</u> LOWER LEVEL SIGNAL PLA
			E4.0

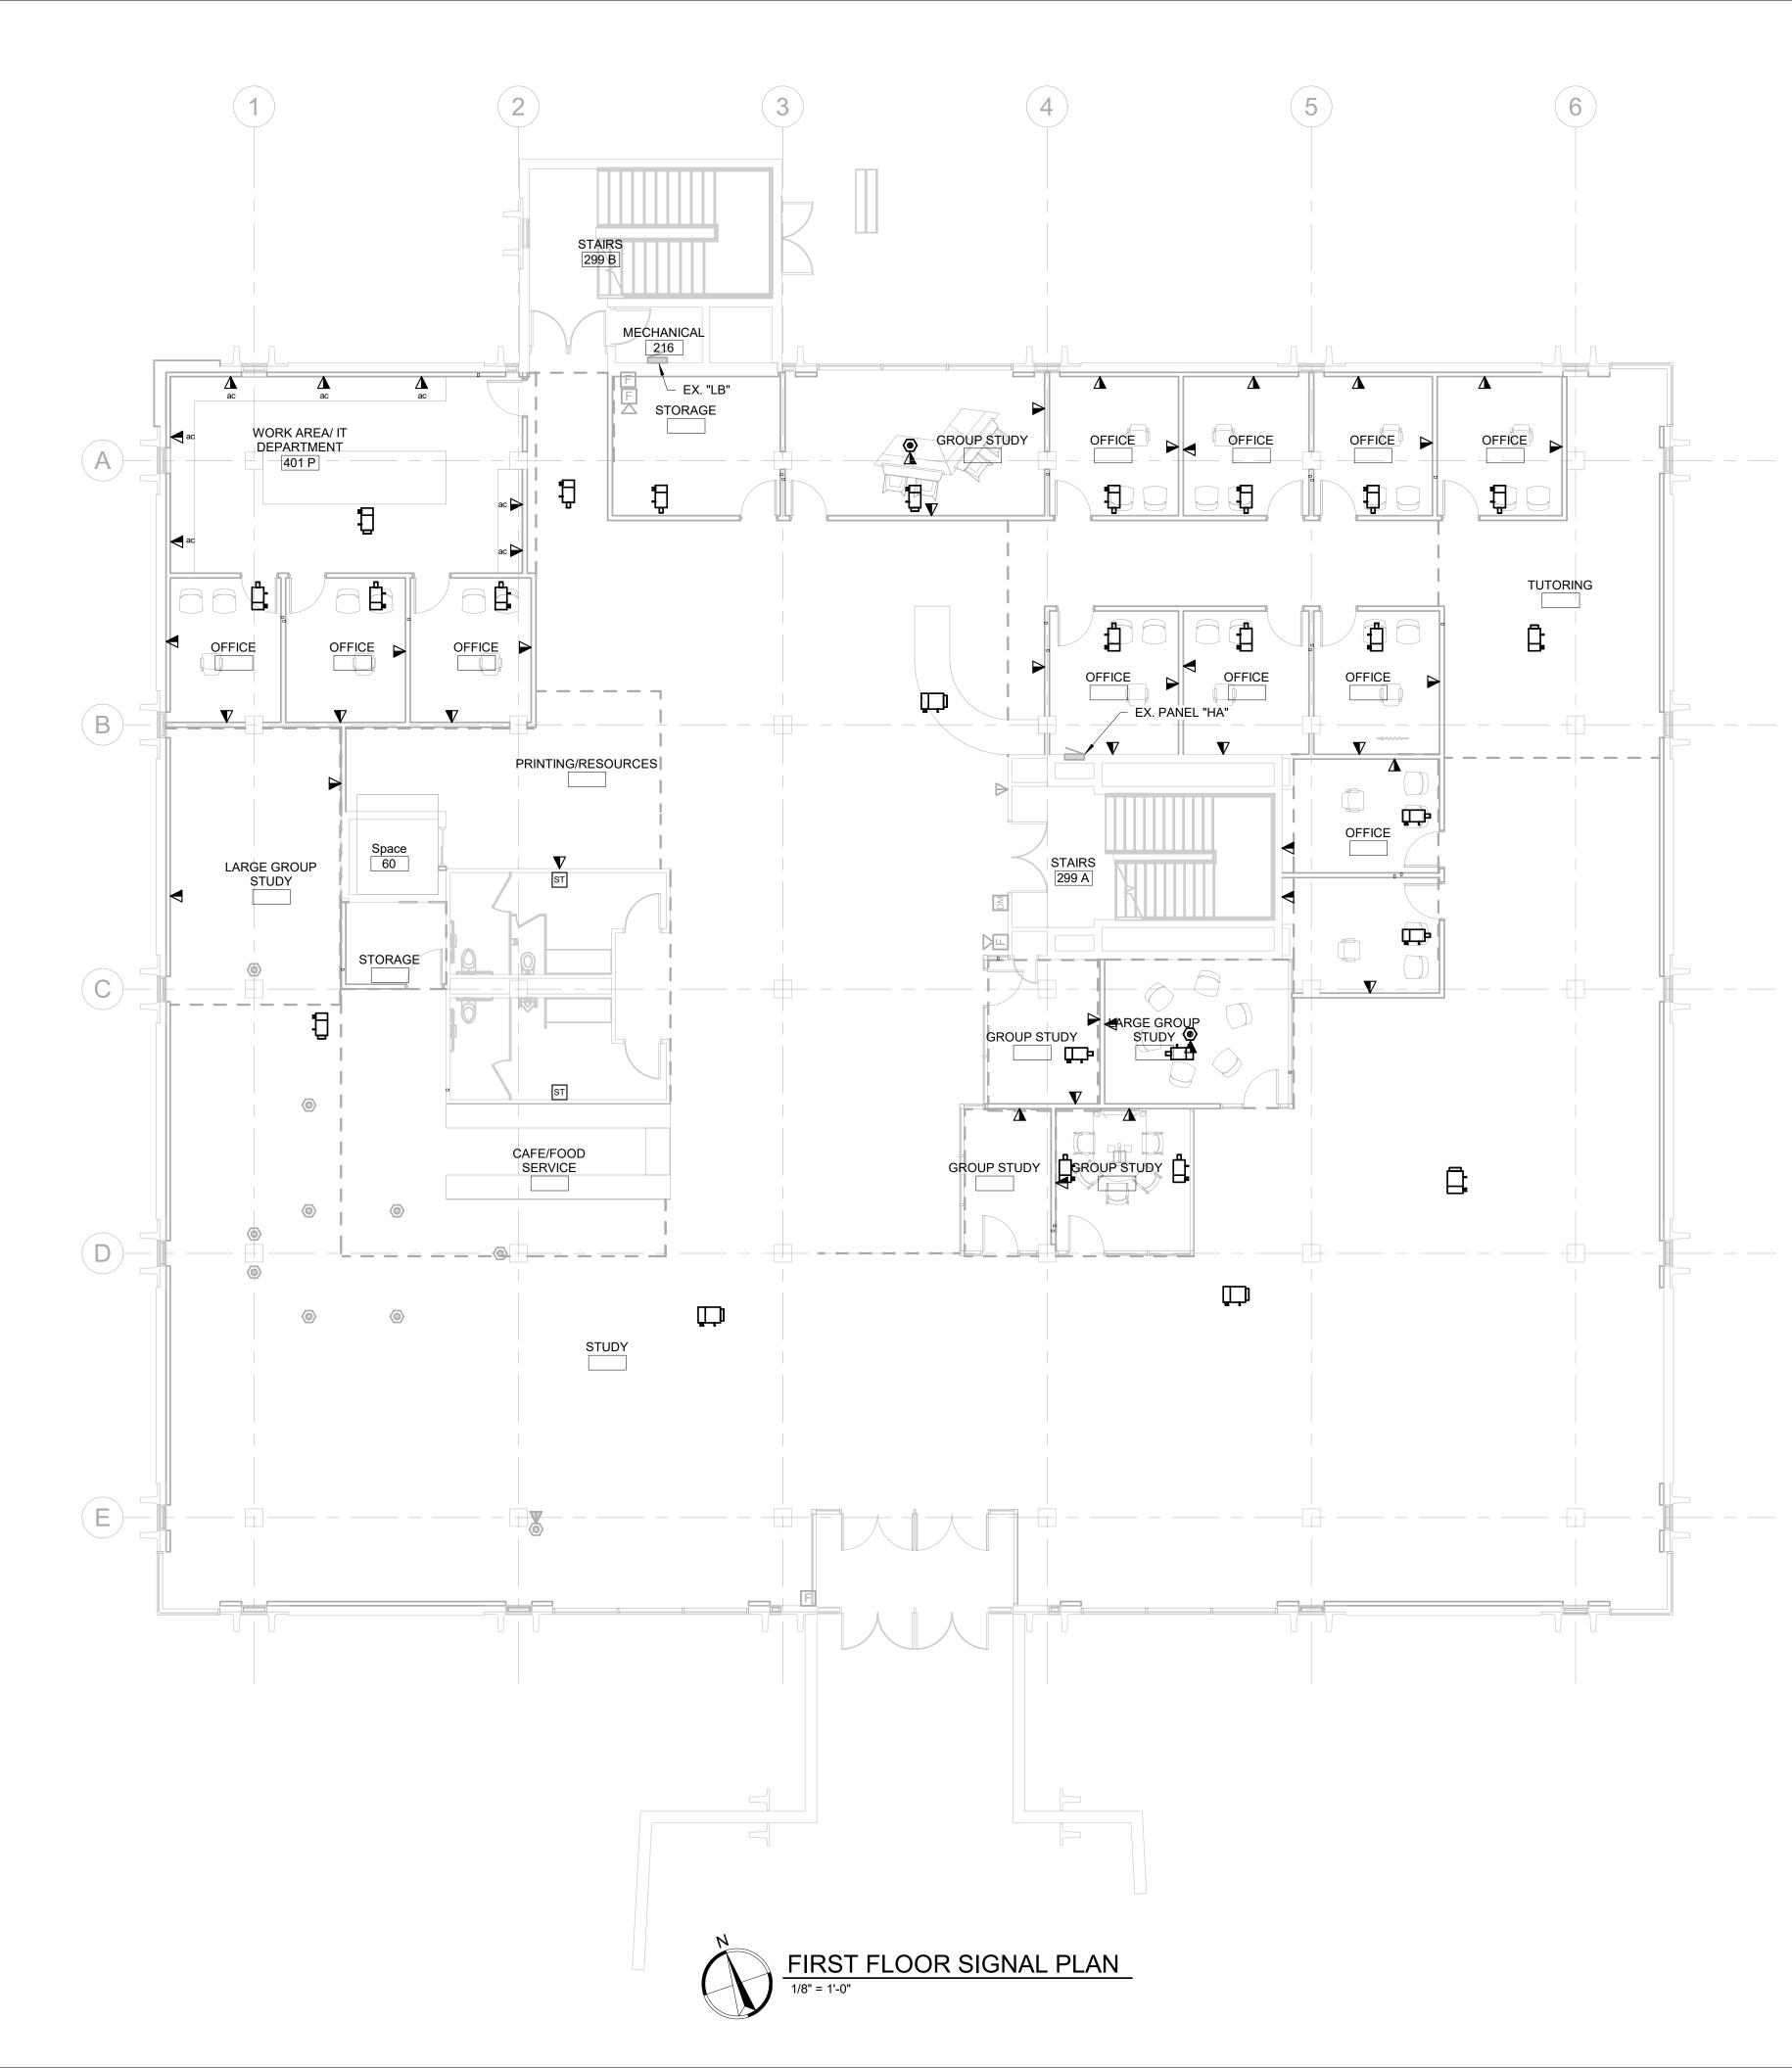



	CO
	Arch <b>OP</b>
ELECTRICAL MISCELLANEOUS NOTES	1108 S. Main St. 102 Aberdeen, SD 57401 Phone: 605-725-4852 601 Kansas City St. 7
A B C D	Rapid City, SD 57701 Phone: 605-716-3652 300 N. Phillips Ave. 120 Sioux Falls, SD 57104 Phone: 605-334-9999
# ELECTRICAL SPECIFIC NOTES	co-oparch.com
	STRANG DESIGN SYNCHRONICITY
	811 East Washington Ave. 200 Madison, WI 53703 Phone: 608-276-9200
	W238N1610 Busse Rd. 102 Waukesha, WI 53188 Phone: 262-875-6760 strang-inc.com
	WPE# BR19035 WEST PLAINS ENGINEERING. INC. 1750 RAND ROAD • RAPID CITY SD, 57702 PHONE: (605) 348-7455 + FAX: (605) 348-9445 WWW.WESTPLAINGENGINEERING.COM RAPID CITY, SD • SIDUX FALLS, SD • CASPER, WY • CEDAR RAPIDS, IA • BISMARCK, ND
	CO-OP PROJECT NO: 1936
	PRELIMINARY NOT FOR CONSTRUCTION
	ISSUE: Issue Date Project Status
	REVISION SCHEDULE: REV. # REV. DSC. REV. DATE
	PROJECT: SDSMT DEVEREAUX LIBRARY PHASE 1 SOUTH DAKOTA SCHOOL OF MINES AND TECHNOLOGY RAPID CITY, SOUTH DAKOTA
	<u>SHEET TITLE:</u> FIRST FLOOR SIGNAL PLAN
	E4.1

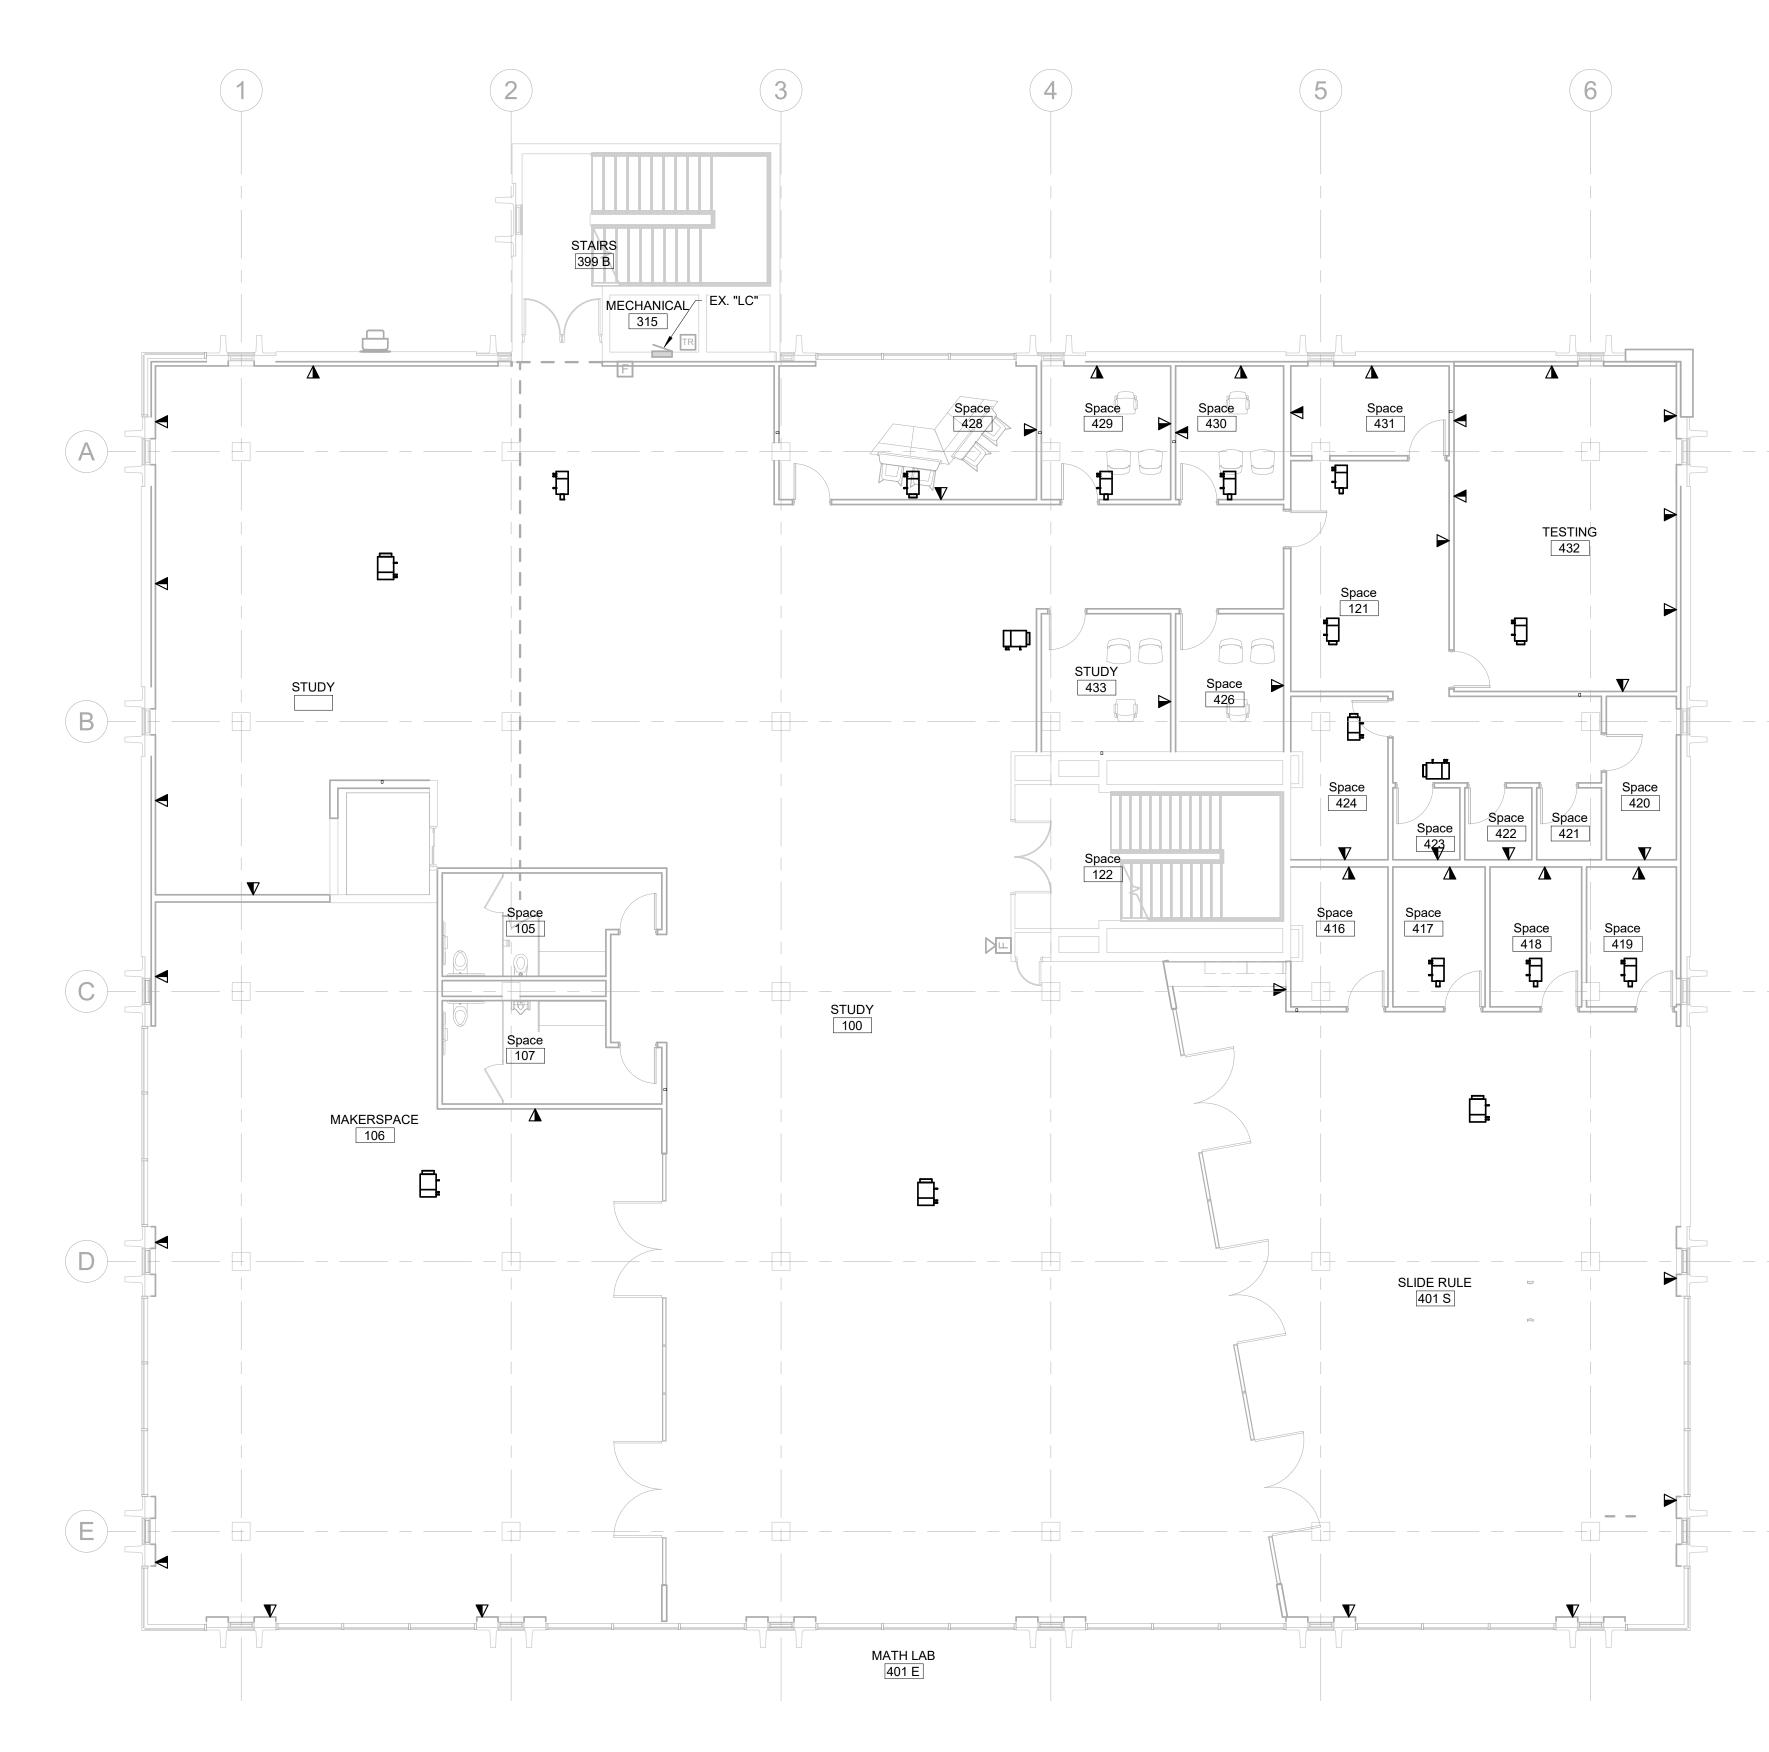



ELECTRICAL MISCELLANEOUS NOTES	COOArchOPJ108 S. Main St. 102Aberdeen, SD 57401Phone: 605-725-4852G01 Kansas City St. 7Apid City, SD 57701Phone: 605-716-3652J00 N. Phillips Ave. 120Sioux Falls, SD 57104Phone: 605-334-9999
ELECTRICAL SPECIFIC NOTES	co-oparch.com         strang-inc.com
	<text><text><text><text><text></text></text></text></text></text>
	ISSUE: Issue Date Project Status REVISION SCHEDULE: REV. # REV. DSC. REV. DATE PROJECT: SDSMT DEVEREAUX LIBRARY PHASE 1 SOUTH DAKOTA SCHOOL OF
	SOUTH DAKOTA SCHOOL OF MINES AND TECHNOLOGY RAPID CITY, SOUTH DAKOTA <u>SHEET TITLE:</u> SECOND FLOOR SIGNAL PLAN <b>E4.2</b>

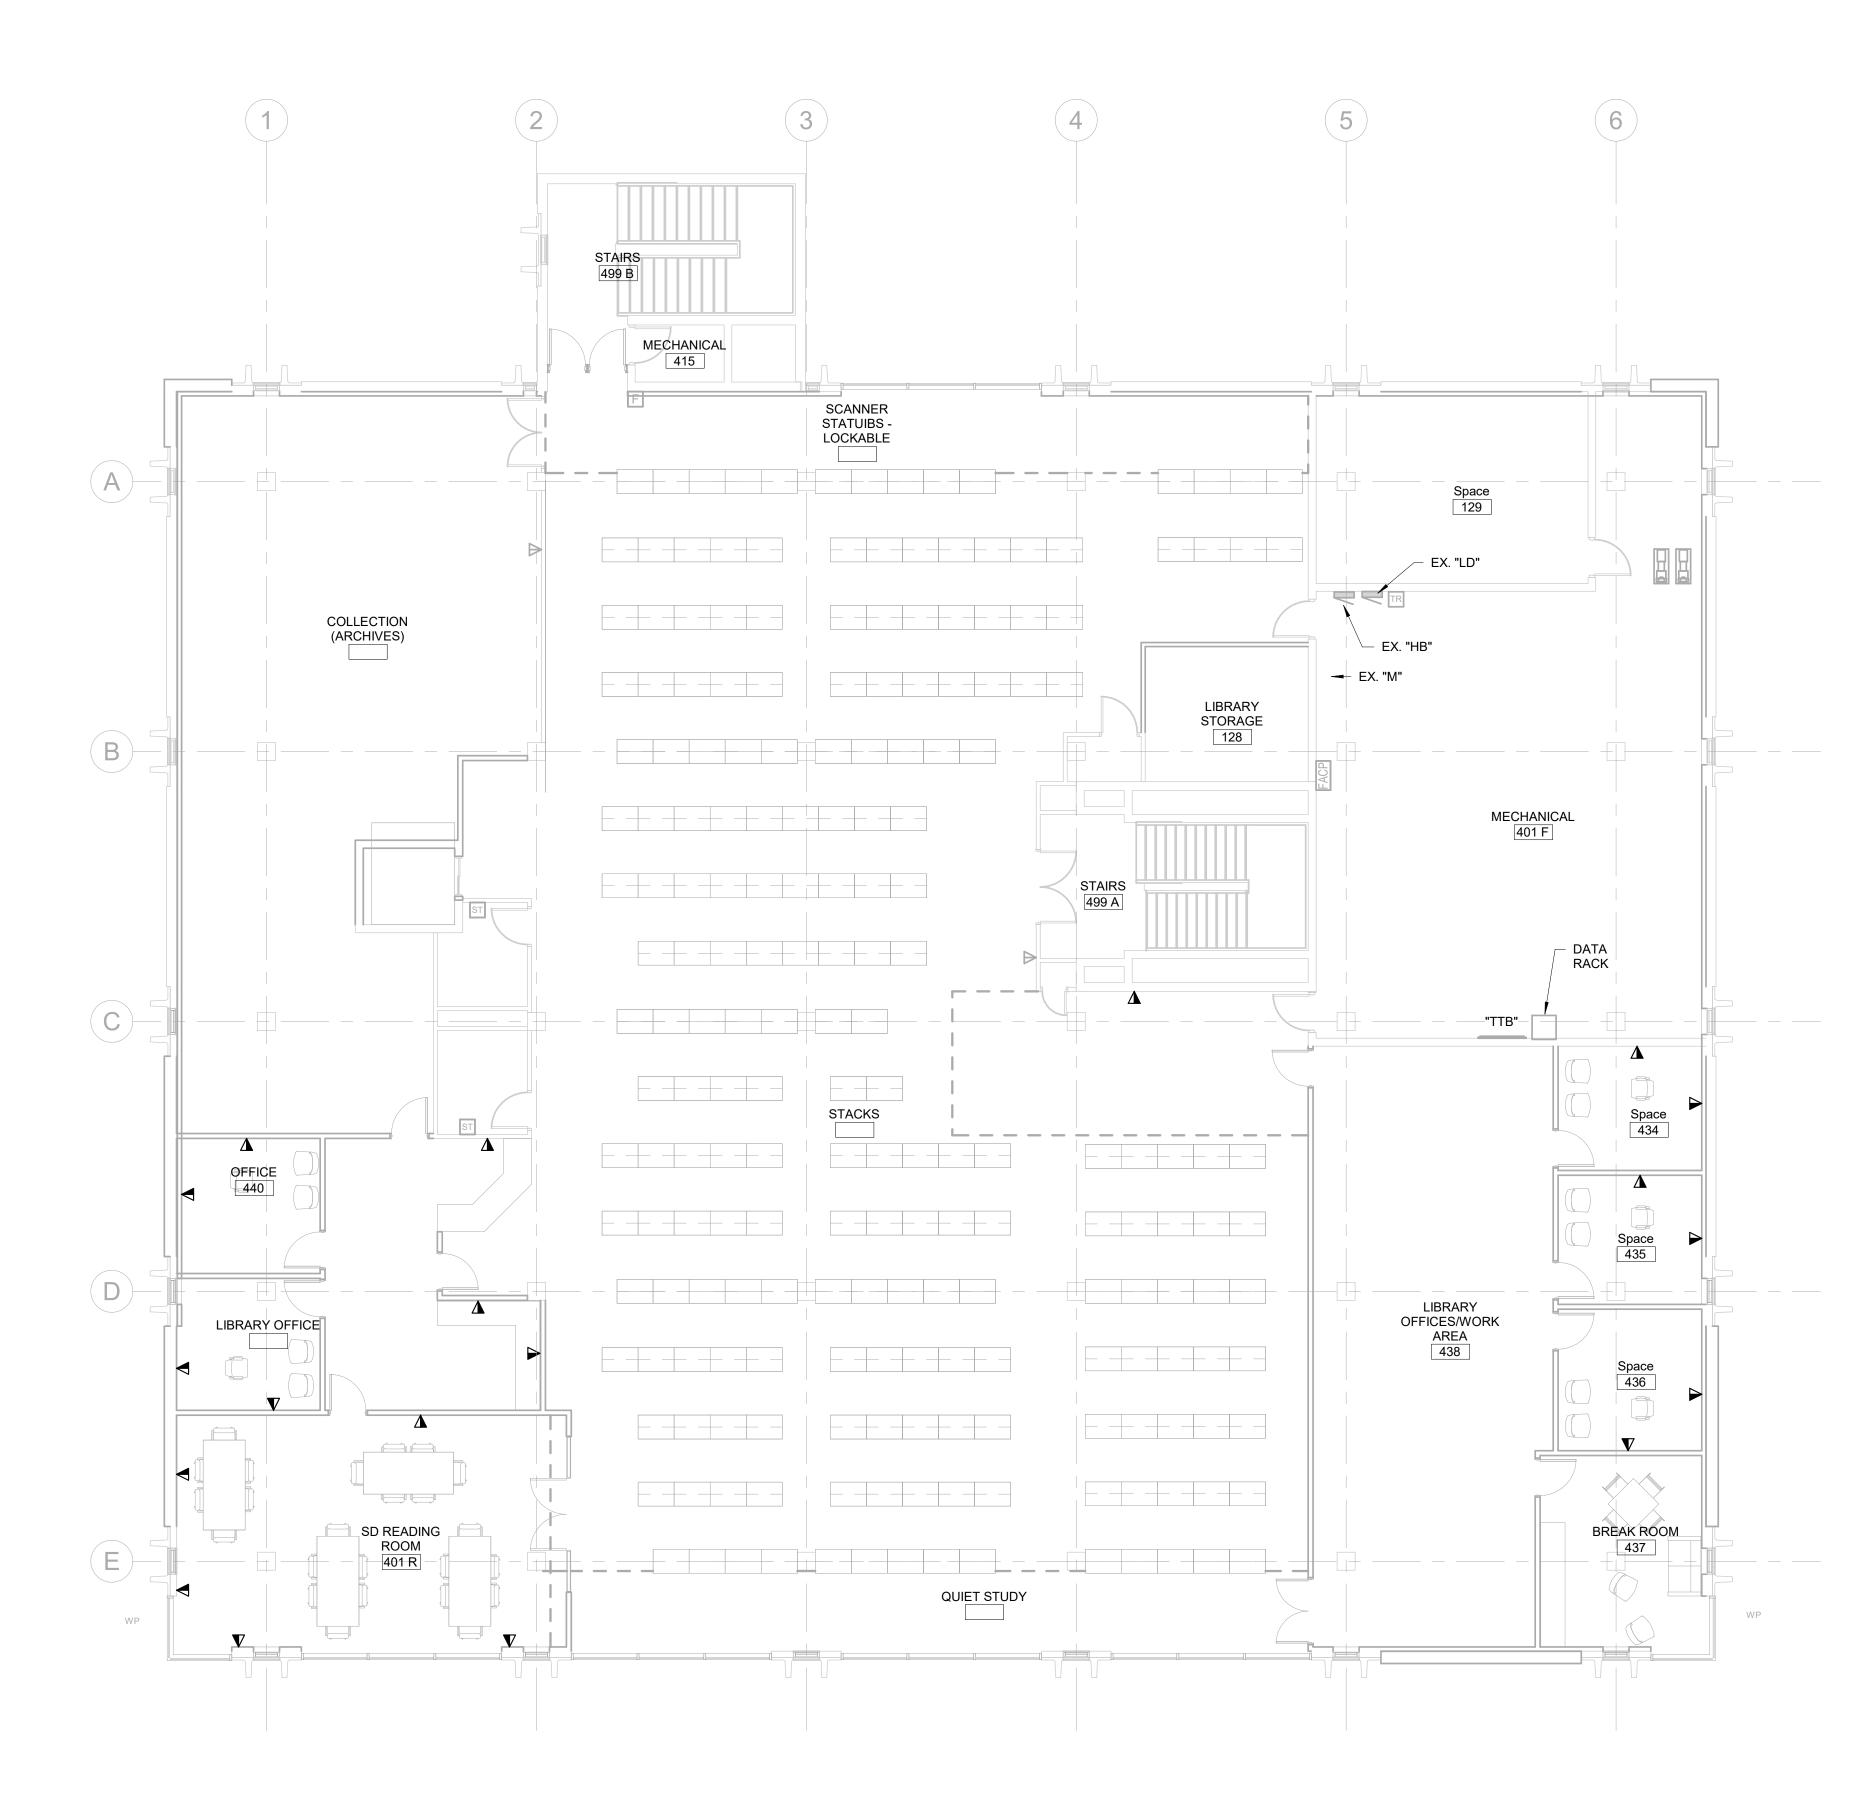

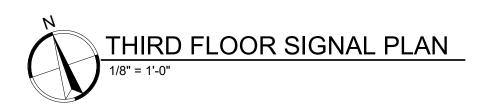

ELECTRICAL MISCELLANEOUS NOTES	CO         Arch       OP         1108 S. Main St. 102         Aberdeen, SD 57401         Phone: 605-725-4852         601 Kansas City St. 7         Rapid City, SD 57701         Phone: 605-716-3652         300 N. Phillips Ave. 120         Sioux Falls, SD 57104         Phone: 605-334-9999
	<image/> <text><text><text><text><text><text></text></text></text></text></text></text>
	CO-OP PROJECT NO: 1936 PRELIMINARY NOT FOR CONSTRUCTION
	ISSUE: Issue Date Project Status REVISION SCHEDULE: REV. # REV. DSC. REV. DATE PROJECT: SDSMT DEVEREAUX LIBRARY PHASE 1
	SOUTH DAKOTA SCHOOL OF MINES AND TECHNOLOGY RAPID CITY, SOUTH DAKOTA

# ELECTRICAL ABBREVIATIONS

	A STANDARD LIST. NOT ALL W	
A or AMP A/C A/E or AE ac AC ADA AFF AFG AFI or AFCI AHJ AHU AIC AL ANN AS AWG bc BC BC BH BL BRD or BD BUH C or COND C/B or CB CAT CCT or CKT	SEE SPECIFICATION SECTION "EQUIPMENT WIRIN AMPERE AIR CONDITIONING ARCHITECT & ENGINEER ABOVE COUNTER ALTERNATING CURRENT AMERICANS WITH DISABILITIES ACT ABOVE FINISH FLOOR ABOVE FINISH GRADE ARC FAULT CIRCUIT INTERRUPTER AUTHORITY HAVING JURISDICTION AIR HANDLING UNIT AMPERES INTERRUPTING CURRENT ALUMINUM ANNUNCIATOR AUTOMATIC SENSORS AMERICAN WIRE GAUGE BELOW COUNTER BELOW COUNTER BELOW COUNTER BELOW COUNTER BLEACHER ELECTRIC OPERATOR BOARD BLAST UNIT HEATER CONDUIT CIRCUIT BREAKER CATEGORY CIRCUIT	
CM CO COMB CONF CP CTC Cu or CU CU CU	CARBON MONOXIDE SENSOR CARBON MONOXIDE COMBINATION CONFERENCE CEILING PROJECTOR CABLE TERMINATION CABINET COPPER CONDENSING UNIT CABINET UNIT HEATER	
DC DC DP DISC DISP DL DN or DWN DR DW DWG	DIRECT CURRENT DISTRIBUTION CABINET DISTRIBUTION PANEL DISCONNECT DISPOSAL DOCK LEVELER DOWN DOOR DISHWASHER DRAWING	
EC EC EF EH ELEC EHD EM or EMERG EMT EUH EUH EWC EX EXP	ELECTRICAL CONTRACTOR ELECTRICAL CABINET EXHAUST FAN ELECTRICAL HEAT ELECTRIC OR ELECTRICAL ELECTRIC HAND DRYER EMERGENCY ELECTRICAL METALLIC TUBING ELECTRICAL NON-METALLIC TUBING ELECTRIC UNIT HEATER ELECTRIC WATER COOLER EXISTING EXPLOSION PROOF	
F or FUS FA FAAP FACP FBO FL, FLU or FLUOR FLA FVNR FVR	FUSE OR FUSIBLE FIRE ALARM FIRE ALARM ANNUNCIATOR PANEL FIRE ALARM CONTROL PANEL FURNISHED BY OTHERS FLUORESCENT FULL LOAD AMPERES FULL VOLTAGE, NON-REVERSING FULL VOLTAGE, REVERSING	
GC GD GEN GFI or GFCI GRC GND or GRND	GENERAL CONTRACTOR GARBAGE DISPOSAL GENERATOR GROUND FAULT CIRCUIT INTERRUPTER GALVANIZED RIGID CONDUIT GROUND	
H & AC H & V HA HD HID HP HPS HTG HTR HVAC HZ	HEATING & AIR CONDITIONING HEATING & VENTILATING HANDICAP ACCESS DOOR HAND DRYER HIGH INTENSITY DISCHARGE HORSE POWER HIGH PRESSURE SODIUM HEATING HEATER HEATER HEATING, VENTILATION & AIR CONDITIONING HERTZ (CYCLES/SEC)	
IC IGR IMC INC ISO J, JB or J-BOX KCMIL	INTERRUPTING CURRENT ISOLATED GROUND RECEPTACLE INTERMEDIATE METAL CONDUIT INCANDESCENT ISOLATED OR ISOLATION JUNCTION BOX THOUSAND CIRCULAR MILS	
KUMIL KV KVA KVAR KW KWH	KILOVOLT - AMPERE KILOVOLT - AMPERE KILOVOLT - AMPERE REACTIVE KILOWATT KILOWATT - HOUR	

S APPEAR IN THESE D	
OR ADDITIONAL INFOR	MATION AND REQUIREMENTS.
LA	LIGHTNING ARRESTOR
LT LTG	LIGHT LIGHTING
LTS	LIGHTING
MC	MECHANICAL CONTRACTOR
MCB MCC	MAIN CIRCUIT BREAKER MOTOR CONTROL CENTER
MCM	THOUSAND CIRCULAR MILS
MDP	MAIN DISTRIBUTION PANEL
MECH	MECHANICAL
MFS	MAIN FUSIBLE SWITCH
MH	METAL HALIDE
MLO MSB	MAIN LUG ONLY MAIN SWITCHBOARD
MTD	MOUNTED
MTS	MOTOR THERMAL SWITCH
MV	MERCURY VAPOR
MW	MICROWAVE
NA or N/A	NOT APPLICABLE
NC	NORMALLY CLOSED
NEC	NATIONAL ELECTRICAL CODE
NEMA	NATIONAL ELECTRICAL MANUFACTURERS ASSOCIAT
	NEUTRAL
NEU, NEUT or N NF	NON-FUSED
NL	NIGHT LIGHT
NO	NORMALLY OPEN
OFF, OF, or OFC OH	OFFICE OVERHEAD
OHD	OVERHEAD DOOR
P	POLE
	PUBLIC ADDRESS
PB PH	PUSH BUTTON PHASE
	PHASE PLUMBING
	PANEL
	PAIR
	POWER ROOF VENTILATOR
PS	PULL SWITCH
PS PTZ	PROJECTION SCREEN PAN TILT ZOOM
PVC	POLYVINYL CHLORIDE
PWR	POWER
RCP	REFLECTED CEILING PLAN
	RECEPTACLE
REF or REFRIG	REFRIGERATOR
	RADIANT HEAT
	RANGE HOOD
RLY RM	RELAY ROOM
RMS	ROOM ROOT MEAN SQUARE
SCC	SHORT CIRCUIT CURRENT
SD	SMOKE DETECTOR
SFR	SAFETY RECEPTACLE
SFTY SHLD	SAFETY SHIELD OR SHIELDED
SIG	SIGNAL
SMR	SURFACE MOUNT RACEWAY
SN	SOLID NEUTRAL
SP	SUMP PUMP
SPECS SPKR	SPECIFICATIONS SPEAKER
SPR	SPLIT WIRE RECEPTACLE
SW	SWITCH
SWBD	SWITCH BOARD
тс	TEMPERATURE CONTROL
	TELEPHONE CABINET
тсс	TEMPERATURE CONTROL CONTRACTOR
	TELEPHONE
TL TR, TRANS or TRFMR	TWIST LOCK TRANSFORMER
	TELEPHONE TERMINATION BOARD
TV	TELEVISION
TVSS	TRANSIENT VOLTAGE SURGE SUPPRESSION
TYP	TYPICAL
UG	UNDERGROUND
UH	
UV	UNIT VENTILATOR
V	VOLT
	VARIABLE FREQUENCY DRIVE
14/	14/4 77
	WATT WITH
	WITH
WP	WEATHERPROOF
WS	WINDOW SHADE
XFMR	TRANSFORMER
Y	WYE CONNECTION
φ	PHASE
Δ	DELTA

ELECTRICAL SYMBOLS	
THESE SYMBOLS COMPRISE A STANDARD LIST; NOT ALL SYMBOLS MAY APPEAR ON THIS PROJECT. ALL MOUNTING HEIGHTS ARE TO CENTER OF DEVICE ABOVE FINISHED FLOOR, MOUNTING HEIGHTS INDICATED ON ARCH. WALL ELEVATIONS ORAS NOTED SPECIFICALLY ON THE DRAWINGS OR IN THE SPECIFICATIONS SHALL TAKE PRECEDENCE OVER MOUNTING HEIGHTS LISTED BELOW.	
LIGHTING	
A Capital letter indicates sixture type. Small letter indicates sixture types). Capital letter indicates sixture types (Capital letter indicates sixture types). Capital letter indicates sixture types (Capital letter indicates sixture types). Capital letter indicates sixture types (Capital letter indicates sixture types). Capital letter indicates sixture types (Capital letter indicates sixture types). Capital letter indicates sixture types (Capital letter indicates sixture types). Capital letter indicates sixture types (Capital letter indicates sixture types). Capital letter indicates sixture types (Capital letter indicates sixture types). Capital letter indicates sixture types (Capital letter indicates sixture types). Capital letter indicates sixture types (Capital letter indicates sixture types). Capital letter indicates sixture types (Capital letter indicates sixture types). Capital le	Arch OP
Image: Mergency ceiling surface mount fixture       Image: Wall fixture mount fixture       Image: Wall fixture mount fixture       Image: Wall fixture mount fixture         Image: Wall fixture mount fixture       Image: Wall fixture mount fixture mount fixture       Image: Wall fixture mount fixture mount fixture       Image: Wall fixture mount fixtu	
• EMERGENCY WALL FIXTURE       • FOUR-WAY SWITCH (46" M.H.)       • FOUR-WAY SWITCH (46" M.H.)       • • • • • • • • • • • • • • • •	1108 S. Main St. 102
Image: Second	Aberdeen, SD 57401 Phone: 605-725-4852
EXTERIOR POLE LIGHT       TC       TIME CLOCK (60" M.H.)       \$D       DIMMER SWITCH (46" M.H.)         BOLLARD LIGHT       EMERGENCY LIGHTING W/BATTERY PACK       \$T       TIMER SWITCH (60" M.H.)	601 Kansas City St. 7
SURFACE MOUNT FIXTURE       Image: Surface mount fixture <t< td=""><td>Rapid City, SD 57701 Phone: 605-716-3652</td></t<>	Rapid City, SD 57701 Phone: 605-716-3652
POWER	300 N. Phillips Ave. 120 Sioux Falls, SD 57104
POWER	Phone: 605-334-9999
Image: Double push button station       Image: Junction box       Image: Radiant heat panel         Image: Image: Double push button station       Image: Public box       Image: Radiant heat panel         Image: Image: Double push button station       Image: Public box       Image: Baseboard or cove elec. heat	co-oparch.com
isolated ground receptacle (18" M.H.) MOTOR	•
<ul> <li>DUPLEX CONVENIENCE RECEPTACLE (18" M.H.)</li> <li>Disconnect switch</li> <li>SINGLE RECEPTACLE (18" M.H.)</li> <li>GAP GENERATOR ANNUNICIATOR PANEL</li> <li>MOTORIZED DAMPER</li> <li>DOUBLE DUPLEX CONVENIENCE RECEPTACLE</li> </ul>	
DOUBLE DUPLEX CONVENIENCE RECEPTACLE (18" M.H.)       AUTOMATIC TRANSFER SWITCH       Image: Bus duct         DOUBLE DUPLEX CONVENIENCE RECEPTACLE (18" M.H.)       Image: Bus duct       Image: Bus duct         Image:	STRANG
Split wired duplex receptacle (18" M.H)       VFD       COMBINATION VARIABLE FREQUENCY DRIVE DISCONNECT         Safety convenience receptacle       Magnetic starter	✓✔ DESIGN SYNCHRONICITY
POWER RECEPTACLE	811 East Washington Ave. 200
Image: Solution of the control of	Madison, WI 53703 Phone: 608-276-9200
Image: GFI DUPLEX CONVENIENCE RECEPTACLE       Image: GFI DUPLEX CONVENIENCE RECEPTACLE       ELECTRIC METER       EXISTING EQUIPMENT/CIRCUITING         Image: GFI DUPLEX CONVENIENCE RECEPTACLE       Image: GFI DUPLEX	W238N1610 Busse Rd. 102
Special purpose outlet or connection       Image: panelboard or load center       UGCONDUIT IN FLOOR OR UNDERGROUND         Image: panelboard or load center       Panelboard or load center       UGCONDUIT IN FLOOR OR UNDERGROUND         Image: panelboard or load center       Cord/plug       Image: panelboard or load center (existing to remain)	Waukesha, WI 53188 Phone: 262-875-6760
CIRCUIT BREAKER  CENTER (EXISTING TO REMAIN)  PNL-1,2,3  CONDUIT IN WALL OR CEILING SPACE, CROSS  MARKS INDICATE NUMBER OF WIRES, NO  MARKS INDICATE TWO WIRES. ARROWS INDICATE HOME RUNS TO PANEL. NUMBERS	strang-inc.com
CEILING DUPLEX RECEPTACLE CEILING DUPLEX RECEPTACLE FLUSH FLOOR DUPLEX RECEPTACLE FUSE	WPE# BR19035
Image: Book state of the s	1750 RAND ROAD • RAPID CITY SD, 57702
CP MULTI-SERVICE POLE (WITH DEVICES INDICATED) TELECOM	PHONE: (605) 348-7455 - FAX: (605) 348-9445 www.westuansekinieering.com rapid city, SD + Sioux Falls, SD + Casper, WY + Cedar Rapids, IA + BISMARCK, ND
SPECIAL EQUIPMENT CABINET-AS NOTED VINTERCOM VC CEILING MOUNT DATA OUTLET	CO-OP PROJECT NO: 1936
$\nabla^{W} \text{ wall Phone (46" M.H.)} \qquad \qquad$	
✓     DATA OUTLET (18" M.H.)     ◯     CEILING MOUNT TELEVISION OUTLET       FIRE ALARM	
F       FIRE ALARM MANUAL STATION (46" M.H.)       PS       PRESSURE SWITCH       V       CEILING MOUNT FIRE ALARM VOICE/STROBE         D       HEAT DETECTOR (RATE OF RISE)       TS       TAMPER SWITCH       H       MINI FIRE ALARM HORN	PRELIMINARY
Image: Description of the state of the	NOT FOR CONSTRUCTION
SD       UNITARY TYPE SMOKE DETECTOR       RA       REMOTE ANNUNICIATOR       SS       PROJECTION HORN         SD       SMOKE DETECTOR       DH       DOOR HOLDER       ST       FIRE ALARM STROBE (80" M.H.)	
SD → BEAM DETECTOR TRANSMITTER     MM     MONITOR MODULE     ST CEILING MOUNT FIRE ALARM STROBE       BD → BEAM DETECTOR TRANSMITTER     CM     CONTROL MODULE     CF     FIRE ALARM BELL (88" M.H.)	
BDK       BEAM DETECTOR RECEIVER       CH       FIRE ALARM CHIME/STROBE       C       COMBINATION FIRE/SMOKE DAMPER         RT       REMOTE TEST STATION       FF       FIRE ALARM HORN/STROBE (80"M.H)       FAAP       FIRE ALARM ANNUNCIATOR PANEL	1
HS COMB HEAT/SMOKE DETECTOR CEILING MOUNT FIRE ALARM HORN/STROBE FACP FIRE ALARM CONTROL PANEL	ISSUE:
FS       FLOW SWITCH       ↓       <	Issue Date Project Status
SOUND AND SECURITY         S       FLUSH SPEAKER       SURVEILLANCE VIDEO CAMERA - PTZ       DS       ALARM DOOR SWITCH	REVISION SCHEDULE: REV. # REV. DSC. REV. DATE
S     Surface speaker     VM     Surveillance video Monitor     DR     Door Release Mechanism       SX     PAGING HORN     VR     Surveillance video Recorder     MD     Alarm Motion Detector	
COLUME CONTROL (46" M.H.)     VS     SURVEILLANCE VIDEO SWITCHER     SP     ALARM SHUNT PAD	
M       MICROPHONE OUTLET (18" M.H.)       ACP       ALARM CONTROL PANEL       KP       ALARM KEYPAD         AUX       AUXILIARY OUTLET       BAA       BURGLAR ALARM ANNUNCIATOR       CA       CARD ACCESS	
AMP       AMPLIFIER       ANTENNA (AS NOTED)       IC       SECURITY INTERCOM (54" M.H.)         SURVEILLANCE VIDEO CAMERA       AS       ALARM PANIC SWITCH       RX       REQUEST EXIT PUSH BUTTON	-
CEILING MOUNTED SURVEILLANCE	PROJECT:
CLOCKS AND BELLS	SDSMT DEVEREAUX LIBRARY PHASE 1 SOUTH DAKOTA SCHOOL OF
DOUBLE FACE CLOCK	MINES AND TECHNOLOGY RAPID CITY, SOUTH DAKOTA

<u>SHEET TITLE:</u> ELECTRICAL DETAILS & SCHEDULES

E5.0

SDSM&T Devereaux Library Building Assessment Rapid City, SD OSE# WPE # BR19035

November 03, 2020

#### **Electrical Assessment**

#### 1.1 Interior Lighting

The 1<sup>st</sup> and 2<sup>nd</sup> floor interior lighting consists of a mix of 32 watt T8 fluorescent light fixtures with some 17 watt T8 light fixtures and some recessed incandescent light fixtures. The light fixtures were upgraded to T8 lamps from the old 40 watt T12 lamps that were originally installed in the building. The majority of the light fixtures on these floors are single lamp fixtures with an acrylic lens. These light fixtures are recessed into the ceiling construction. Light fixtures in other support spaces are a recessed acrylic lensed troffer type. Lighting in the entry/lobby area consists of 4 foot by 4 foot recessed fixtures with some recessed incandescent can lights. The light fixtures are provided with minimal controllability. The lighting in the collections areas are controlled via lighting relay panels on each floor and switched from a multiple switch bank in a single location on each floor. The rest of the lighting on these floors is controlled on a room by room basis via wall switches. Exit signs appear at egress points but the majority of them are not an LED energy efficient type. Very little emergency lighting is provided for egress needs. Where emergency lighting is provided, it is by way of wall mounted "bug eye" style fixtures which do not effectively provide egress lighting through stacks.

The interior lighting on the 3<sup>rd</sup> floor consists of a mixture of 32 watt T8 and 54 watt T5HO fluorescent light fixtures. The light fixtures were upgraded as part of a renovation project that took place in 2004. The light fixtures on this floor consist of rows of 45 watt T5HO, linear, indirect, pendant lights that are located over the collections and study areas. Light fixtures in the archives area are a recessed, acrylic lensed fixture type. The light fixtures in the mechanical spaces are still original fixtures to the building but have been upgrade to 32 watt, T8 lamps. The lighting in the collections/study areas are controlled via a wall switch located next to the stairs. The rest of the lighting on this floor is controlled on a room by room basis via wall switches. Exit signs appear at egress points and are an LED energy efficient type. These exits signs were installed during the 2004 project. Emergency lighting is provided via specific light fixtures that are furnished with emergency ballasts and battery packs.

The interior lighting in the basement consists of 28 watt T5 fluorescent light fixtures and LED exit signage. The basement lighting was installed new during the Industrial Engineering Renovation project that was completed in 2016. Emergency egress lighting is accomplished on this floor via specific light fixtures that are furnished with emergency ballasts and battery packs. Occupancy sensors are provided throughout much of the office, corridor, lobby, and lab spaces. Multilevel switching lighting control is also provided throughout a majority of the offices and lab spaces.

Most of the lighting on the 1st and the 2nd floor is dated and not consistent with the needs of the facility and it is our recommendation that it be replaced. General lighting shall be replaced with newer more energy efficient LED light fixtures. Occupancy sensors shall be provided to control the lights at restrooms and offices to also save on energy costs. The library has expressed dissatisfaction with the linear pendant style light fixtures on the 3rd floor that are above the collections/study areas. These linear pendant light fixtures shall be replaced with new 2x2 recessed style light fixtures in accordance with the school's lighting standards. The basement lighting is in good working condition. Although not

necessarily needed; If the school wishes, the lighting could be changed out to new, more energy efficient LED type fixtures. Appropriate egress lighting shall be provided throughout the building. All exit signs will be upgraded to new LED style exit signs to provide energy savings. All new lighting shall be in accordance with ASHRAE 90.1 (Energy Standards for Buildings). Section 9 outlines lighting standards to assist in energy efficient design. It is not anticipated that LEED will be pursued on this project; however, if LEED is pursued a lighting control system with daylight harvesting will be provided for the project.

### **1.2 Electrical Service**

The existing building is served by an 800Amp, 480Y/277Volt, three-phase, 4-wire electrical service. The service is fed by an underground feeder originating from a pad-mount transformer, located outside of the building. The electrical service consists of an exterior main service disconnect switch that feeds a main switchboard with fused switches located on the third floor. The switchboard appears to be original to the building. There are several branch circuit panelboards, located at each floor, throughout the building that are also of a similar age as that of the main switchboard.

The main switchboard and branch circuit panelboards that are serving the facility are old and at end of life. Parts are hard to find. If a failure was to occur, there could be significant down time while searching for replacement parts. The main switchboard and older branch circuit panelboards shall be replaced. The new main switchboard shall be a circuit breaker type and fully coordinated for arc fault with downstream branch circuit panelboards it will be serving. New branch circuit panelboards shall be provided as circuit breaker type. All new power distribution feeders shall consist of copper conductors in metallic conduit.

## 1.3 Branch Circuiting/Loads

With exception to the basement level, most of the branch wiring, wiring devices, and raceway systems appear to be of similar age as the building. There have been additional wiring devices and circuits added over the years utilizing surface raceway. Many of the wiring devices in the basement area were installed new during the Industrial Engineering Renovation project that was completed in 2016. The majority of the existing branch wiring, wiring devices, and raceway systems appear in fair condition.

Additional branch circuits for general purpose receptacles, computer workstations will be added to any renovated spaces. This will provide the occupants with the needed power for their day to day activities. The design of any remodeled areas will be worked out in conjunction with the occupants so that their electrical needs are being met. Branch circuit wiring shall be by way of copper conductors in metallic conduit. Minimum wire size shall be 12 AWG for 20A circuits. Circuits longer that 75 feet shall have the conductors' upsized in order to reduce voltage drop at devices served. All circuits will include a dedicated equipment grounding conductor pulled with the current carrying conductors. Dedicated neutral will be provided for all single pole circuit breakers to meet new code requirements. It is not anticipated that LEED will be pursued on this project; however, if LEED is pursued receptacle plug load control will be provided that will control 50% or more of all 120 volt receptacles by an automatic control

device. This is typically accomplished via a time of day controller, occupant sensor, or a signal from another control or alarm that indicates the area is unoccupied.

### 1.4 Food Service – Einstein Bagels

The library is being provided with a new food service program, Einstein Bagels. The electrical design shall plan for the electrical installation of the food service equipment, lighting, communications, and specific systems in accordance with the Einstein Bagels standards and requirements. A dedicated electrical branch circuit panelboard is planned to be provided for this area to power the new food service equipment. New GFCI type receptacles shall be provided in kitchen and food preparation space.

#### 1.5 Special Systems

The buildings communication cabling appears to be in fair condition for the use of the facility. Additional communications jacks have been added as well as wireless access points.

Additional communications rough-in and wiring shall be installed to provide for any renovated space. Offices, work areas, and conference rooms shall be furnished with new telephone and data jacks to provide for the occupant's requirements. New telecommunications cabling will be plenum rated CAT 6 cable matching the school's standards for cabling. As such all new connectivity equipment such as switches and patch panels shall also be specified as CAT 6 compliant. Cabling shall be ran utilizing open wiring methods such as cable tray, and j-hooks above accessible ceiling spaces. If no accessible ceiling is provided, cabling shall be routed back to the communications closets in conduit.

The building is equipped with a fire alarm system that covers the majority of the building with automatic detection. The basement level is equipped with fire alarm devices that were installed as new during the Industrial Engineering Renovation project that was completed in 2016. Manual pull stations have been provided at the exits and the fire alarm notification has been provided by horn/strobes. The fire alarm control panel is located on the third floor and is an intelligent, addressable panel that was installed approximately fifteen years ago.

Existing fire alarm devices will be removed and new fire alarm devices will be added to allow for the renovated and reorganized spaces throughout the first, second, and third floors. New notification devices will be provided throughout to meet decibel and visual requirements per code.

Electrical rough-in shall be provided at doors for new access control devices. Electrical rough-in shall be provided in the form of electrical boxes and conduit in the wall for card readers, and conduit stubbed into the door frames for door switches and electric strikes. These doors shall be identified and coordinated with the school for exact locations.

## **Mechanical Study**

#### 2.0: Plumbing System

The majority of the plumbing systems in the Devereaux Library have remained untouched since it was built in 1968. There have been minor modifications to the bathrooms on first, second, and fourth floors have brought parts of the facility up to current ADA standards. As the building has a flat roof, the building utilizes roof drains and storm drain piping.

The majority of the sanitary and domestic piping within the facility are original to the building and are approximately fifty-one years old. In areas where the piping is accessible, the domestic, sanitary, and storm system, shall be replaced.

#### 2.1: Hydronic System

The original heating hydronic system serving the Devereaux Library was a steam to heating water converter that utilized steam from the central plant. The facility also originally had an absorption chiller that utilized the steam central plant heat and a fluid cooler located in the penthouse to produce chilled water. The heating system has remained relatively unchanged with a few heating devices being changed out. The chilled water system was converted over to an air cooled chiller part way through the life of the library and in 2004 was added to the chilled water central plant.

The majority of the heating and chilled water piping within the facility are original to the building and are approximately fifty-one years old. The hydronic pumps are making a significant amount of noise when operating. The piping (where accessible within the remodeled areas), steam heat exchanger, and pumps shall be replaced as part of this project.

#### 2.2: HVAC System

The HVAC system in the Devereaux Library was originally a high pressure constant volume reheat system with a large built up air handling unit on third floor. Heating was provided by high pressure reheat boxes with zone control thermostats in the basement, first, and second floors. The reheat boxes are essentially a box with a hot water coil that tempers the air delivered to the space. The third floor was originally heated by hot water unit heaters. Throughout the years, the building and HVAC system have been modified extensively *s*. Prior to 2004, a VFD was added to the AHU supply fan to reduce some overall fan energy. In 2004, return fans with VFDs were added the building. The independent return fans, one serving the basement and first while the other serves second and third floors, were added to help control building pressurization issues. At the same time, series fan powered VAV boxes were added in the remodel of the third floor. This allowed the VFD on the supply fan to modulate to maintain airflow while providing for some energy reduction. In 2010, an energy conservation project added VAV shut off style boxes before each reheat box on the basement, first and second floors. This allowed even greater energy efficiencies.

The air handling unit's centrifugal supply fan installation is not ideal. The unit is a large 50 HP unit that discharges vertically. Typically a section of ductwork 2-1/2 times the outlet diameter is suggested for reduce loss from turbulence. The unit discharges vertically with a minimal amount of ductwork. This installation has remained unchanged from its initial install in 1968. This fan will be replaced with a dual plug/plenum fans.

The building has a unique HVAC supply and return duct system. Each floor except the third has a continuous lighting grid with built in return slots. Supply diffusers are installed in the lighting grid dividers. This is a built in place system that complicates maintenance. As part of this project, the ceiling grid will be replaced with a more standard system and new diffusers will be installed.

The library was built in 1968. So the existing air handler and high pressure reheat boxes are fifty-one years old. Surprisingly, the maintenance staff has reported that the existing system is relatively problem free. The VAV system will be upgraded in areas where work will be occurring.

#### 2.3 Food Service – Einstein Bagels

The library is being provided with a new food service program, Einstein Bagels. The mechanical design shall plan for the plumbing and HVAC installation of the food service equipment in accordance with the Einstein Bagels standards and requirements.